


TAX PARCEL



FLOOD ZONE MAP FEMA NFHL (NATIONAL FLOOD HAZARD LAYER) VIEWER

AREA OF MINIMAL FLOOD HAZARD

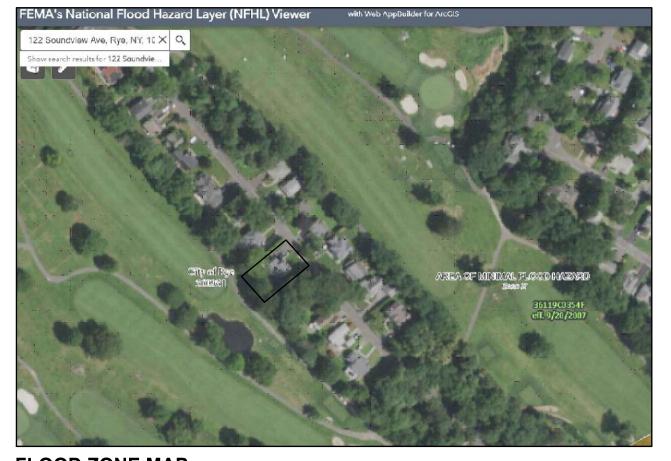

STORM DAMAGE IS AT TARPED OFF AREA AT LEFT FRONT AND GABLE

WESTCHESTER COUNTY GEOGRAPHIC INFORMATION SYSTEMS

CITY OF RYE

Now or Formerly Rye Wood Country Club Inc N 29°28'00" W 75.00' Stone Tax Lot (Lot) (56) /Lot 58 59 , 57 < 55_/ Tax lagston:e Walk Flagston: Lot 87 Lot 85 Wood Djeck Wood Deck 2 1/2 Story Frame (House # 122) \$ 29°43'00" E 75.00' 🐯 N-On Line — 🤀 E-14.3° Edge of Blacktop CERTIFIED TO: GEORGIO DEVELOPMENT 1 LLC, ROBERT GEORGIO & JOSEPH KENNEDY FAIRFIELD COUNTY BANK, ROUND HILL TITLE AGENCY, INC. JOHANNA AND NATHAN CAMPBELL FUTURE TITLE COMPANY THOROUGHBRED MORTGAGE, LLC January 21, 2010 Certification added April 16, 2010 N. Y.S. License 50054-2 Brought to date Dec. 6, 2010 LEWICE CIVE, INC. Additional Certification added February 9, 2011 10523 Scale 1"=15'

PROPERTY INFORMATION:

122 Soundview Avenue Street Address: Rye, NY 10580

0.18 Acres Property Area:

Sheet 153.06 Block 3 Lot 86 Tax Map Designation: Zoning District: R-5 Single-Family Residence Single-Family Residence Current Use:

Proposed Use: No Change; Single-Family Residence Flood Insurance Zone: FEMA Zone X - Not in 500-Year Flood Zone

PROJECT DESCRIPTION:

Repair of damage from tree impact:

Remove and replace damaged structural and non-structural framing including walls, floors, roof and ceilings; Remove and replace exterior siding and trim; Remove and replace damaged interior wall and ceiling coverings (drywall), flooring, millwork, trim and finishes; Remove and replace or reinstate finishes and materials affected by moisture intrusion.

REGULATORY COMPLIANCE:

Flood Zone: The property is not located in a Flood Zone

The property is not a protected structure and is Protected Structure: not located within a Preservation District

Coastal Boundary: The property is not located within a designated Coastal Boundary

Wetland: The property is not located within 1000 feet of a

wetland

Site Runoff: The project will not involve the disturbance of more that 300 S.F. of land

Tree Romoval: No tree removal is proposed

Signage: No signage is proposed

Exterior Appearance: There will be no change to the exterior appearance of the structure - from its pre-damage condition.

ZONING COMPLIANCE:

This is a minor repair - to pre-damage condition - of an existing structure. There will be no change to those dimensions regulated in *Table A Residence*

Districts of the Zoning Code of the City of Rye: Min Lot Area: No Change

Floor Area Ratio: No Change Front Yard: No Change Side Yard(s): No Change No Change Rear Yard: Height in Stories: No Change

Height in Feet: No Change Accessory Structures: Not Applicable

JURISDICTION AND CODES:

COMPLIANCE

J-14430 FOL-23

The Authority having Jurisdiction is the City of Rye. Per the the *Residential* Code of New York State, the Uniform Code shall be administered and enforced by the authority having jurisdiction.

All work shall be in accordance with the *The local laws, ordinances and* resolutions of the City of Rye known collectively as the "Code of the City of Rye", the 2020 edition of the Residential Code of New York State, and any other code or regulation having jurisdiction.

APPLICABLE CODES:

The following codes apply.

2020 Residential Code of New York State (IRC 2018 with amendments)

2020 Building Code of New York State (IBC 2018 with amendments)

2020 Energy Conservation Code of New York State (IECC 2018 with amendments)

2020 Mechanical Code of New York State (IECC 2018 with amendments)

National Electric Code (NFPA 70)

Parts of the codes are cited below, and in other areas in this document.

PERMITS AND INSPECTIONS:

Per [NY] R105.2 Building Permit

No person or entity shall commence, perform, or continue any work that must conform with the Uniform Code and/or Energy Code unless:

Such person or entity has applied to the authority having jurisdiction for a building permit: And the authority has issued a building permit authorizing such work.

Per City of Rye Code, Section 68-8 D. (4)

All building and demolition permits shall be prominently displayed on the job site at all times during the progress of construction or demolition so as to be readily seen from adjacent thoroughfares. A set of approved drawings shall be kept on site in a four-inch diameter PVC pipe four feet long and shall be securely attached to a post.

Per City of Rye Code, Section 68-16 A.

Work for which a building permit has been issued hereunder shall be inspected for approval prior to enclosing or covering any portion thereof and upon completion of each stage of construction, including, but not limited to, building location, site preparation, site drainage, excavation, foundation, framing, superstructure, electrical, plumbing, and heating and air conditioning. It shall be the responsibility of the owner, applicant, or his agent to inform the inspector that the work is ready for inspection and to schedule such inspection.

SAFEGUARDS DURING CONSTRUCTION:

Construction equipment and materials shall be stored and placed so as not to endanger the public, the workers or adjoining property for the duration of the construction project.

Waste materials shall be removed in a manner that prevents injury or damage to persons, adjoining properties and public rights-of-way.

Sanitary facilities shall be provided during construction, remodeling or demolition activities in accordance with the Plumbing Code of New York State.

Adjoining public and private property shall be protected from dama during construction, remodeling and demolition work. Protection wall a purided for footings, foundations, party walls, chimneys, fight and of Provious shows made to control water runoff and eros during not too or demole a activities.

ADDRESS IDENTIFICATION

The City of Rye Code Chapt 20 quires the clear display or hour a or huining numbers (hereinafter "house numbers") from public str. ets. or ε Ι, roperties that contain a principal building within the City of n, a in order to assist the general rule " or the authorities in identifying any pro are vin case of an emergency as ver as for the welfare of the general public in conducting its normal affairs.

OTHER PERMITS:

All Mechanical, Electrical and Plumbing (MEP) work shall be performed by licensed contractors and MEP Permits shall be obtained separately by those contractors.



FRONT LEFT





REAR RIGHT



EXTERIOR VIEWS POST STORM DAMAGE

PROPERTY OWNER:

Engine

Oliver
Design - Pel
Code Com

6

RYE, NY 10580

ARCHITECT:

Michael A. Gismondi, AIA 7-11 Legion Drive Valhalla, NY 10595 914-494-8943 Email-mgismo6464@aol.com

STAMP:

ISSUE: 12.21.2020 FOR PERMIT

PROJECT NAME: TREE DAMAGE **REPAIR**

DRAWING NUMBER:

G-01

DRAWING NAME:

GENERAL

SCALE: DATE: **AS NOTED** 12.21.2020

NOTE: THIS DRAWING IS VALID FOR

CONSTRUCTION IF (AND ONLY IF) A PERMIT IS ISSUED, BASED ON THIS DRAWING, BY THE CITY OF

** PERSONAL (CLIENT) INFORMATION WITHHELD

GOOGLE MAPS


THIS DRAWING IS AS A SAMPLE ONLY

"Unauthorized alterations or additions to a survey map is a violation

"Only copies of the original survey marked with the land surveyor's inked or embossed seal shall be considered a true and valid copy."

of section 7209, sub-division 2, of the New York State Education Law."

AS-BUILT SURVEY THE MUNSON COMPANY DO NOT SCALE **GENERAL, ZONING AND CODE**

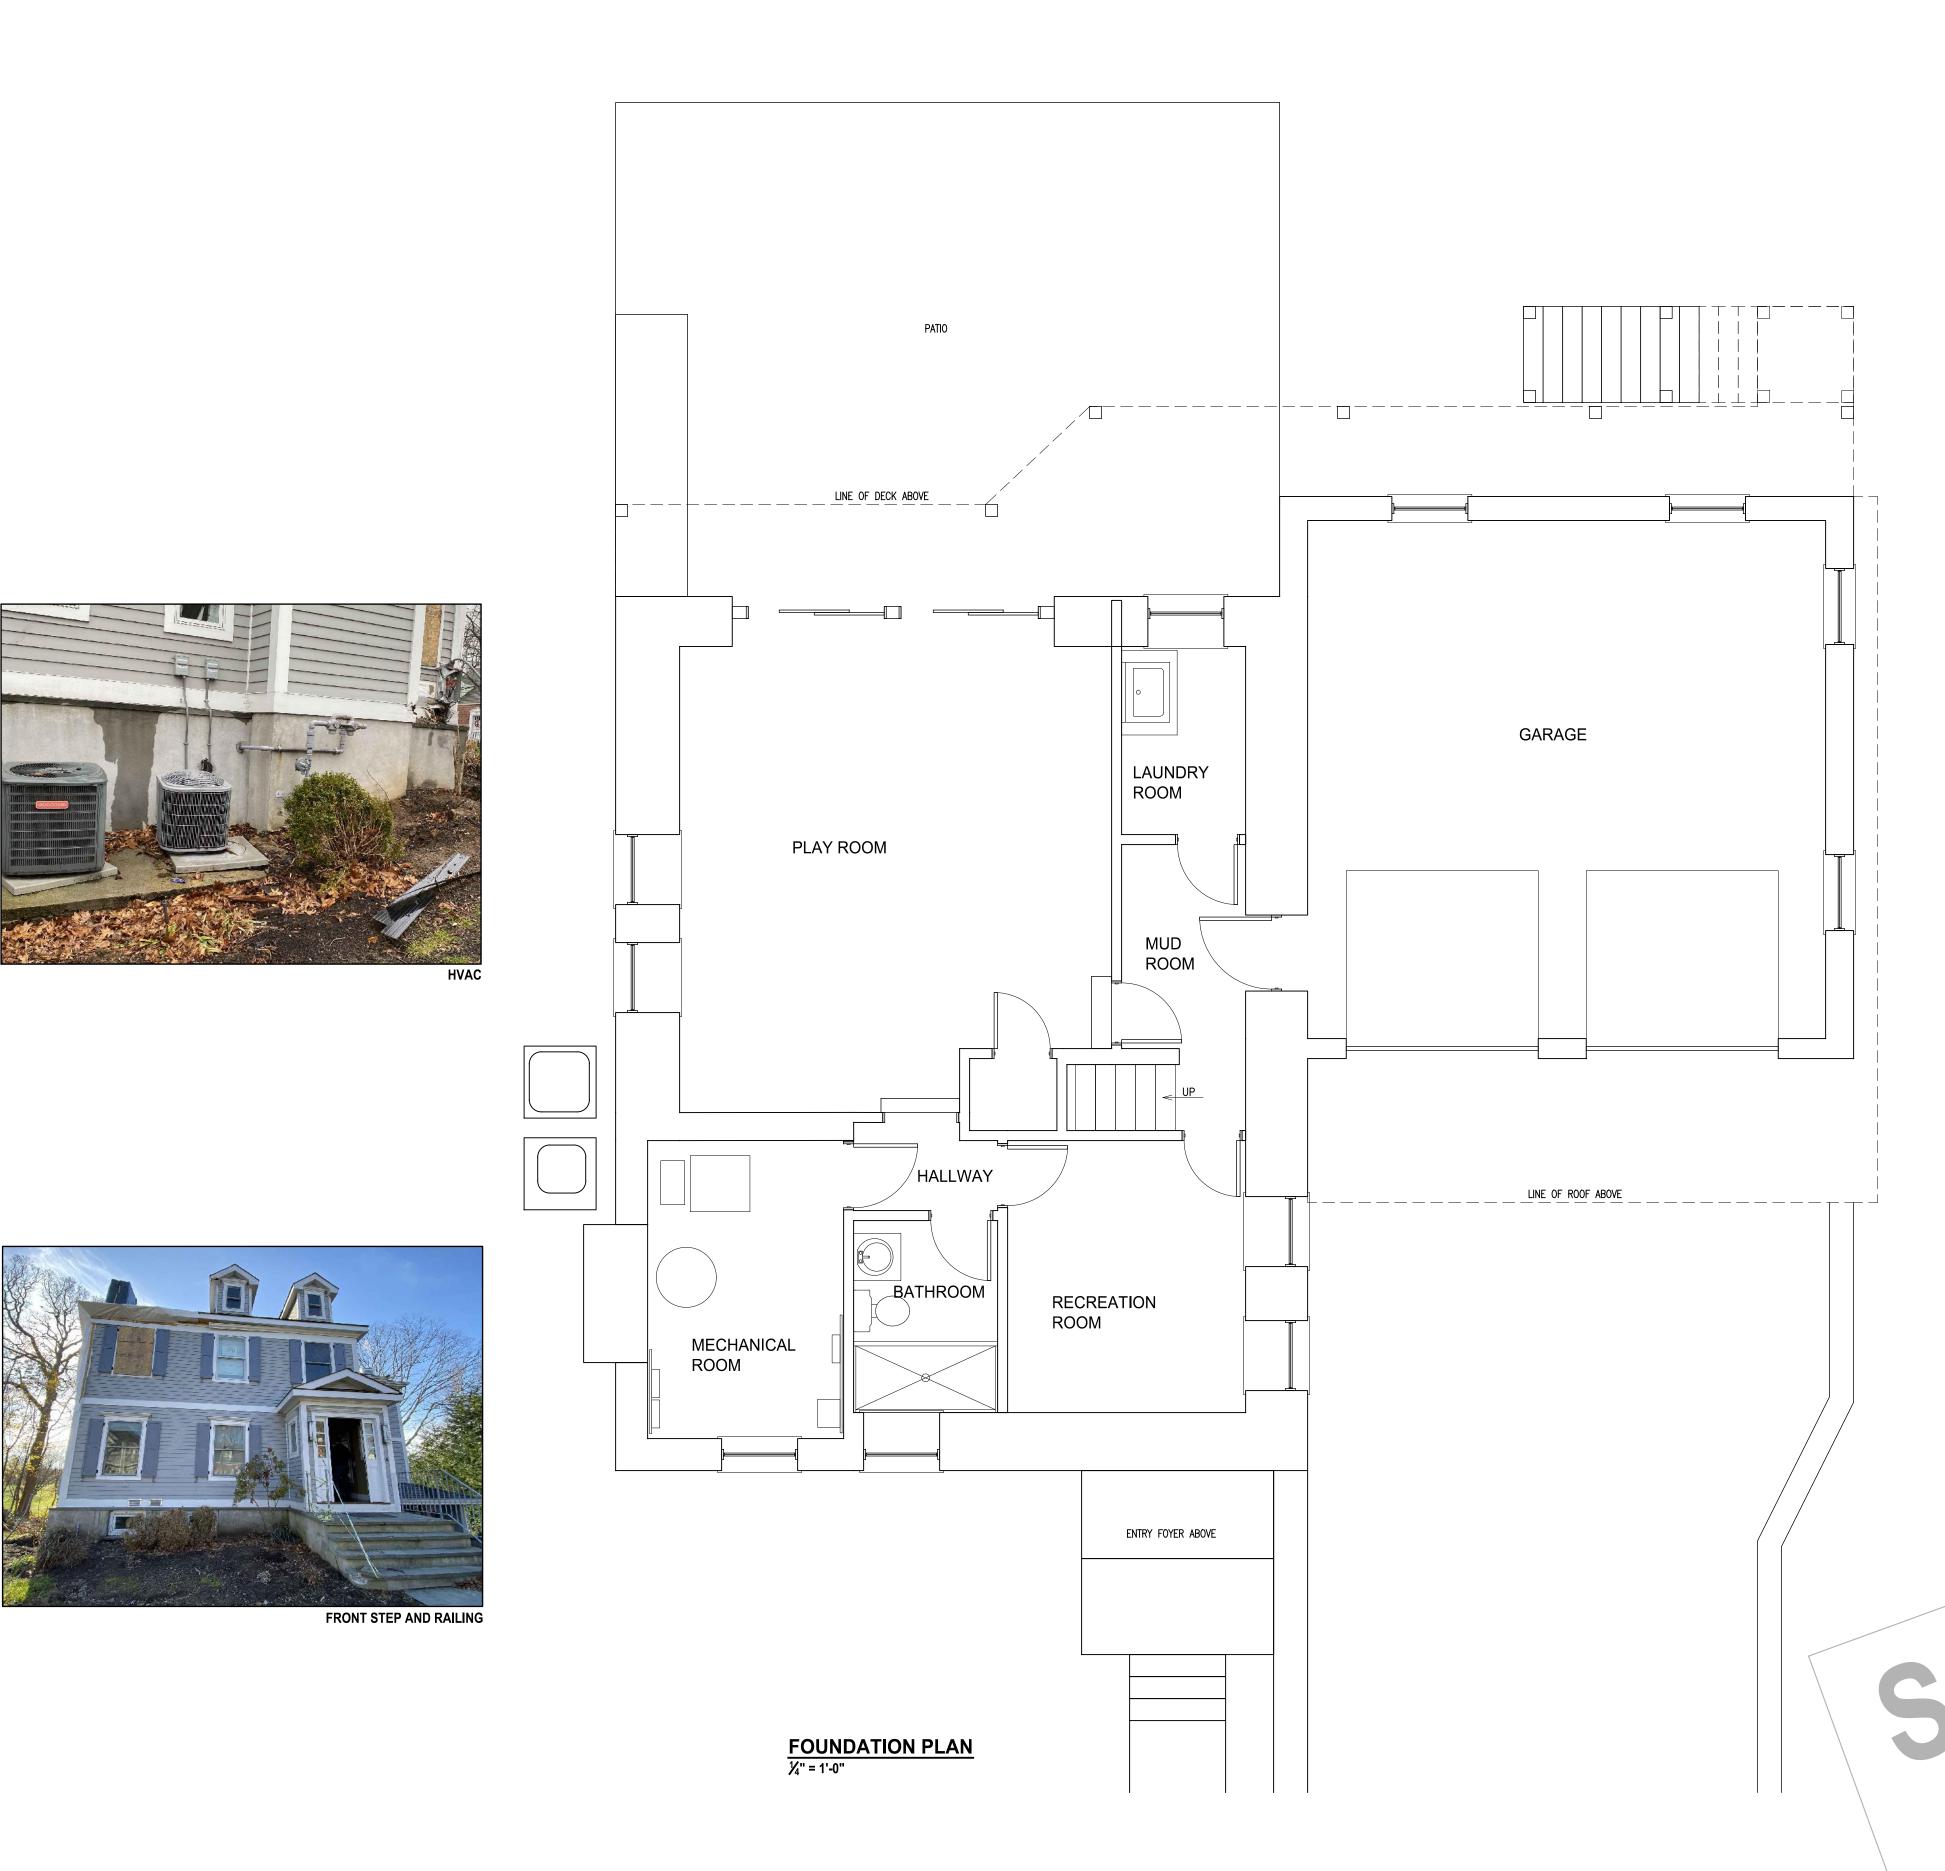

STORM DAMAGE AND MOISTURE INTRUSION REPAIR.

SCOPE OF WORK IN BASEMENT:

1. GENERAL:

Replace all damaged framing, sheathing, siding, insulation, wall covering, millwork, trim and finishes.

The extent of structural damage is based on field observations and/or assumptions regarding the current condition at the site; Any additional damage, observed on further examination, or exposed on the removal of finishes, should be brought to the attention of the architect and the owner.

2. DRYWALL & FINISHES:

Install $\frac{5}{8}$ " gypsum board to all damaged areas, tape and float, prepare for paint. Seal/prime and two coats of paint on walls, ceiling, millwork and trim. Sand, stain and finish wood flooring including stair treads.

3. MILLWORK:

Replace all damaged trim including baseboard and window and door casing; Detach and reset handrail at stairs to first floor.

4. MECHANICAL ROOM:

Test and check all breakers and rough wiring for faults.

Test, check and commission heating and cooling system.

Apply pressure test to all existing interior gas lines.

5. PLUMBING:

All Plumbing work is to be completed per PART VII of the 2020 New York State Residential Code and by a plumbing contractor licensed in Westchester County.

Plumbing work is to be filed under a separate permit.

6. ELECTRICAL:

Replace light fixtures and wiring per *PART VIII* and *Chapter 34* of the *2020 New York State Residential Code*, the *National Fire Protection Association (NFPA 70-2017)* and the *2017 National Electrical Code*.

All Electrical work is to be performed by a licensed electrical contractor, licensed in

Westchester County.

Electrical work is to be filed under a separate permit.

EXTERIOR:

1. GENERAL:

Replace all damaged sheathing, siding and exterior, trim and finishes.

2. SIDING:

Install Housewrap or approved equal air/moisture barrier.
Install beveled siding to match existing.
Install fascia, soffit, trim boards and shutters to match existing.

3. GUTTERS AND LEADERS:

Install flashing, gutters and leaders to replace existing; Use existing drains.

4. FINISH:

Seal, prime and paint all exterior siding, trim and shutters.

Replace damaged window screens.

5. STEPS AND RAILINGS:

Replace broken bluestone step.

Reset and repoint steps and walkway as required.

Reinstall/Replace railing to match existing.

Replace ornamental iron fencing and gate to match existing.

ELECTRICAL SERVICE:

1. GENERAL:

Replace damaged service mast ster s, g our ing rod, grounding conducters, carrier wires, overhead splice conne or and equival requires to replace the electrical service connections.

2. COMF JANCE:

All so cal work to be renformed by a licensed electrical con rector; Obtain all sal permits con Con Edison and from the City of Rye.

GAS SERVICE:

1. GEN'LI AL:

Re It ce has line, meter bar, the er and equiator(s) to provide new gas service.

COMPLIANCF:

All plum ling work to be performed by a licensed plumbing contractor; All installation to leave re-lested as required, Obtain all necessary permits from Con Edison and from the City of Rye.

Oliver Engineering, P

Design - Permit Applications - Legaliza
Code Compliance - Project Superv

163 North Main Street, #207 Port Chester, NY 1
(914) 774-9878 www.proeng.nyc info@proeng.ny

PROPERTY OWNER:

RYE, NY 10580

ARCHITECT:

7-11 Legion Drive Valhalla, NY 10595 914-494-8943 Email-mgismo6464@aol.com

Michael A. Gismondi, AIA

STAMP:

DATE: ISSUE: 12.21.2020 FOR PERMIT

PROJECT NAME:
TREE DAMAGE
REPAIR

DRAWING NUMBER: **A-01**


DRAWING NAME:

BASEMENT

SCALE: DATE: **AS NOTED** 12.21.2020

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THIS DRAWING IS AS A SAMPLE ONLY
*** PERSONAL (CLIENT) INFORMATION WITHHELD

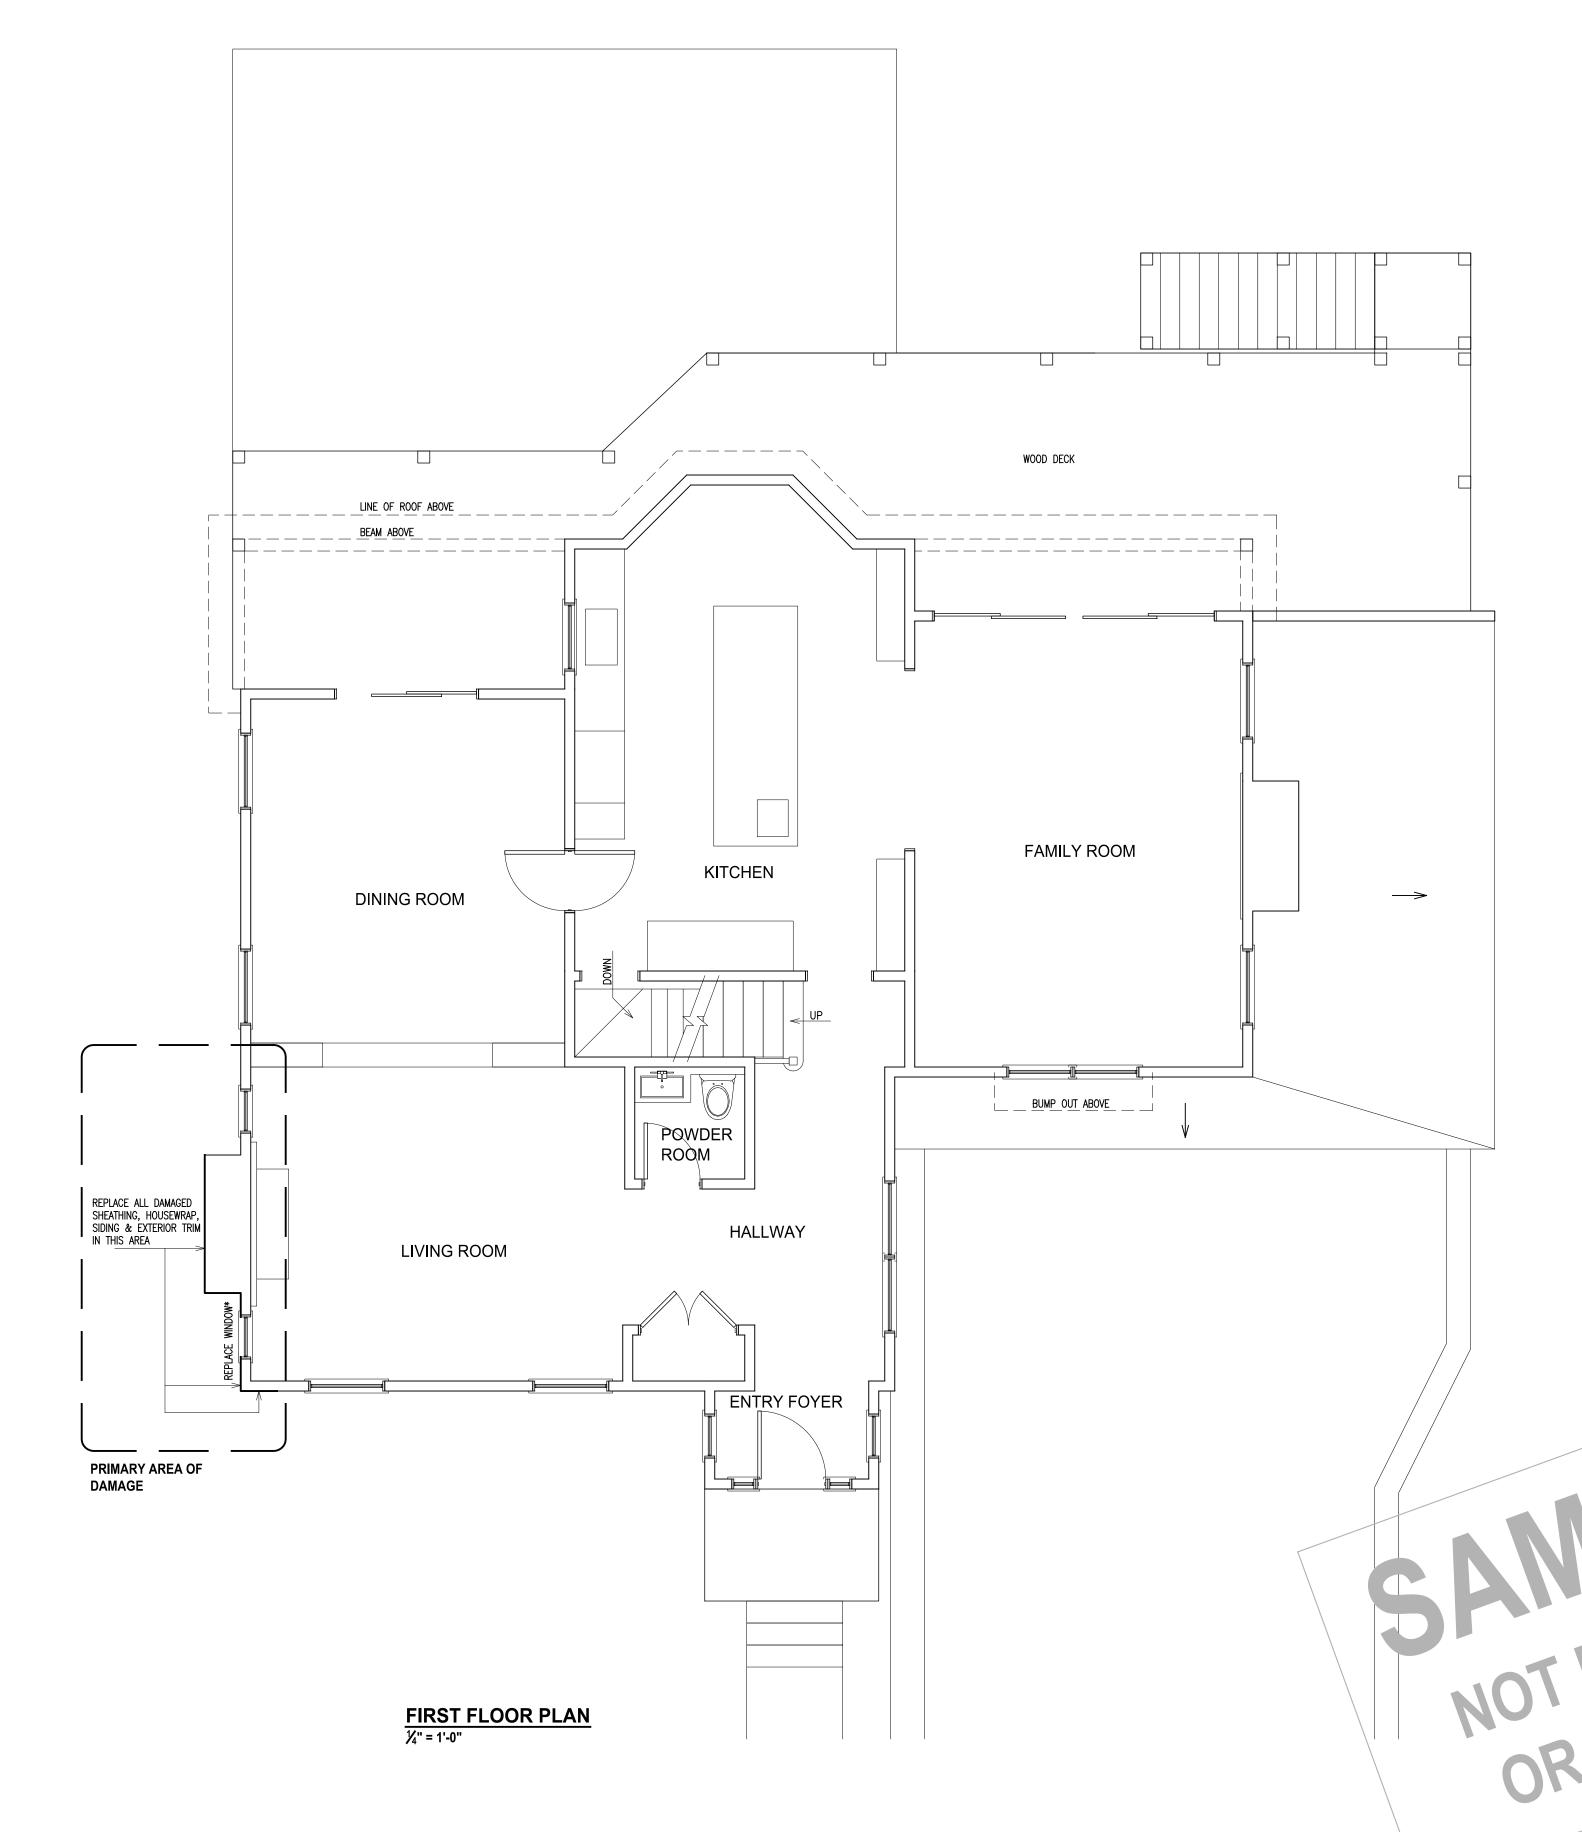

STORM DAMAGE AND MOISTURE INTRUSION REPAIR.
SCOPE OF WORK IN FIRST FLOOR:

1. GENERAL:

Replace all damaged framing, sheathing, siding, insulation, wall covering, millwork, trim and finishes.

The extent of structural damage is based on field observations and/or assumptions regarding the current condition at the site; Any additional damage, observed on further examination, or exposed on the removal of finishes, should be brought to the attention of the architect and the owner.

2. FRAMING:

Replace damaged areas of exterior wall framing including studs, top and bottom plates & plywood sheathing.

All framing to be per Section R602 Wood Wall Framing and as follows:

All framing to be per Section R602 Wood Wall Framing and as follows: R602.2 Grade

Studs shall be a minimum No. 3, standard or stud grade lumber.

Exception: Bearing studs not supporting floors and nonbearing studs shall be permitted to be utility grade lumber, provided that the studs are spaced in accordance with Table R602.3(5).

R602.3 Design and Construction

Components of exterior walls shall be fastened in accordance with tables r602.3(1) through r602.3(4). Wall sheathing shall be fastened directly to framing members and, where placed on the exterior side of an exterior wall, shall be capable of resisting the wind pressures listed in table r301.2(2) adjusted for height and exposure using table r301.2(3) and shall conform to the requirements of table r602.3(3).

3. THERMAL AND MOISTURE PROTECTION:

Install 4" R11 (in walls)

Fill all exposed cavities with insulation. ((NY) N1101.1, Exception 1.3.

Existing ceiling, wall or floor cavities exposed during construction provided that these cavities are filled with insulation)

Per N1102.1.1 (R402.1.1) and the vapor retarder requirements of section R702.7, install class II vapor retarder.

4. DRYWALL & FINISHES:

Install $\frac{5}{8}$ " gypsum board to all damaged areas, tape and float, prepare for paint.

Seal/prime and two coats of paint on walls, ceiling, millwork and trim.

Sand, stain and finish wood flooring including stair treads.

5. MILLWORK:

Install new double-hung window to meet *N1102.1.2* (*R402.1.2*) insulation and fenestration criteria

Replace all damaged trim including baseboard and window and door casing; Detach and reset handrail at stairs to second floor.

Detach and reset fireplace surround.

Remove hardwood flooring and screw down existing subfloor as required to eliminate squeaks; Replace hardwood flooring.

6. KITCHEN:

Detach and reset cabinetry including barry, wall and II-height cabinets and countertops; Install new to hac place h.

Detach and reset per noing fixther to have the harry set of the harry set o

7. PLUL JING:

All Plus work is sempleted per PAT VIL of se ?020 New York

State A sidential Code and by a plumbing so, tractorage sed in

Vestche ... county.

ambing work is to be free under reparate permit

B. ELECTRICAL

Regiate light inxtures and wiring per FART VI. 'a d Chapter 34 of the 2t I. Now York State Resident al Code the National Fire Protection Association (NFF 1.76.27.1) and the 2017 National Electrical Code.

All Electrical war is a performed by a licensed electrical contractor, licensed a Vieschester County.

Te * .cal work is to be filed under a separate permit.

PROPERTY OWNER:

Engineering, I

Oliver
Design - Per

RYE, NY 10580

ARCHITECT:

Michael A. Gismondi, AIA
7-11 Legion Drive
Valhalla, NY 10595
914-494-8943
Email-mgismo6464@aol.com

STAMP:

DATE: ISSUE: 12.21.2020 FOR PERMIT

PROJECT NAME:
TREE DAMAGE
REPAIR

DRAWING NUMBER: A-02

DRAWING NAME:

FIRST FLOOR

SCALE: DATE: AS NOTED 12.21.2020

NOTE:
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RYE.

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** PERSONAL (CLIENT) INFORMATION WITHHELD

REPLACE WINDOW AT LIVING ROOM

All new windows to be *Pella Architect* or *Lifestyle* series double-hung wood. All new windows must meet the Fenestration Criteria of TABLE N1102.1.2 (R402.1.2) and as follows: Minimum 0.32 BTU/H/s.f./F Fenestration U-Factor: Solar Heat Gain Coefficient (SHGC): Minimum 0.4



BED 1 BATHROOM



SECOND FLOOR PLAN

OFFICE

BEDROOM 1

-REPLACE EXTERIOR

REPLACE WINDOW*

FRAMING IN THIS AREA

BED 1 BATH

REPLACE SHEATHING, HOUSEWRAP, SIDING & EXTERIOR TRIM

PRIMARY AREA OF

DAMAGE

MASTER

BEDROOM 2

 \longrightarrow

BATHROOM

STORM DAMAGE AND MOISTURE INTRUSION REPAIR. SCOPE OF WORK IN SECOND FLOOR:

1. GENERAL:

Replace all damaged framing, sheathing, siding, insulation, wall covering,

The extent of structural damage is based on field observations and/or assumptions regarding the current condition at the site; Any additional damage, observed on further examination, or exposed on the removal of

2. FRAMING:

Replace damaged areas of exterior wall framing including studs, top and

All framing to be per Section R602 Wood Wall Framing and as follows:

Studs shall be a minimum No. 3, standard or stud grade lumber.

Components of exterior walls shall be fastened in accordance with tables r602.3(1) through r602.3(4). Wall sheathing shall be fastened directly to framing members and, where placed on the exterior side of an exterior wall, shall be capable of resisting the wind pressures listed in table r301.2(2) adjusted for height and exposure using table r301.2(3) and shall conform to the requirements of table r602.3(3).

3. THERMAL AND MOISTURE PROTECTION:

Install 10" R30 foil-faced insulation (in ceiling) and 4" R11 (in walls) Fill all exposed cavities with insulation. ((NY) N1101.1, Exception 1.3. that these cavities are filled with insulation)

R702.7, install class II vapor retarder.

4. DRYWALL & FINISHES:

Sand, stain and finish wood flooring including stair treads.

5. MILLWORK:

Install new double-hung window(s) to meet N1102.1.2 (R402.1.2) insulation and fenestration criteria

6. BATHROOM:

Demolish tile floor, tile shower; Install new mud bed, new shower pan. Repair drywall, re-tape and float as needed. Remove and reset all plumbing fixtures. Replace exhaust fan, lights and wiring; GFI and all wiring per NEC. All tile installation per ANSI 108 and standards of the e Council of North

7. PLUMBING:

All Plumbing work is to 'con' 'ed er \T VII of th 2020 New York State Residential Co e and verilling or licensed in Westr' ... County

Plumb or 'k is to file unuer a separate permit.

Now York State Residential Code the Lional Fire Protection Association (NFPA 70-2017) and the 2017 lational Electrica Code.

All Flectrical work is to be performed by a license less than trical contractor, lice no ed in Westchester Courty

millwork, trim and finishes.

finishes, should be brought to the attention of the architect and the owner.

 \longrightarrow

MASTER BEDROOM

bottom plates & plywood sheathing.

R602.2 Grade

Exception: Bearing studs not supporting floors and nonbearing studs shall be permitted to be utility grade lumber, provided that the studs are spaced in accordance with Table R602.3(5).

R602.3 Design and Construction

Existing ceiling, wall or floor cavities exposed during construction provided

Per N1102.1.1 (R402.1.1) and the vapor retarder requirements of section

Install \(^5\)/8" gypsum board to all damaged areas, tape and float, prepare for Seal/prime and two coats of paint on walls, ceiling, millwork and trim.

Replace all damaged trim including baseboard and window and door

America.

FLECTI CAL:

Electrical work is to be to note a separate permit.

PROPERTY OWNER:

Engineering, I

Oliver
Design - Per

W

RYE, NY 10580

ARCHITECT:

Michael A. Gismondi, AIA 7-11 Legion Drive Valhalla, NY 10595 914-494-8943 Email-mgismo6464@aol.com

STAMP:

ISSUE: 12,21,2020 FOR PERMIT

PROJECT NAME: TREE DAMAGE **REPAIR**

DRAWING NUMBER: A-03

DRAWING NAME: SECOND FLOOR

SCALE: DATE: AS NOTED 12.21.2020


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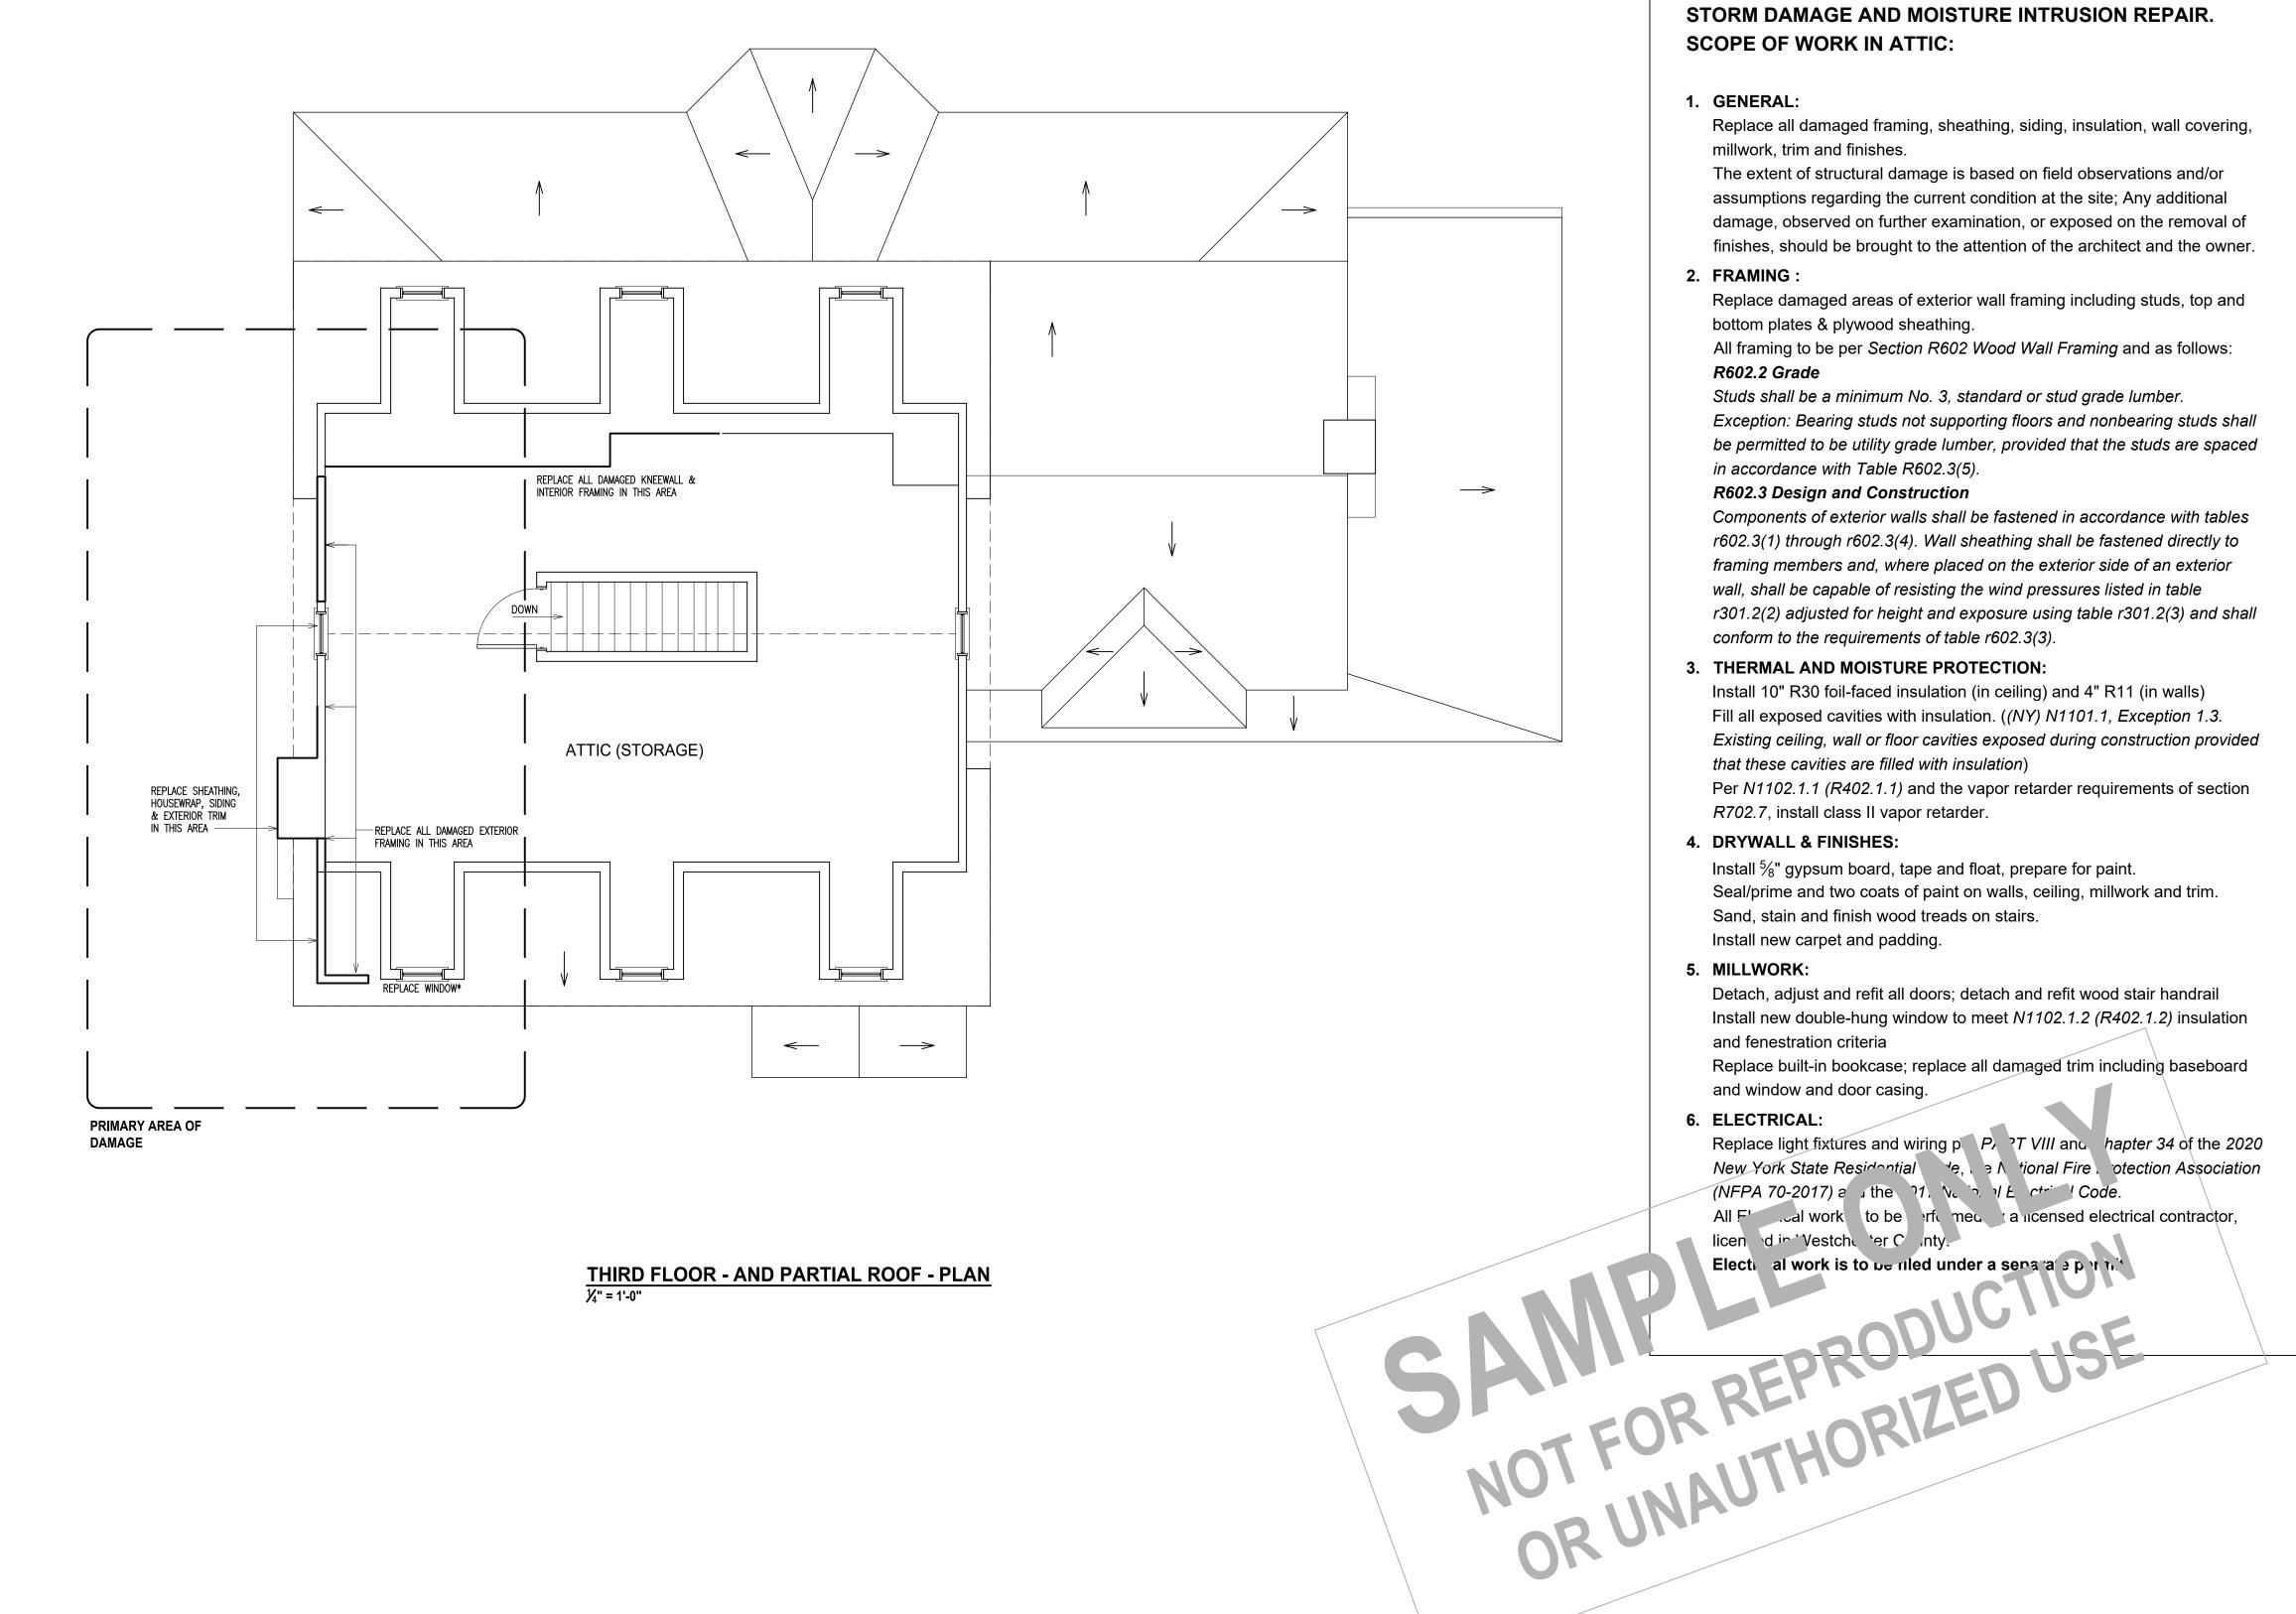
FRONT DORMER - TO BE REBUILT



REPLACE WINDOW; REFRAME WALL



REPLACE DAMAGED FRAMING

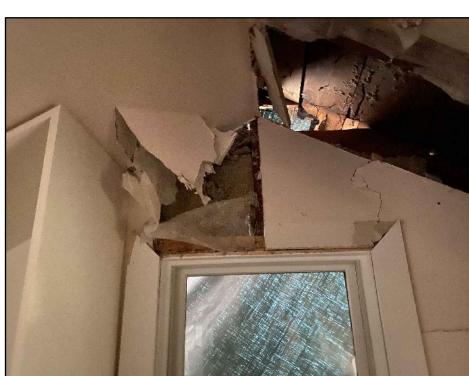

THIRD FLOOR - AND PARTIAL ROOF - PLAN

STORM DAMAGE AND MOISTURE INTRUSION REPAIR. SCOPE OF WORK IN ATTIC:

1. GENERAL:

Replace all damaged framing, sheathing, siding, insulation, wall covering, millwork, trim and finishes.

The extent of structural damage is based on field observations and/or assumptions regarding the current condition at the site; Any additional damage, observed on further examination, or exposed on the removal of finishes, should be brought to the attention of the architect and the owner.

2. FRAMING:

Replace damaged areas of exterior wall framing including studs, top and bottom plates & plywood sheathing.

All framing to be per Section R602 Wood Wall Framing and as follows: R602.2 Grade

Studs shall be a minimum No. 3, standard or stud grade lumber. Exception: Bearing studs not supporting floors and nonbearing studs shall be permitted to be utility grade lumber, provided that the studs are spaced in accordance with Table R602.3(5).

R602.3 Design and Construction

Components of exterior walls shall be fastened in accordance with tables r602.3(1) through r602.3(4). Wall sheathing shall be fastened directly to framing members and, where placed on the exterior side of an exterior wall, shall be capable of resisting the wind pressures listed in table r301.2(2) adjusted for height and exposure using table r301.2(3) and shall conform to the requirements of table r602.3(3).

3. THERMAL AND MOISTURE PROTECTION:

R702.7, install class II vapor retarder.

Install 10" R30 foil-faced insulation (in ceiling) and 4" R11 (in walls) Fill all exposed cavities with insulation. ((NY) N1101.1, Exception 1.3. Existing ceiling, wall or floor cavities exposed during construction provided that these cavities are filled with insulation) Per N1102.1.1 (R402.1.1) and the vapor retarder requirements of section

4. DRYWALL & FINISHES:

Install $\frac{5}{8}$ " gypsum board, tape and float, prepare for paint. Seal/prime and two coats of paint on walls, ceiling, millwork and trim. Sand, stain and finish wood treads on stairs.

Install new carpet and padding. 5. MILLWORK:

Detach, adjust and refit all doors; detach and refit wood stair handrail Install new double-hung window to meet N1102.1.2 (R402.1.2) insulation and fenestration criteria

Replace built-in bookcase; replace all damaged trim including baseboard and window and door casing.

6. ELECTRICAL:

Replace light fixtures and wiring p Pr ?T VIII and hapter 34 of the 2020 New York State Residential Ye, Se A fional Fire Cotection Association

PROPERTY OWNER:

Oliv Design

W

RYE, NY 10580

ARCHITECT:

7-11 Legion Drive Valhalla, NY 10595 914-494-8943 Email-mgismo6464@aol.com

Michael A. Gismondi, AIA

STAMP:

ISSUE: DATE: 12.21.2020 FOR PERMIT

PROJECT NAME: TREE DAMAGE REPAIR

DRAWING NUMBER: A-04

DRAWING NAME:

ATTIC

SCALE: DATE: **AS NOTED** 12.21.2020


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ROOF AT REAR DORMER




GABLE AND ROOF



FRONT DORMER - TO BE REBUILT

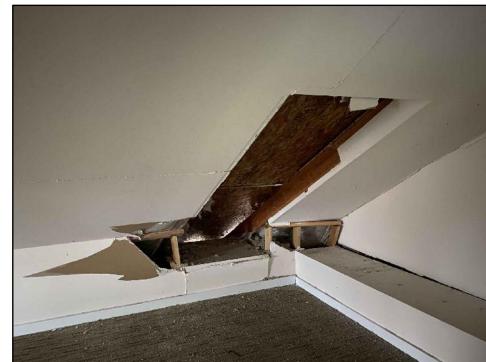

WALL FRAMING, SIDING, WINDOWS, CHIMNEY, DORMER (MISSING) & ROOF

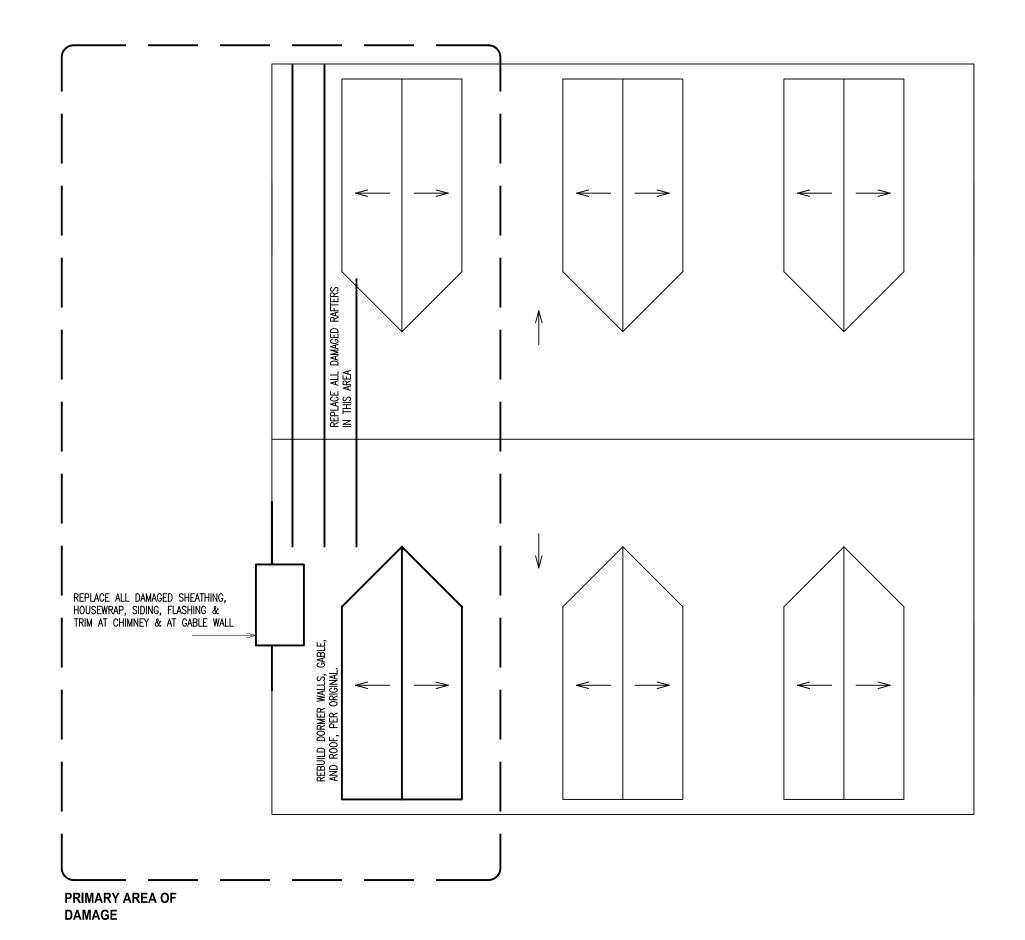

HIGH ROOF PLAN

STORM DAMAGE AND MOISTURE INTRUSION REPAIR.

ROOF AND EXTERIOR:

1. GENERAL:

Replace all damaged framing, sheathing, siding, insulation, wall covering, millwork, trim and finishes.

The extent of structural damage is based on field observations and/or assumptions regarding the current condition at the site; Any additional damage, observed on further examination, or exposed on the removal of finishes, should be brought to the attention of the architect and the owner.

2. FRAMING:

Replace damaged areas of exterior wall framing including studs, top and bottom plates & plywood sheathing.

All framing to be per Section R602 Wood Wall Framing and as follows: R602.2 Grade

Studs shall be a minimum No. 3, standard or stud grade lumber. Exception: Bearing studs not supporting floors and nonbearing studs shall be permitted to be utility grade lumber, provided that the studs are spaced in accordance with Table R602.3(5).

R602.3 Design and Construction

Components of exterior walls shall be fastened in accordance with tables r602.3(1) through r602.3(4). Wall sheathing shall be fastened directly to framing members and, where placed on the exterior side of an exterior wall, shall be capable of resisting the wind pressures listed in table r301.2(2) adjusted for height and exposure using table r301.2(3) and shall conform to the requirements of table r602.3(3).

3. DORMER:

Rebuild dormer in existing location and to existing design - match other dormers; Remove and replace damaged /missing rafters, ridge beam, dormer walls, ceiling joists, roof and wall sheathing.

4. ROOF:

Remove existing shingle and replace with matching laminated composite shingle; Include ridge vent, ice and water shield, drip edge, ridge cap, flashing, step flashing, (pipe and vent) flashing boot(s).

5. CHIMNEY:

Install copper flashing to chimney chase; Install flue cap; Clean and inspect chimney flue and fireplace; Correct any deficiencies.

6. THERMAL AND MOISTURE PROTECTION:

Fill all exposed cavities with insulation. ((NY) N1101.1, Exception 1.3. Existing ceiling, wall or floor cavities exposed during construction provided that these cavities are filled with insulation) Per N1102.1.1 (R402.1.1) and the vapor retarder requirements of section R702.7, install class II vapor retarder.

7. HVAC:

Replace existing 2-ton Central air condenser unit wit rya 13 EER unit on new 36"x36" condenser pad;

Evacuate system, replace linese* echarge system Detach and reset air handler kemove furne e and Ck il: reinstall and tie

PROPERTY OWNER:

W

RYE, NY 10580

ARCHITECT: Michael A. Gismondi, AIA

7-11 Legion Drive Valhalla, NY 10595 914-494-8943 Email-mgismo6464@aol.com

STAMP:

DATE: ISSUE: 12.21.2020 FOR PERMIT

PROJECT NAME: TREE DAMAGE **REPAIR**

DRAWING NUMBER: A-05

DRAWING NAME: ROOF

> SCALE: DATE: **AS NOTED** 12.21.2020

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