
LOCATION GOOGLE MAPS ***, GREENWICH



SATELLITE VIEW GOOGLE EARTH

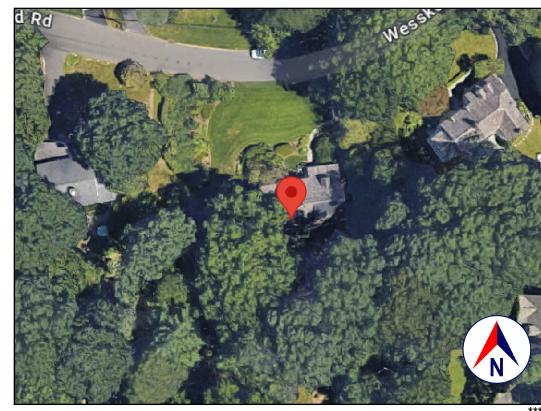

TAX MAP **CT ECO MAP**



FRONT VIEW GOOGLE STREET VIEW

1.0 GENERAL REQUIREMENTS:

1.1 DESIGN INTENT:

THESE (STRUCTURAL) DRAWINGS ADDRESS ONLY THE STRUCTURAL INTEGRITY, BASED ON THE STIPULATED LOADS, OF THE PROPOSED CONSTRUCTION.

THESE DRAWINGS SHOULD ONLY BE USED IN CONJUNCTION WITH THE ARCHITECTURAL AND OTHER

IT IS THE OVERALL INTENT OF (ALL OF THE DRAWINGS) TO CALL FOR COMPLETE AND FINISHED WORK, IN COMPLIANCE WITH THE NOTED CODES, AND TESTED AND GUARANTEED AND READY FOR

OPERATION.

THESE (STRUCTURAL) DRAWINGS ARE NOT INTENDED TO ADDRESS: ZONING; DRAINAGE; GRADING; OR OTHER SITE ISSUES. REFER TO THE SITE PLAN AND ENGINEERING DRAWINGS FOR ALL SITE-RELATED ISSUES.

THESE (STRUCTURAL) DRAWINGS ARE NOT INTENDED TO ADDRESS: BUILDING PLANNING; DIMENSIONAL COORDINATION; THERMAL OR MOISTURE PROTECTION; EGRESS; FIRE PROTECTION; MECHANICAL; HEAT, LIGHT AND VENTILATION; GENERAL BUILDING; OR ANY OTHER OTHER NON-STRUCTURAL ISSUES.

REFER TO CHRIS SNYDER ARCHITECTURE & DESIGN ARCHITECTURAL DRAWINGS FOR ALL SUCH ISSUES.

THE ENGINEER HAS NOT BEEN ENGAGED TO SUPERVISE ANY WORK AND DOES NOT HAVE CONTROL OR CHARGE OF, AND SHALL NOT BE RESPONSIBLE FOR, CONSTRUCTION MEANS, METHODS, TECHNIQUES, SEQUENCES, OR PROCEDURES, FOR SAFETY PRECAUTIONS AND PROGRAMS IN CONNECTION WITH THE WORK, FOR THE ACTS OR OMISSIONS OF THE CONTRACTOR. SUBCONTRACTOR, OR ANY OTHER PERSONS PERFORMING ANY OF THE WORK, OR FOR THE FAILURE OF ANY OF THEM TO CARRY OUT THE WORK IN ACCORDANCE WITH THE CONTRACT DOCUMENTS.

1.2 SCOPE AND CLASSIFICATION:

THIS IS A PROPOSED ADDITION, AS DEFINED IN THE 2021 INTERNATIONAL EXISTING BUILDING CODE PORTION OF THE 2022 CONNECTICUT STATE BUILDING CODE; PER CHAPTER 11 OF THAT CODE: AN ADDITION TO A BUILDING OR STRUCTURE SHALL COMPLY WITH THE INTERNATIONAL CODES AS ADOPTED FOR NEW CONSTRUCTION WITHOUT REQUIRING THE EXISTING BUILDING OR STRUCTURE TO COMPLY WITH ANY REQUIREMENTS OF THOSE CODES OR OF THESE PROVISIONS, EXCEPT AS REQUIRED BY THIS CHAPTER. WHERE AN ADDITION IMPACTS THE EXISTING BUILDING OR STRUCTURE, THAT PORTION SHALL COMPLY WITH THIS CODE.

CONSTRUCTION TYPE TYPE V-B, AS DEFINED IN TABLE 601 YEAR BUILT: 1931 (PER ZILLOW) OCCUPANCY CLASSIFICATION: DETACHED ONE-FAMILY DWELLING STRUCTURE ARCHITECTURAL REVIEW: REFER TO ARCHITECTURAL DRAWINGS

1.3 COMPLIANCE:

ALL WORK SHALL BE IN COMPLIANCE WITH:

- THE 2021 INTERNATIONAL RESIDENTIAL CODE PORTION OF THE 2022 CONNECTICUT STATE BUILDING CODE AND ALL OTHER CODES REFERENCED THEREIN.
- THE 2021 INTERNATIONAL EXISTING BUILDING CODE PORTION OF THE 2022 CONNECTICUT STATE BUILDING CODE .
- CHAPTER 6, LAND USE, OF THE TOWN OF GREENWICH MUNICIPAL CODE.
- ALL OTHER REFERENCED CODES AND ALL OTHER CODES AND REGULATIONS, LOCAL, STATE AND FEDERAL, THAT APPLY.

1.4 AUTHORITY HAVING JURISDICTION:

THE AUTHORITY HAVING JURISDICTION, AS DEFINED IN 103.1 OF THE BUILDING CODE, AND WHICH SHALL PROVIDE FOR ADMINISTRATION AND ENFORCEMENT OF THE UNIFORM CODE AND ENERGY CODE BY LOCAL LAW, ORDINANCE, OTHER APPROPRIATE REGULATION, OR COMBINATION THEREOF, IS THE TOWN OF GREENWICH.

THE DULY APPOINTED BUILDING OFFICIAL OF THE TOWN OF GREENWICH IS AUTHORIZED TO ENFORCE THE PROVISIONS OF THE CODE.

THE BUILDING OFFICIAL MAY ADOPT POLICIES AND PROCEDURES IN ORDER TO CLARIFY THE APPLICATION OF THE PROVISIONS OF THE CODE. SUCH POLICIES AND PROCEDURES SHALL BE IN COMPLIANCE WITH THE INTENT AND PURPOSE OF THE CODE.

2. CONTRACTOR'S RESPONSIBILITIES:

THE CONTRACTOR SHALL:

- PROVIDE ALL LABOR, MATERIALS AND EQUIPMENT NECESSARY FOR A COMPLETE AND FINISHED
- PROVIDE ALL NECESSARY SHORING AND BRACING FOR ALL BUILDING COMPONENTS IN ORDER TO ADEQUATELY PROTECT AGAINST ANY FAILURES.
- OBTAIN AND PAY FOR ALL REQUIRED PERMITS UNLESS OTHERWISE STIPULATED.
- PRIOR TO THE SUBMISSION OF ANY BID, AND BEFORE PROCEEDING WITH ANY WORK, VISIT THE SITE AND VERIFY AND FAMILIARIZE HIM/HERSELF WITH ALL SITE DIMENSIONS AND CONDITIONS, WITH SITE WORKING CONDITIONS, HOURS OF LEGAL OPERATION, METHODS AND ROUTES OF ACCESS, AND THE EXISTENCE AND EXTENT OF ANY OTHER RESTRICTIONS, AND BE RESPONSIBLE FOR THE VERIFICATION OF ALL SUCH CONDITIONS AND DIMENSIONS WHICH PERTAIN TO THE
- BRING ALL DISCREPANCIES IN CONDITIONS AND DIMENSIONS, BETWEEN THE APPROVED DRAWINGS AND ACTUAL FIELD CONDITIONS. TO THE IMMEDIATE ATTENTION OF THE OWNER, AND RECEIVE DIRECTION IN WRITING, BEFORE PROCEEDING WITH THE AFFECTED WORK.
- VERIFY THE AVAILABILITY, LOCATION LAYOUT AND CONDITION OF UTILITIES, INCLUDING SEWER, WATER, GAS AND ELECTRIC LINES, PRIOR TO THE SUBMISSION OF ANY BID.
- PRIOR TO THE COMMENCEMENT OF ANY WORK, VERIFY THE CONDITION OF ALL ADJOINING STRUCTURES WHICH MAY BE AFFECTED, AND PROVIDE ADEQUATE PROTECTION TO ANY STRUCTURE THAT MIGHT BE OTHERWISE AFFECTED.
- IN THE EVENT THAT DAMAGE IS CAUSED TO ANY STRUCTURE, FINISH, OR OTHER ELEMENT, RESTORE SUCH ELEMENTS TO THEIR ORIGINAL CONDITION.
- HAVE CONTROL OVER AND SUPERVISE, COORDINATE AND DIRECT THE WORK, INCLUDING THAT OF HIS SUBCONTRACTORS, AND SHALL BE SOLELY RESPONSIBLE FOR CONSTRUCTION MEANS, METHODS, TECHNIQUES, SEQUENCES AND PROCEDURES, AND FOR JOBSITE SAFETY.
- IF APPLICABLE, PROVIDE WEATHER PROTECTION, IN AN EFFECTIVE AND TIMELY MANNER, TO
- PROTECT THE PREMISES, PERSONNEL, MATERIALS AND INSTALLED WORK. BE A HOME IMPROVEMENT CONTRACTOR REGISTERED WITH THE STATE OF CONNECTICUT DEPARTMENT OF CONSUMER PROTECTION.
- BE CERTIFIED AS A LEAD SAFE FIRM BY THE EPA PER 40 CFR 745.226.
- CARRY LIABILITY INSURANCE TO THE LIMITS REQUIRED BY THE AUTHORITY HAVING JURISDICTION AND ISSUE CERTIFICATE(S) OF INSURANCE AS REQUIRED BY THE HOMEOWNER AND/OR THAT AUTHORITY.
- CARRY WORKMAN'S COMPENSATION AND DISABILITY INSURANCE AS REQUIRED THE LAW AND ISSUE CERTIFICATE(S) AS REQUIRED BY THE HOMEOWNER AND/OR THE AUTHORITY HAVING JURISDICTION.

3. BUILDING PERMIT

NO PERSON OR ENTITY SHALL COMMENCE, PERFORM, OR CONTINUE ANY WORK THAT MUST CONFORM WITH THE UNIFORM CODE AND/OR ENERGY CODE UNLESS:

- 1. SUCH PERSON OR ENTITY HAS APPLIED TO THE TOWN OF GREENWICH FOR A BUILDING PERMIT,
- 2. THE TOWN OF GREENWICHHAS ISSUED A BUILDING PERMIT AUTHORIZING SUCH WORK,
- 3. SUCH BUILDING PERMIT HAS NOT BEEN REVOKED OR SUSPENDED, AND
- 4. SUCH BUILDING PERMIT HAS NOT EXPIRED.

THE BUILDING PERMIT IS REQUIRED TO BE VISIBLY DISPLAYED AT THE WORKSITE AND TO REMAIN VISIBLE UNTIL THE PROJECT, AND ALL REQUIRED INSPECTIONS, HAVE BEEN COMPLETED.

THE APPROVED DRAWINGS MUST BE KEPT AT THE WORKSITE AND BE AVAILABLE FOR REVIEW AT THE TIME OF ANY REQUIRED INSPECTIONS.

4. CONSTRUCTION INSPECTIONS: IT SHALL BE THE DUTY OF THE HOLDER OF THE BUILDING PERMIT, OR THEIR DULY AUTHORIZED AGENT, TO NOTIFY THE BUILDING OFFICIAL WHEN WORK IS READY FOR INSPECTION:

DEPARTMENT OF PUBLIC WORKS, DIVISION OF BUILDING INSPECTION

TOWN HALL - 101 FIELD POINT ROAD, GREENWICH, CT 06830

(913) 992-8910 EMAIL: bldginsp@greenwichct.org

WEBSITE: www.greenwichct.gov/195/Building-Inspection

ANY PERSON OR ENTITY PERFORMING WORK FOR WHICH A BUILDING PERMIT HAS BEEN ISSUED SHALL KEEP SUCH WORK ACCESSIBLE AND EXPOSED UNTIL THE WORK HAS BEEN INSPECTED AND ACCEPTED BY THE AUTHORITY HAVING JURISDICTION, OR ITS AUTHORIZED AGENT, AT EACH ELEMENT OF THE CONSTRUCTION PROCESS THAT IS APPLICABLE TO THE WORK.

BUILDING PERMIT HOLDERS SHALL BE REQUIRED TO NOTIFY THE BUILDING OFFICIAL OF THE TOWN OF GREENWICH WHEN CONSTRUCTION WORK IS READY FOR INSPECTION.

THE BUILDING OFFICIAL SHALL MAKE THE REQUIRED INSPECTIONS OR SHALL HAVE THE AUTHORITY TO ACCEPT WRITTEN REPORTS OF INSPECTION BY APPROVED AGENCIES OR INDIVIDUALS.

REQUIRED INSPECTIONS FOR THIS PROJECT MAY INCLUDE THE FOLLOWING, AS APPLICABLE, OR AS SPECIFIED IN THE CODE ENFORCEMENT PROGRAM OF THE TOWN OF GREENWICH:

- WORKSITE PRIOR TO THE ISSUANCE OF A PERMIT
- PLUMBING*
- ELECTRICAL*
- FRAMING (SUBSEQUENT TO THE INSPECTION & APPROVAL OF PLUMBING, ELECTRICAL &
- MECHANICAL)
- FIRE RESISTANT CONSTRUCTION
- FIRE RESISTANT PENETRATIONS ENERGY CODE COMPLIANCE
- A FINAL INSPECTION AFTER ALL WORK AUTHORIZED BY THE BUILDING PERMIT HAS BEEN COMPLETED
- ANY OTHER INSPECTIONS AS REQUIRED BY THE TOWN OF GREENWICH.

CODE PROVISION OR PROVISIONS THAT HAVE NOT BEEN MET.

A SCHEDULE OF REQUIRED INSPECTIONS IS AVAILABLE FROM THE BUILDING DEPARTMENT OF THE

*THE WORK APPLICABLE TO SOME OF THE ABOVE INSPECTIONS (FOR INSTANCE PLUMBING AND ELECTRICAL) SHALL BE COMPLETED UNDER A SEPARATE PERMIT, FILED BY THE RELEVANT LICENSED

AFTER INSPECTION, THE WORK OR A PORTION THEREOF SHALL BE NOTED AS SATISFACTORY AS COMPLETED, OR THE BUILDING PERMIT HOLDER SHALL BE NOTIFIED AS TO THE MANNER IN WHICH THE WORK FAILS TO COMPLY WITH APPLICABLE CODES, INCLUDING A CITATION OF THE SPECIFIC

IT SHALL BE THE DUTY OF THE PERMIT HOLDER TO ASCERTAIN THE RESULTS OF REQUIRED INSPECTIONS.

CONSTRUCTION WORK NOT IN COMPLIANCE WITH APPLICABLE CODES SHALL BE REQUIRED TO REMAIN EXPOSED UNTIL IT HAS BEEN BROUGHT INTO COMPLIANCE WITH THE CODES, RE-INSPECTED, AND FOUND SATISFACTORY AS COMPLETED.

FLOOR FRAMING:

STRUCTURAL FLOOR MEMBERS SHALL CONFORM TO THE APPLICABLE PROVISIONS OF SECTION R502.

LOAD BEARING WALLS SHALL CONFORM TO THE APPLICABLE PROVISIONS OF SECTION R602.

INTERNAL LOAD BEARING WOOD FRAMED PARTITIONS ARE TO BE 2X4 WOOD STUDS, DOUGLAS FIR-LARCH NO. 2 OR HEM-FIR NO. 2, FB=850 PSI, 1.4E OR BETTER, AT 16" (MAXIMUM) ON CENTER, OR AS OTHERWISE NOTED IN THE DRAWINGS.

AVOID NOTCHING (SEE CUTTING AND NOTCHING BELOW). PROVIDE SISTER STUDS AS REQUIRED.

BEARING STUDS NOT SUPPORTING FLOORS AND NONBEARING STUDS SHALL BE PERMITTED TO BE UTILITY GRADE LUMBER, PROVIDED THAT THE STUDS ARE SPACED AT 16" O.C. MINIMUM.

STUDS SHALL HAVE FULL BEARING ON A NOMINAL 2-BY (51 MM) OR LARGER PLATE OR SILL HAVING A WIDTH NOT LESS THAN TO THE WIDTH OF THE STUDS.

WOOD STUD WALLS SHALL BE CAPPED WITH A DOUBLE TOP PLATE INSTALLED TO PROVIDE OVERLAPPING AT CORNERS AND INTERSECTIONS WITH BEARING PARTITIONS. END JOINTS IN TOP PLATES SHALL BE OFFSET NOT LESS THAN 24 INCHES (610 MM). JOINTS IN PLATES NEED NOT OCCUR OVER STUDS. PLATES SHALL BE NOT LESS THAN 2-INCHES (51 MM) NOMINAL THICKNESS AND HAVE A WIDTH NOT LESS THAN THE WIDTH OF THE STUDS.

ROOF-CEILING CONSTRUCTION:

ROOF FRAMING SHALL CONFORM TO THE APPLICABLE PROVISIONS OF SECTION R802.

ALL ROOF FRAMING, INCLUDING RAFTERS, COLLAR TIES, RAFTER TIES AND CEILING JOISTS, IS TO BE 2X WOOD JOISTS, DOUGLAS FIR-LARCH NO. 2 OR HEM-FIR NO. 2, FB=850 PSI, 1.4E, OR BETTER, AT 16" (MAXIMUM) ON CENTER, OR AS OTHERWISE NOTED IN THE DRAWINGS. AVOID NOTCHING (SEE CUTTING AND NOTCHING BELOW). PROVIDE SISTER MEMBERS AS REQUIRED.

CUTTING, DRILLING AND NOTCHING FOR WIRES AND PIPES:

WOOD-FRAMED STRUCTURAL MEMBERS SHALL NOT BE DRILLED, NOTCHED OR ALTERED IN ANY MANNER EXCEPT AS PROVIDED IN SECTIONS R502.8, R602.6, R802.7 AND R802.7.1 OF THE RESIDENTIAL CODE.

LOADING:

DEAD LOAD:

PER 301.4, THE ACTUAL WEIGHTS OF MATERIALS AND CONSTRUCTION SHALL BE USED FOR DETERMINING DEAD LOAD; THE FOLLOWING APPROXIMATIONS (IN PSF) ARE USED FOR THIS PROJECT:

USE:	PSF
WALL ASSEMBLY:	10
ROOF /CEILING ASSEMBLY:	20
FLOOR ASSEMBLY:	15
EXTERIOR DECK	0

ALL OF THE LOADS LISTED MAY NOT APPLY TO THE CURRENT PROJECT.

LIVE LOAD:

UNIFORMLY DISTRIBUTED LIVE LOADS SHALL BE PER TABLE R301.5 AND AS FOLLOWS* (IN PSF):

USE:	PSF	OTHER
UNINHABITABLE SPACE WITHOUT STORAGE:	10	(<42"H, 24"W)
UNINHABITABLE ATTICS W/LIMITED STORAGE:	20	
HABITABLE ATTICS & ATTICS W/FIXED STAIRS:	30	
EXTERIOR BALCONIES & DECKS:	40	
FIRE ESCAPES:	40	
GUARDS & HANDRAILS:	200	(CONCENTRATED)
GUARD IN-FILL COMPONENTS:	50	(HORIZONTAL)
PASSENGER VEHICLE GARAGE:	50	(&2,000LB/20SI)
ROOMS OTHER THAN SLEEPING ROOMS:	40	
SLEEPING ROOMS:	40	
STAIRS:	40	(& 300LB/4SI)
ROOF, PER 301.6 (INC. SNOW):	30	

*SOME OF THE LOADS LISTED ABOVE MAY BE HIGHER THAN THOSE REQUIRED PER CODE. ALL OF THE LOADS LISTED MAY NOT APPLY TO THE CURRENT PROJECT.

WIND LOADS SHALL BE BASED ON THE ULTIMATE DESIGN WIND SPEED LISTED IN TABLE 301.2(1) AND ADJUSTED FOR HEIGHT AND EXPOSURE): 120 MPH. WIND LOADS WILL BE ALLOWED FOR IN: THE DESIGN LOAD PERFORMANCE REQUIREMENTS

FOR WALL COVERINGS, ROOF COVERINGS, WINDOWS, SKYLIGHTS AND DOORS. COMPONENT AND CLADDING LOADS WILL BE PER TABLE R301.2(2)

			CLIMA	ATE AND (GEOGRAF	PHIC DES	IGN CR	ITERIA			•
		LOCA	ATION: TO	OWN OF G	REENWIC	CH	ZIF	CODE: 0	6878		
PER 2021	IRC OF CO	ONNECTIC	JT STATE,	TABLE 301.	2(1) (\	WIND) EXPO	SURE C	ATEGORY:	В С	LIMATE Z	ONE: 5A
	WIND	DESIGN		SUBJE	CT TO DAMAGE	FROM					
GROUND SNOW LOAD		WINDBORNE DEBRIS ZONE	SEISMIC DESIGN CATEGORY	WEATHERING	FROST LINE DEPTH	TERMITE	WINTER DESIGN TEMP	UNDERLMNT. REQUIRED	FLOOD HAZARDS	AIR FREEZING INDEX	MEAN ANNUAL TEMP
30 PSF	120	NO	В	SEVERE	3'-6"	MOD/HEAVY	7°F	YES	TO BE DETERMINATED	1500 OR LESS	50°F

THE CONTRACTOR SHALL:

DEMOLISH AND REMOVE ALL ELEMENTS NOTED IN THE DRAWINGS FOR DEMOLITION, AND AS REQUIRED FOR THE COMPLETION OF ALL WORK SHOWN ON THESE DRAWINGS.

ALLOW NO DEBRIS TO ACCUMULATE; HAUL AWAY FROM SITE ALL DEBRIS AT CONTRACTOR'S EXPENSE; REMOVE ALL DEBRIS ON A REGULAR BASIS AND MAINTAIN JOBSITE IN A CLEAN AND TIDY CONDITION.

FULLY PROTECT ALL STRUCTURES, BUILDING ELEMENTS, EQUIPMENT, APPLIANCES AND FINISHES THAT ARE TO REMAIN FROM DAMAGE CAUSED BY ANY OF THE CONTRACTOR'S ACTIVITIES.

PROTECT ALL ADJACENT AREAS, AND ALL NEIGHBORING PROPERTY, FROM DAMAGE, INJURY AND DISCOMFORT CAUSED BY DUST.

ACCUMULATION OF DEBRIS. DUST OR RUBBISH IN ANY PUBLIC AREA. ASSUME FULL RESPONSIBILITY FOR ANY DAMAGE CAUSED TO EXISTING ELEMENTS AND MAKE

PROTECT ALL PUBLIC PROPERTIES AND PREMISES FROM DAMAGE AND PREVENT ANY

REPAIRS REQUIRED WITHOUT ADDITIONAL COST TO THE OWNER. CONDUCT ALL DEMOLITION OPERATIONS IN SUCH A MANNER AS TO PREVENT UNAUTHORIZED ENTRY OF ANY PERSONS AT ANY TIME; POST APPROPRIATE SIGNAGE AS REQUIRED.

LOCATE ALL UTILITY AND DRAINAGE LINES PRIOR TO COMMENCEMENT OF DEMOLITION AND PROTECT ALL ACTIVE LINES AS REQUIRED. IDENTIFY CLEARLY ANY WORK THAT MAY RESULT IN THE INTERRUPTION OF ANY SERVICES WITHIN THE AREA OF WORK OR IN ANY ADJACENT SPACE OR PROPERTY AND COORDINATE SUCH INTERRUPTIONS WITH ALL INVOLVED PARTIES.

NOTIFY THE OWNER, UTILITY COMPANIES, FIRE DEPARTMENT, ALARM COMPANIES, ETC OF ANY WORK AFFECTING THEIR SYSTEMS AS REQUIRED BY ALL APPLICABLE CODES, RULES, AND REGULATIONS.

SITE WORK

EXCAVATION SAFETY:

THE CONTRACTOR SHALL COMPLY WITH THE TRENCHING AND EXCAVATION REQUIREMENTS OF 29 CFR 1926.651 AND 1926.652 OR COMPARABLE OSHA-APPROVED STATE PLAN REQUIREMENTS.

TRENCHES 5 FEET DEEP OR GREATER REQUIRE A PROTECTIVE SYSTEM UNLESS THE EXCAVATION OF THE EXCAVATION OF

MADE ENTIRELY IN STABLE ROCK. THE CONTRACTOR SHALL HAVE A COMPETENT PERSON INSPECT EXCAMALIS D. Y AND AS CONDITIONS CHANGE TO ENSURE ELIMINATION OF EXCAVATION HA. U.S.

A COMPETENT PERSON IS AN INDIVIDUAL WHO IS CAPABLE (FINT ING F JTIN IND PREDICTABLE HAZARDS OR WORKING CONDITIONS ARI I, ARL JASANITA CONTINUES DANGEROUS TO WORKERS, SOIL TYPES PROTE \ SY E RE TIRED, AND V . JIS AUTHORIZED TO TAKE PROTESSION CORRECT AND SELECTION OF THE SE HAZARDS AND CONDITIONS.

EXCAVATION - LOCATING UTILITIES AL

CONFIRM:

CONNECTICUT STATE LAW PC .AT 753) REQUIRES ALL EXCAVATO .5 1 F A A LOC ATION REQUEST WITH DIG SAFELY NEW YORK AT LEAST TWO (2) FULL V ORKII 3 DA S, PUT NO MORE THAN 10 WORKING DAYS BEFORE BEGINNING AN EXCAVATION 1 ROJECT IN ORL TO ENSURE ALL UNDERGROUND UTILITY LINES ARE PROPERTY I ARKL D.B. THEIR CWNERS.

A LOCATION REQUEST MAY BE PLACED, AND THE NOT JESS OF MARKING LINDENGROUND THE TOTAL THE NOTATION REQUEST MAY BE PLACED, AND THE NOT JESS OF MARKING LINDENGROUND THE NOTATION REQUEST. MAY BE TRACKED, BY USING THE ONLINE LOCATION REQUEST PROORAL E CONT. THE EXCAVATOR MAY CALL 811 TO PLACE THE LOCATION REQUISITION

NOTIFY 811 ONLINE WHEN ALLING 811 NOTIFY: AT LEAST TWO DAYS FOR THE LES TO RESPOND (NOT INC. THE DAY YOU CALL). WAIT:

CHECK ALL UTILITIES HAVE RESPONDED

ADHERE TO UTILITY MARKS AND FLAGS. RESPECT: DIG WITH CAUTION: DIG CAREFULLY AROUND BURIED UTILITIES.

CONCRETE

STRUCTURAL CONCRETE AND CONCRETING PRACTICES SHALL CONFORM WITH THE LATEST EDITION OF ACI 318, BUILDING CODE REQUIREMENTS FOR STRUCTURAL CONCRETE, ISSUED AND MAINTAINED BY THE AMERICAN CONCRETE INSTITUTE, AND AS NOTED BELOW.

ALL ACI REQUIREMENTS FOR HOT AND COLD WEATHERING CONCRETE MUST BE ADHERED TO.

CONCRETE SHALL HAVE A MINIMUM. COMPRESSIVE STRENGTH AT 28 DAYS AS FOLLOWS UNLESS OTHERWISE NOTED ON THE DRAWINGS: FOUNDATION WALLS, BUTTRESSES, SLAB ON GRADE: 4000 PSI, NORMAL WEIGHT FOOTINGS AND PIERS: 4000 PSI, NORMAL WEIGHT CONCRETE ON METAL DECK: 4000 PSI, NORMAL WEIGHT

ALL EXPOSED CONCRETE SHALL HAVE AN AIR ENTRAINING AGENT.

ALL CONCRETE EXPOSED TO WEATHER OR EARTH:

ALL CONCRETE PLACED AGAINST EARTH:

MINIMUM CONCRETE COVER SHALL BE AS FOLLOWS, UNLESS NOTED OTHERWISE ON THE DRAWINGS:

4000 PSI, NORMAL WEIGHT

REINFORCING STEEL:

ALL OTHER CONCRETE:

DETAILS SHALL BE IN ACCORDANCE WITH ACI-315, DETAILS AND DETAILING OF CONCRETE REINFORCEMENT UNLESS OTHERWISE NOTED ON THE DRAWINGS.

ALL REINFORCING BARS SHALL CONFORM TO ASTM A615, GRADE 60 UNLESS REQUIRED TO BE WELDED AS SHOWN ON PLANS.

ALL REINFORCING BARS REQUIRED TO BE WELDED SHALL CONFORM TO ASTM A706, GRADE 50.

WELDED WIRE FABRIC SHALL CONFORM TO ASTM A185. SUPPORT WIRE FABRIC WITH CHAIRS OR LIFTS DURING CONCRETE PLACEMENT TO INSURE PROPER POSITION IN SLAB.


ALL REINFORCEMENT SHALL BE SECURELY HELD IN PLACE WHILE PLACING CONCRETE. IF REQUIRED. ADDITIONAL BARS OR STIRRUPS SHALL BE PROVIDED BY THE CONTRACTOR TO FURNISH SUPPORT FOR ALL BARS. REINFORCEMENT SHALL BE SECURED IN THE PROPER LOCATION IN THE FORMS WITH TIE WIRE OR OTHER BAR SUPPORT SYSTEM TO PREVENT DISPLACEMENT DURING THE CONCRETE PLACEMENT OPERATION.

WHERE NOT SPECIFICALLY INDICATED ON THE DRAWINGS, SPLICING & EMBEDMENTS SHALL BE IN ACCORDANCE TABLE R608.5.4(1) LAP SPLICE AND TENSION DEVELOPMENT LENGTHS

TRUSS TYPE CONSTRUCTION

THE UTILIZATION OF TRUSS-TYPE CONSTRUCTION, PRE-ENGINEERED WOOD CONSTRUCTION AND/OR TIMBER CONSTRUCTION IN RESIDENTIAL STRUCTURES IS SUBJECT TO THE REQUIREMENTS OF TITLE 19 OF THE NEW YORK CODES, RULES AND REGULATIONS (IRC), PART 1265: ANY PERSON UTILIZING TRUSS TYPE, PRE-ENGINEERED WOOD OR TIMBER CONSTRUCTION FOR THE ERECTION OF ANY NEW RESIDENTIAL STRUCTURE, FOR ANY ADDITION TO AN EXISTING RESIDENTIAL

STRUCTURE, OR FOR ANY REHABILITATION OF AN EXISTING RESIDENTIAL STRUCTURE, SHALL, UPON APPLICATION FOR A BUILDING PERMIT WITH THE LOCAL GOVERNMENT HAVING JURISDICTION, INCLUDE ON THE PERMIT APPLICATION THAT TRUSS TYPE, PRE-ENGINEERED WOOD OR TIMBER CONSTRUCTION IS BEING UTILIZED, AND THAT THE PROPERTY OWNER OR THE PROPERTY OWNER'S REPRESENTATIVE SHALL COMPLETE A FORM PRESCRIBED BY THE STATE FIRE PREVENTION AND BUILDING CODE COUNCIL (HEREINAFTER REFERRED TO AS THE CODE COUNCIL) DESIGNATING THE STRUCTURE AS TRUSS TYPE, PRE-ENGINEERED WOOD OR TIMBER CONSTRUCTION AND FILE SUCH FORM WITH THE APPLICATION FOR A BUILDING PERMIT.

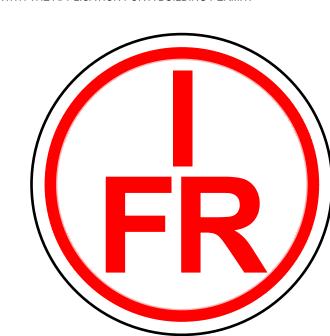

REQUIRED SIGN:

REQUIRED SIGN:

HOWEVER.

AS A CONDITION OF THE RECEIPT OF A CERTIFICATE OF OCCUPANCY, A SIGN OR SYMBOL DESIGNED AND APPROVED BY THE CODE COUNCIL SHALL B FFIXED TO THE ELECTRIC BOX ATTACHED TO THE EXTERIOR OF THE RESIDENTIAL STRUCI. PF /IDED.

IF AFFIXING THE SIGN (SYN)L TO THE ELECTIC BOX WOULD OBSCURE ANY METER ON THE ELECTRIC BO. 3 IF THE UTIL PROVIDING EL TRIC SERVICE TO THE RESIDENTIAL STRUCTURE ALL 'S S. OR MBOL TO BE ALL YED TO THE ELECTRIC BOX, THE SIGN OR MBOL LL. A. 15 TO 1 EXTER OR WALL OF THE RESIDENTIAL STRUCTURE AT A POINT MEDIATE AD. CEN. HEL TRIC BOX, AND: VO ELECT : BU IS AT I. HED TO THE EXTERIOR OF THE RESIDENTIAL STRUCTURE OR IF, IN THE ION OF LEAU LORITY HAVING JURISDICTION, THE ELECTRIC BOX ATTACHED TO THE EXTERIOR

ING IS NOT LOCATED IN A PLACE LICELY TO BE SEEN BY FIREFIGHTERS OR OTHER FIRST

RESPONDERS RESPONDING TO A FIRE OF OTHER FINE GENCY AT THE RESIDENTIAL STRUCTURE,

THE SIGN OR SYMBOL SHALL BLATFIX D. TO THE ELYTERIOR OF THE STRUCTURE IN A LOCATION APPROVED BY THE BUILTING OFFI VAL FILL FOWN OF GREENWICH AS A LOCATION LIKELY TO BE

SEEN BY FIRSTIG TELLS CROTHER IRST RESPONDERS RESPONDING TO A FIRE OR OTHER

EMF. IN YA TI FRI SIDE I IAL STRUCTURE. STATEMENT OF DESIGN PROFESSIONAL:

THESE PLANS HAVE BEEN PREPARED IN CONFORMANCE WITH THE 2021 RESIDENTIAL CODE OF STATE

VINCENT COAKLEY, P.E. (STAMP AFFIXED AND SIGNED).

LIST OF STRUCTURAL DRAWINGS						
VISION	REV	DATE	DRAWING NAME	SHEET		
08.2024	11.0	11.21.2023	COVER SHEET	C-01		
08.2024	11.0	11.21.2023	BASEMENT	S-01		
08.2024	11.0	11.21.2023	FIRST FLOOR	S-02		
08.2024	11.0	11.21.2023	SECOND FLOOR	S-03		
08.2024	11.0	11.21.2023	ROOF FRAMING	S-04		
08.2024	11.0	11.21.2023	FRAMING DETAILS	S-05		
(11.	11.21.2023	FRAMING DETAILS	S-05		

O a ö

PROPERTY ADDRESS:

GREENWICH, CT 06878 (TOWN OF GREENWICH BUILDING DEPARTMENT)

TAX ID:

CLIENT:

DATE: ISSUE: 11.21.2023

05.28.2024 FOR PERMIT

11.08.2024 FOR CONSTRUCTION

STRUCTURAL DESIGN &

DRAWING NAME:

COVER SHEET

PROJECT NAME:


DRAWINGS

DRAWING NUMBER:

SCALE: **AS NOTED**

C.01

THIS DRAWING IS VALID FOR CONSTRUCTION IF (AND ONLY IF) A PERMIT IS ISSUED, BASED ON THIS DRAWING, BY THE TOWN OF GREENWICH.

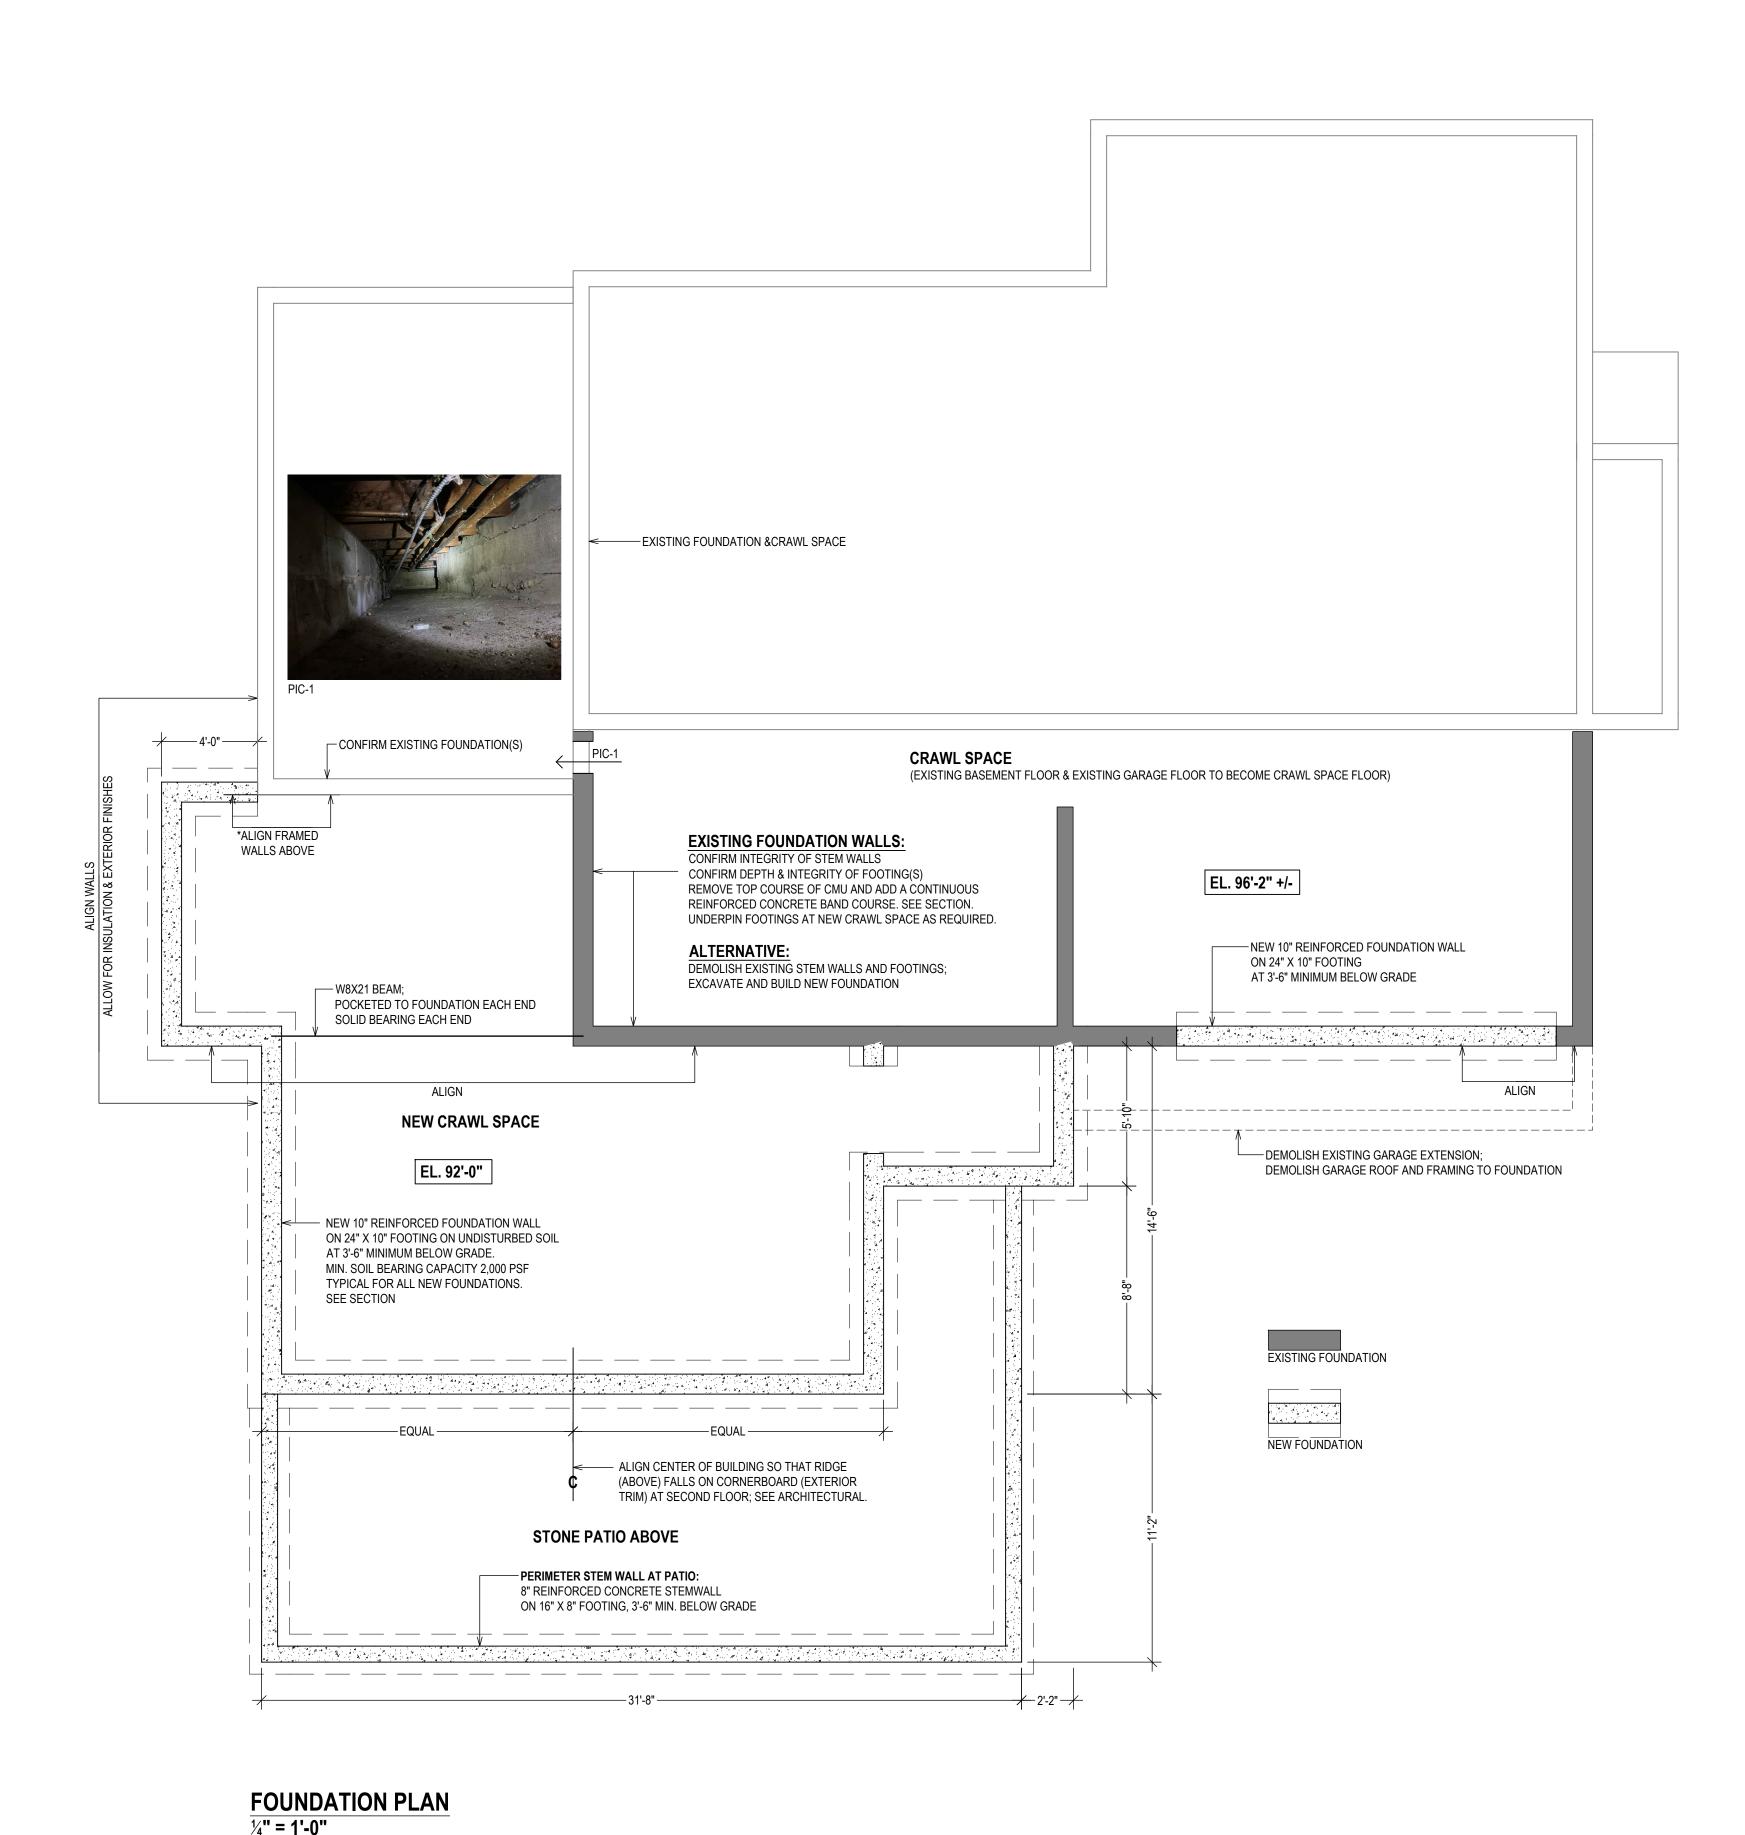

TYPICAL MUD SILL: -DOUBLE 2X6 PRESSURE TREATED MUD SILL LAP JOINTS MIN. 3'-0" NEW BAND COURSE: 1/2" GALVANIZED ANCHOR BOLTS W/NUTS & WASHERS: 10" HIGH REINFORCED CONCRETE BAND COTURSE MAX. 3'-0" CENTERS 3,000 PSI CONCRETE; SEE CONCRETE GENERAL NOTES MAX. 1'-0" FROM EACH END REBAR: (1) 3'-0" LONG #5 BARS VERTICAL @ 3'-0" ON CENTER MIN. TWO PER PIECE BONDED INTO FILLED CELL IN EXISTING CMU MINIMUM EMBEDMENT LENGTH 12" (2) #5 BARS HORIZONTAL SEE GENERAL NOTES FOR STEEL GRADE, COVER, LAPS AND INSTALLATION; ALL STEEL TO BE IN ACCORDANCE WITH ACI 318; TYPICAL RETROFIT FOR ALL EXISTING FOUNDATION WALLS. CRAWL SPACE FLOOR SLAB: EXISTING CONCRETE SLAB; CONDITION UNKNOWN CONFIRM STABILITY, INTEGRITY AND CONDITION OF EXISTING FOOTING(S)

SECTION AT EXISTING FOUNDATION

γ2^{"= 1'-0"}
COORDINATE ALL DIMENSIONS WITH ARCHITECTURAL;
PROVIDE THERMAL AND MOISTURE PROTECTION PER ARCHITECTURAL DRAWINGS.

TYPICAL MUD SILL: DOUBLE 2X6 PRESSURE TREATED MUD SILL LAP JOINTS MIN. 3'-0" $\frac{1}{2}$ " GALVANIZED ANCHOR BOLTS W/NUTS & WASHERS: MAX. 3'-0" CENTERS MAX. 1'-0" FROM EACH END MIN. TWO PER PIECE MINIMUM EMBEDMENT LENGTH 12" -FOUNDATION WALL: TYPICAL WATERPROOFING: 10" REINFORCED CONCRETE FOUNDATION WALL AS FOLLOWS: 10" WIDE, 3,000 PSI CONCRETE; SEE CONCRETE GENERAL NOTES TUFF-N-DRI SYSTEM* OR EQUAL PER MANUFACTURERS REINFORCEMENT EACH FACE: INSTRUCTIONS #5 BARS VERTICAL @ 3'-0" ON CENTER FOUNDATION WATERPROOFING; #5 BARS HORIZONTAL @ 3'-0" O.C. FROM GRADE TO HIGHER OF TOP OF FOOTING OR 6" BELOW THE INC. ONE BAR WITHIN 1'-0" OF TOP OF WALL. TOP OF THE BASEMENT FLOOR SEE GENERAL NOTES FOR STEEL GRADE, COVER, LAPS AND INSTALLATION; ALL STEEL TO BE IN ACCORDANCE WITH ACI 318; TYPICAL FOR ALL FOUNDATION WALLS. TYPICAL - CRAWL SPACE FLOOR SLAB: 4" CONCRETE SLAB W/6X6 10/10 WWM AND **TYPICAL FOOTING DRAIN:** MIN VAPOR BARRIER ON 6" GRAVEL 4" PERFORATED PVC PIPE; WITH FILTER FABRIC; DISCHARGE TO SITE DRAINAGE SYSTEM TYPICAL FOOTING: 1" WASHED GRAVEL & FILTER MEMBRANE — 24"X12" STRIP FOOTING; THREE #5 BARS LONGTITUDINAL; TRANSVERSE BARS @ 4'-0"; ON UNDISTURBED SOIL WITH MINIMUM BEARING CAPACITY OF 2,000 PSF; PROVIDE 2X4 KEY; TYPICAL FOR ALL FOUNDATION FOOTINGS.

SECTION AT NEW FOUNDATION

/2"= 1'-0"
COORDINATE ALL DIMENSIONS WITH ARCHITECTURAL;
PROVIDE THERMAL AND MOISTURE PROTECTION PER ARCHITECTURAL DRAWINGS.

STEM WALL:
8" WIDE, 3,000 PSI CONCRETE STEM WALL:
8EEARR #5 BARS VERTICAL @ 3-0" ON CENTER; #5 BARS HORTOTAL @ 3-0" ON CENTER SLAB WISK\$ 10/10 WWM
ALL STEP" BE IN: CORDA WIT: 1318;
TYP: OR A. ATIO POLIETE LLS.

CONNECTED BACKFILL TYPICAL

FO TIN:

10 JUNISTURBED SOIL WITH MINIMALM BEARING CAPACITY OF 2 000 PSP;
PROVIDE 21/4 KEY; TYPICAL FOR ALL PATIO PERIMETER FOOTINGS.

11 JUNISTURBED SOIL WITH MINIMAL BEARING CAPACITY OF 2 000 PSP;
PROVIDE 21/4 KEY; TYPICAL FOR ALL PATIO PERIMETER FOOTINGS.

PROPERTY ADDRESS:

***,

GREENWICH, CT 06878
(TOWN OF GREENWICH BUILDING DEPARTMENT)

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TAX ID: ***

CLIENT: *** *** ***

DATE: ISSUE:
11.21.2023
05.28.2024 FOR PERMIT

PROJECT NAME: STRUCTURAL DESIGN & DRAWINGS

DRAWING NAME:
BASEMENT


DRAWING NUMBER: **S.01**

SCALE:
AS NOTED

THIS DRAWING IS VALID FOR
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GREENWICH.

THIS DRAWING IS AS A SAMPLE ONLY

** PERSONAL (CLIENT) INFORMATION WITHHELD

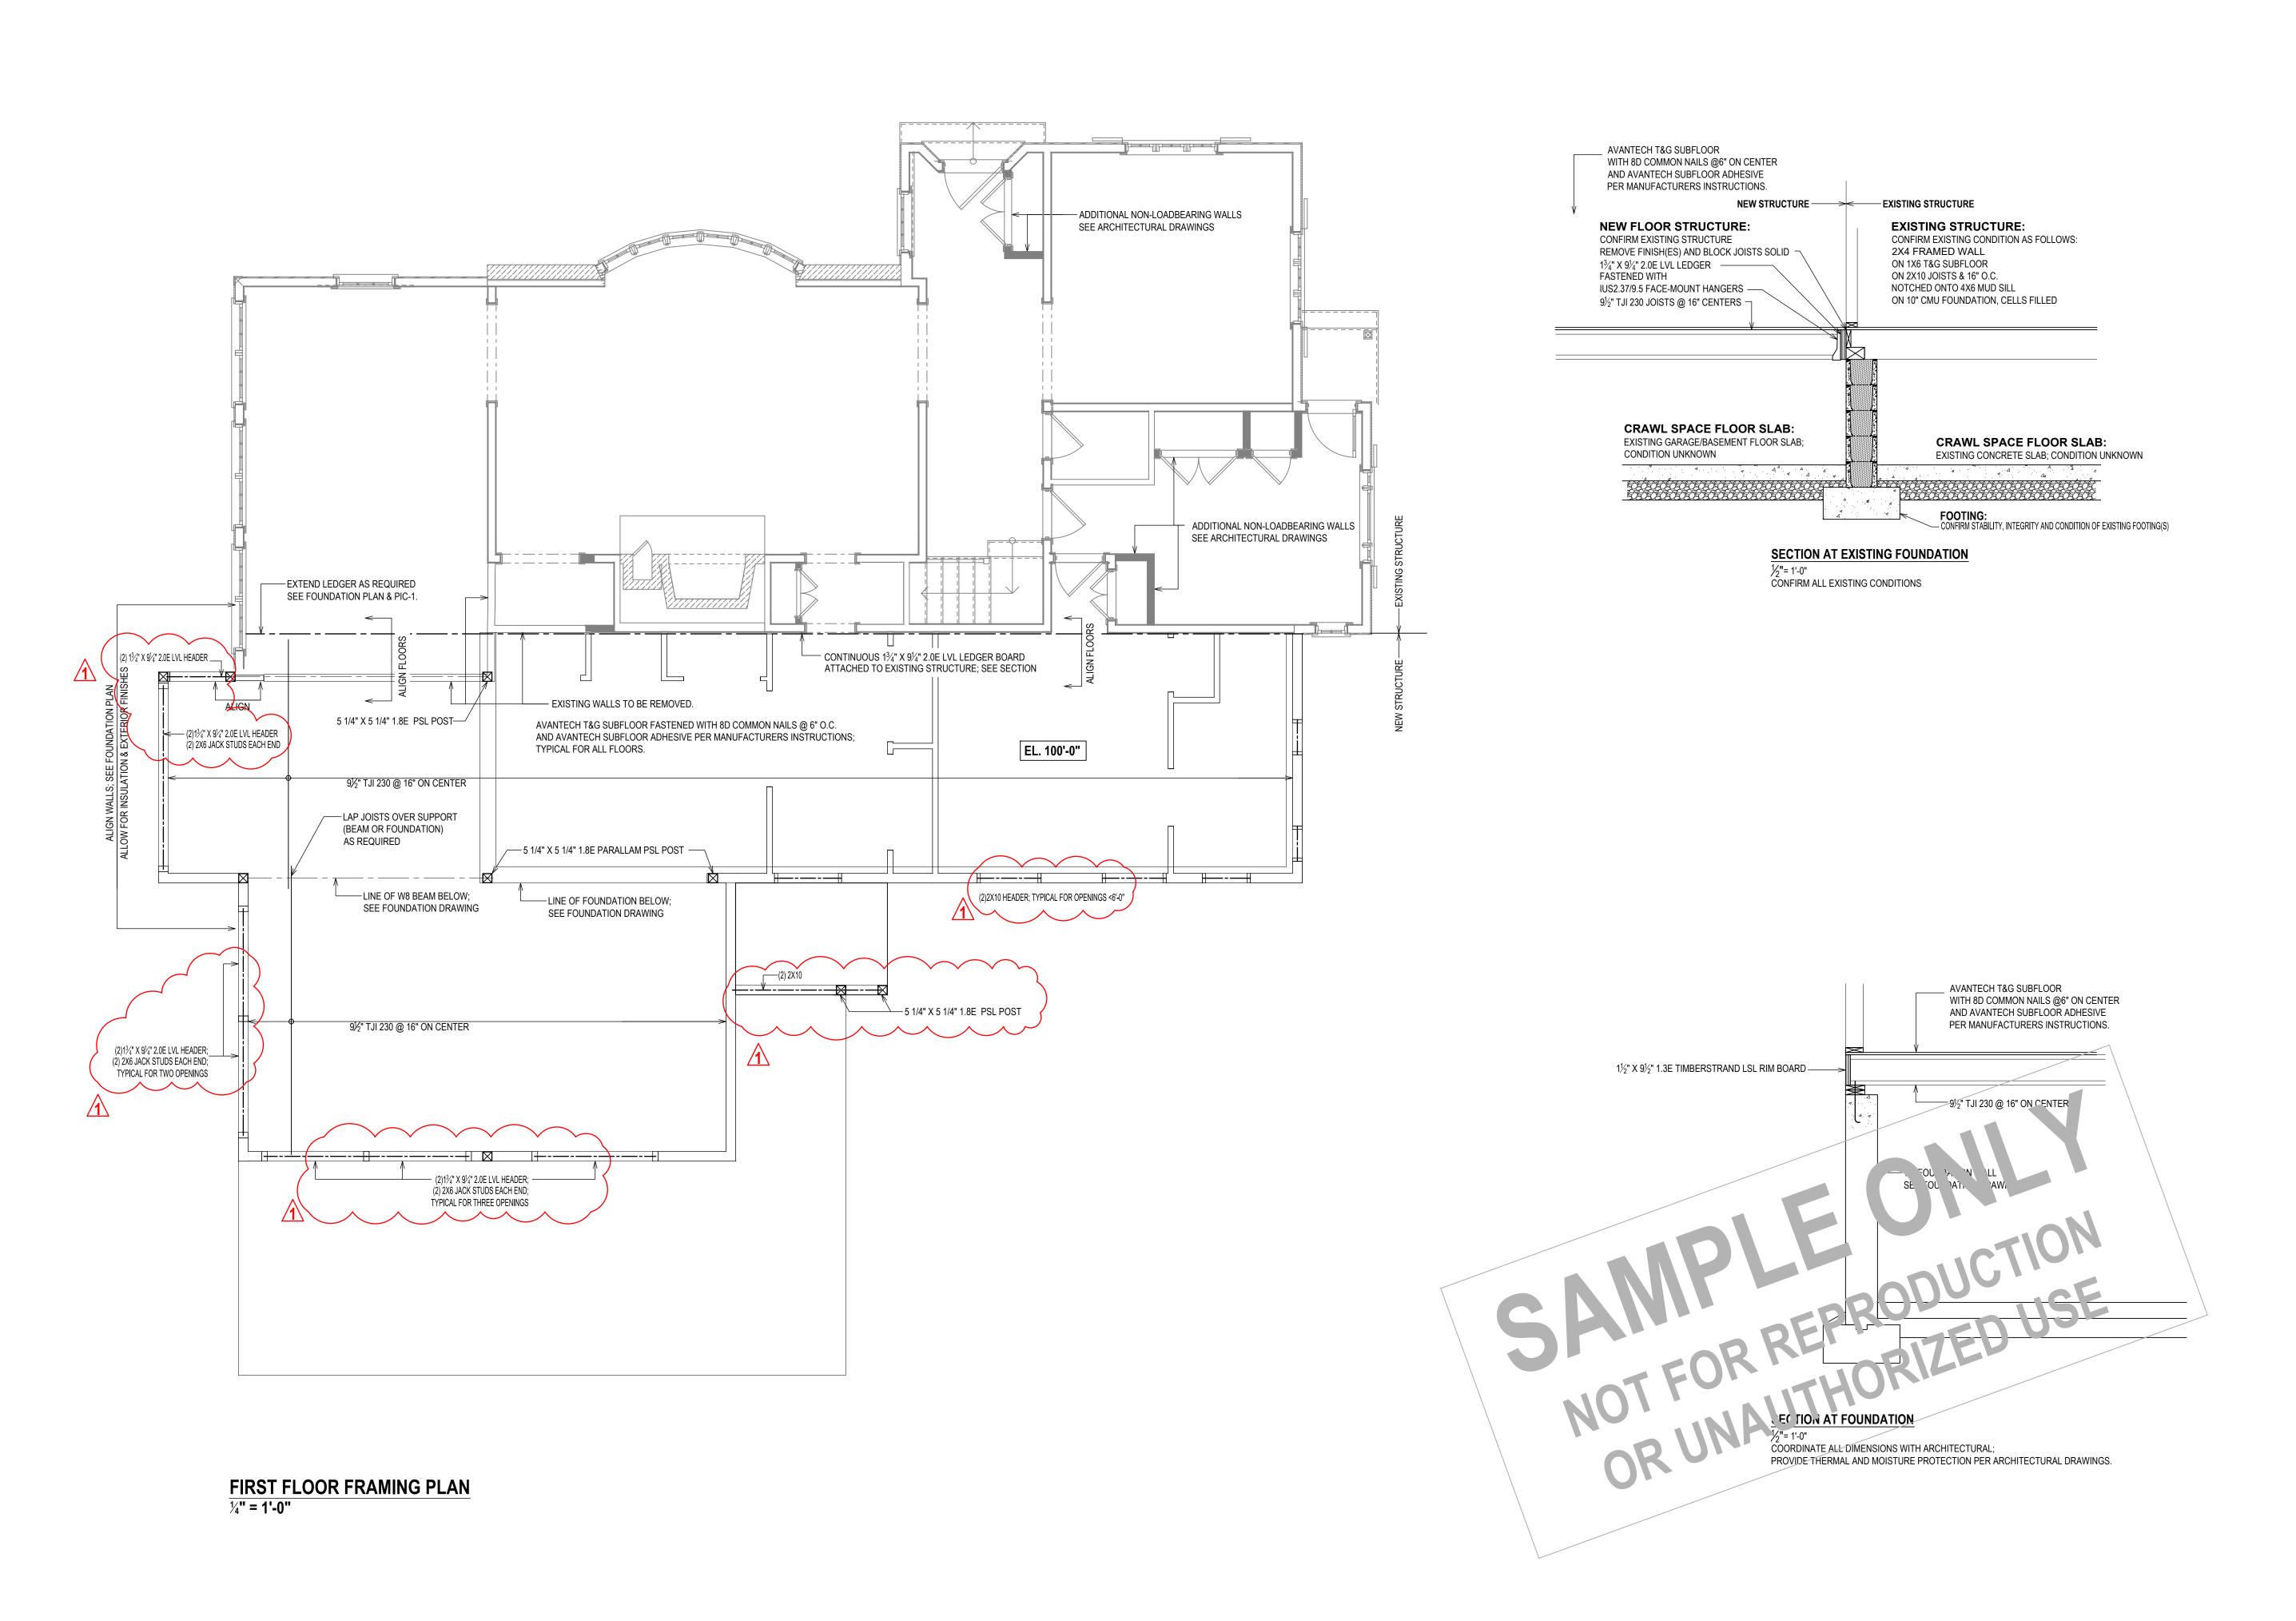

PROPERTY ADDRESS:

GREENWICH, CT 06878
(TOWN OF GREENWICH BUILDING DEPARTMENT)

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TAX ID:

CLIENT: *** ***

DATE: ISSUE: 11.21.2023 05.28.2024 FOR PERMIT

11.08.2024 FOR CONSTRUCTION


PROJECT NAME: STRUCTURAL DESIGN & DRAWINGS

DRAWING NAME: FIRST FLOOR

DRAWING NUMBER: **S.02**

SCALE: AS NOTED

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***,

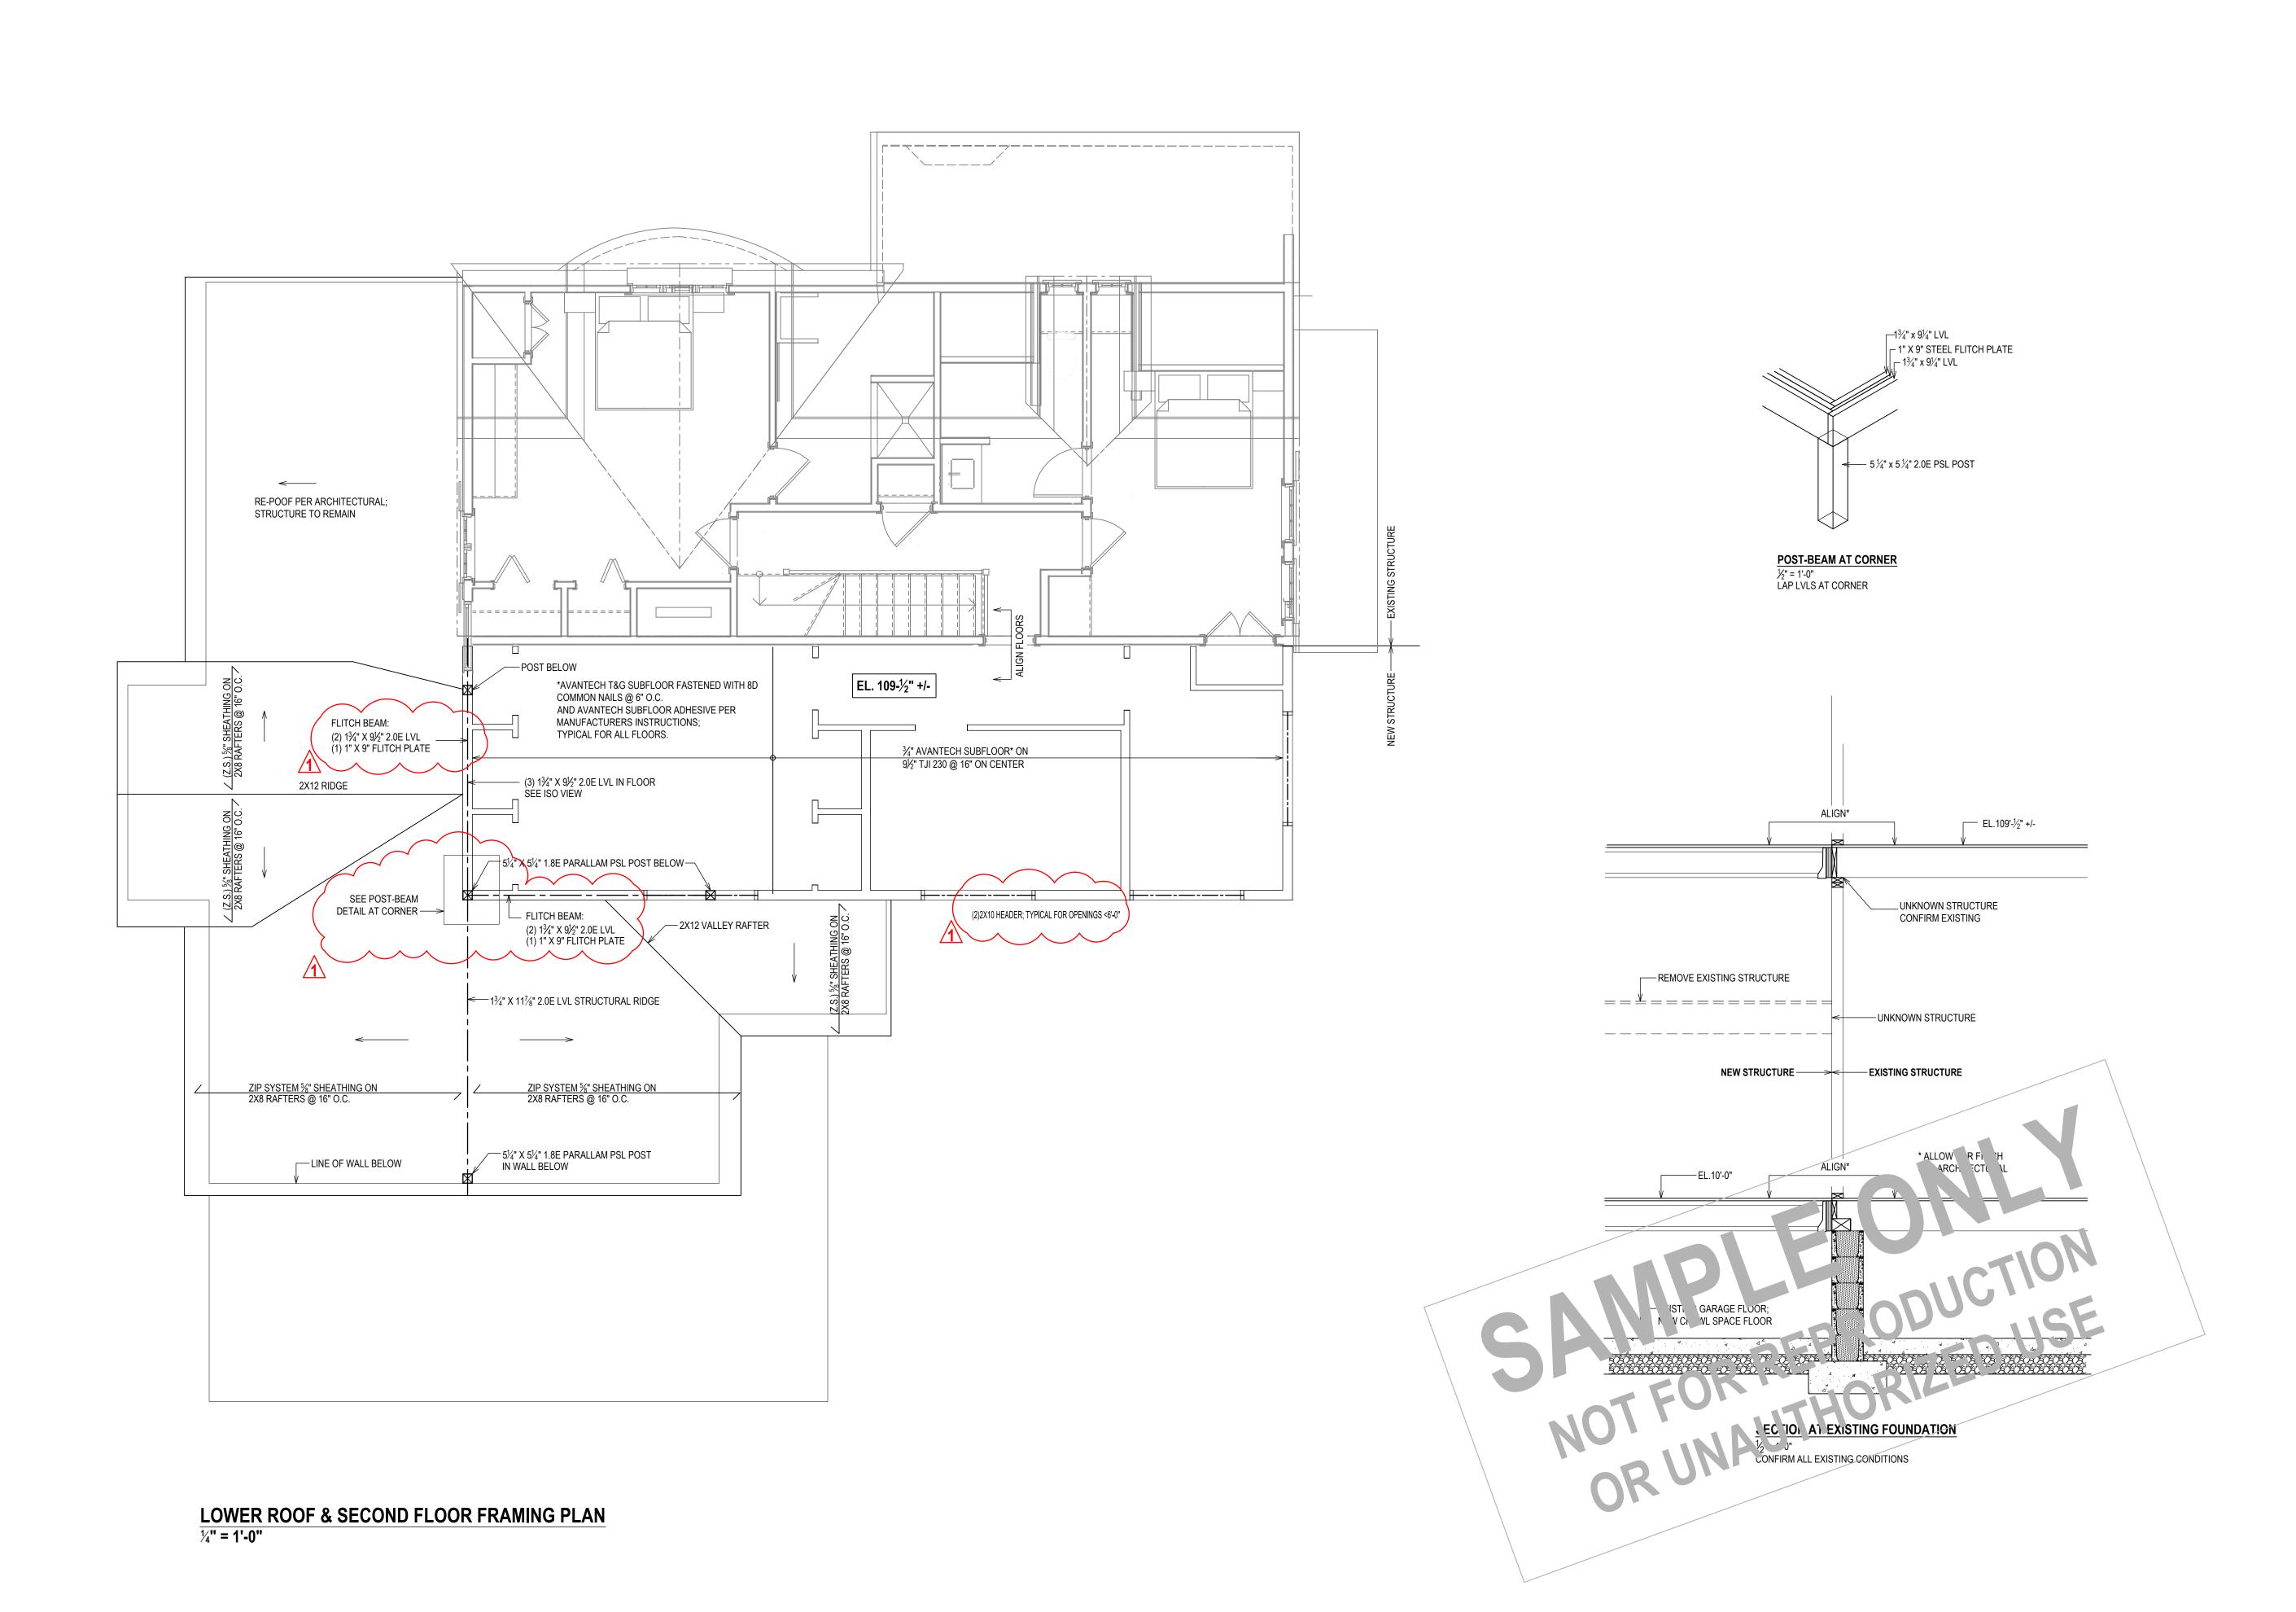GREENWICH, CT 06878 (TOWN OF GREENWICH BUILDING DEPARTMENT)

TAX ID: ***

CLIENT: *** ***

DATE: ISSUE:

11.21.2023 05.28.2024 FOR PERMIT

11.08.2024 FOR CONSTRUCTION

PROJECT NAME:

STRUCTURAL DESIGN & DRAWINGS

DRAWING NAME:
SECOND FLOOR

DRAWING NUMBER: **S.03**

SCALE: AS NOTED

NOTE:
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EXISTING ROOFTO REMAIN -RIDGE TO REMAIN LINE OF WALL BELOW ROOF BELOW SEE SECOND FLOOR ROOF FRAMING PLAN /4" = 1'-0"

Chris Snyder Arcihitecture & Design

21 Quintard Avenue, Unit 1A

Norwalk, CT 06854

(603) 667-6924

Coliver Engineering, P.C.

Design - Permit Applications - Legalizations

Code Compliance - Project Supervision

188 North Main Street | Port Chester | NY 10573

PROPERTY ADDRESS: ***.

GREENWICH, CT 06878
(TOWN OF GREENWICH BUILDING DEPARTMENT)

TAX ID: ***

CLIENT: *** ***

DATE: ISSUE: 11.21.2023 05.28.2024 FOR PERMIT

PROJECT NAME:
STRUCTURAL DESIGN &
DRAWINGS

DRAWING NAME:
ROOF FRAMING

DRAWING NUMBER: **S.04**

SCALE: AS NOTED

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