



LOCATION
GOOGLE MAPS

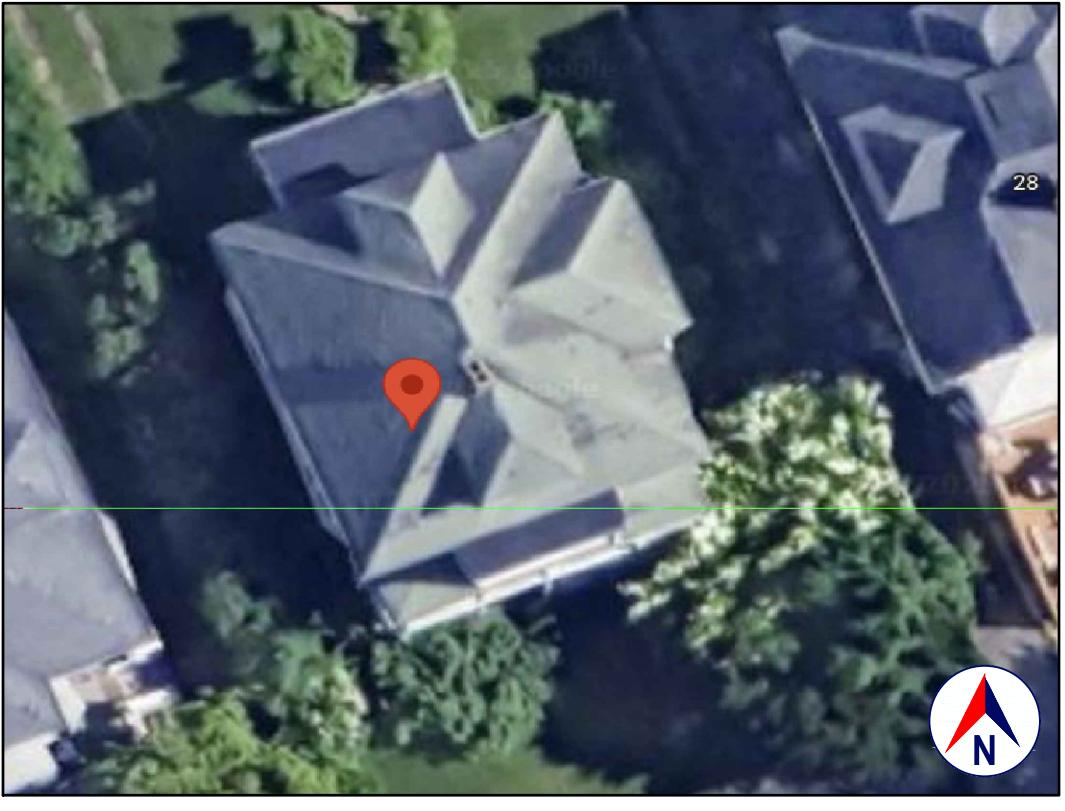

SATELLITE VIEW
GOOGLE EARTH

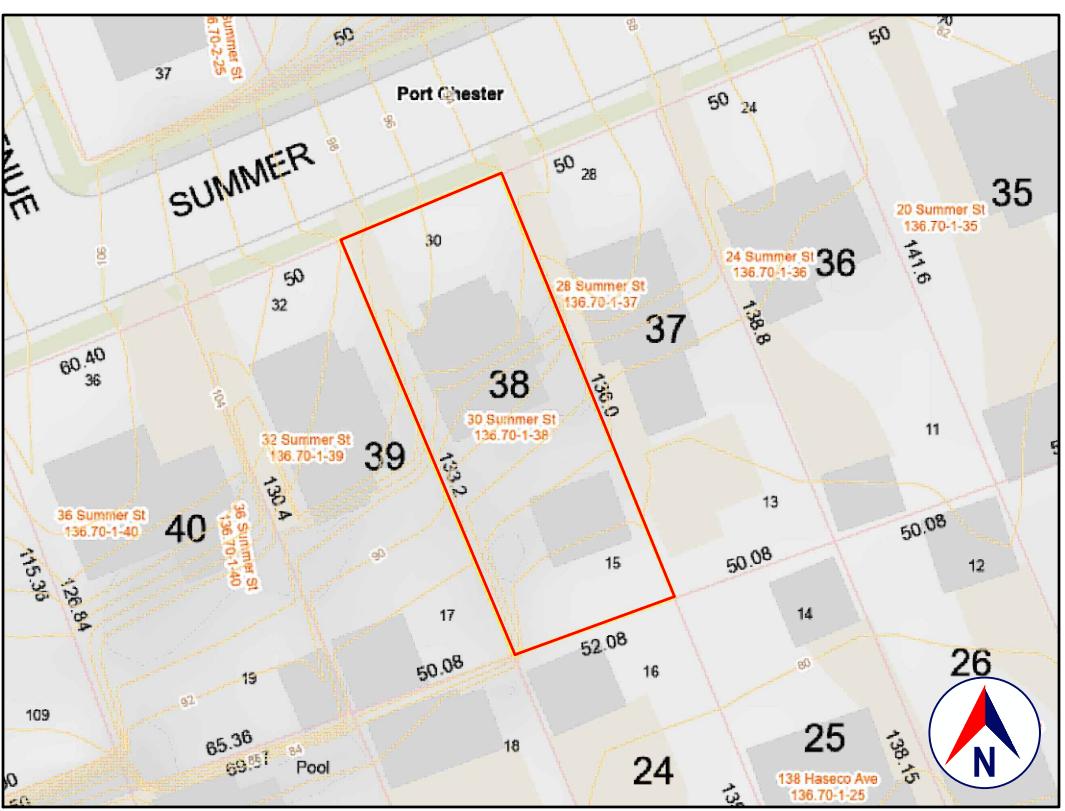

TAX MAP AND TOPO
WESTCHESTER COUNTY GIS



FRONT VIEW
GOOGLE STREET VIEW

1.0 GENERAL REQUIREMENTS:

1.1 PROJECT SCOPE:
 REPLACE/REBUILD FRONT PORCH (TWO FLOORS); REPLACE/REBUILD REAR PORCH; ADD DECK(S); ALTER FLOOR PLAN; ADD POWDER ROOM; REFISH INTERIOR.

1.2 DESIGN INTENT:
 THE INVOLVEMENT OF OLIVER ENGINEERING IN THIS PROJECT IS; PROVIDE DESIGN AND DRAWINGS.

IT IS THE INTENT OF THESE DRAWINGS TO CALL FOR COMPLETE AND FINISHED WORK IN COMPLIANCE WITH THE NOTED CODES, AND TESTED AND GUARANTEED AND READY FOR OPERATION.

THE ENGINEER HAS NOT BEEN ENGAGED TO SUPERVISE ANY WORK AND DOES NOT HAVE CONTROL OR CHARGE OF, AND SHALL NOT BE RESPONSIBLE FOR, CONSTRUCTION MEANS, METHODS, TECHNIQUES, SEQUENCES OR PROCEDURES, FOR SAFETY PRECAUTIONS AND PROGRAMS IN CONNECTION WITH THE WORK, FOR THE ACTS OR OMISSIONS OF THE CONTRACTOR, SUBCONTRACTOR, OR ANY OTHER PERSONS PERFORMING ANY OF THE WORK, OR FOR THE FAILURE OF ANY OF THEM TO CARRY OUT THE WORK IN ACCORDANCE WITH THE CONTRACT DOCUMENTS.

1.3 EXISTING CONSTRUCTION TYPE:
 THE EXISTING BUILDING, PER THE BUILDING CODE OF NEW YORK STATE, TABLE 601 IS CONSTRUCTION TYPE VB - CONSTRUCTION WHERE THE PRIMARY ELEMENTS ARE NOT REQUIRED TO BE FIRE RESISTANT.

1.4 CLASSIFICATION OF PROPOSED WORK:
 THIS IS A PROPOSED ALTERATION LEVEL 2, AS DEFINED IN THE EXISTING BUILDING CODE, SECTION 603.1 (MAY INCLUDE THE RECONFIGURATION OF SPACE, THE ADDITION OR ELIMINATION OF ANY DOOR OR WINDOW, THE RECONFIGURATION OR EXTENSION OF ANY SYSTEM, OR THE INSTALLATION OF ANY ADDITIONAL EQUIPMENT), AND SHALL COMPLY WITH THE PROVISIONS OF CHAPTERS 7 AND 8 OF THAT CODE.

1.5 ZONING, OCCUPANCY AND USE:
 INSIDE/OUTSIDE: INSIDE AND OUTSIDE
 YEAR BUILT: 1910 (PER ZILLOW)
 ZONING: RS ONE FAMILY RESIDENCE
 OCCUPANCY CLASSIFICATION: RESIDENTIAL GROUP R-3*
 EXISTING USE: SINGLE FAMILY
 PROPOSED USE: SINGLE FAMILY (NO CHANGE)

* WHERE THE OCCUPANTS ARE PRIMARILY PERMANENT IN NATURE AND NOT CLASSIFIED AS OCCUPANCY GROUP R-1, R-2, R-4 OR I, INCLUDING BUILDINGS THAT DO NOT CONTAIN MORE THAN TWO DWELLING UNITS.

1.6 COMPLIANCE:
 ALL WORK SHALL BE IN COMPLIANCE WITH THE FOLLOWING CODES:

- GENERAL: 2020 RESIDENTIAL CODE OF NEW YORK STATE (INTERNATIONAL RESIDENTIAL CODE 2018 WITH AMENDMENTS)
- EXISTING: BUILDING CODE OF NEW YORK STATE (INTERNATIONAL EXISTING BUILDING CODE 2017 WITH AMENDMENTS)
- ENERGY: ENERGY CONSERVATION CONSTRUCTION CODE OF NEW YORK STATE 2020 (INTERNATIONAL ENERGY CONSERVATION CODE 2019)
- PLUMBING: PART VI - PLUMBING OF THE 2020 RESIDENTIAL CODE OF NEW YORK STATE (INTERNATIONAL RESIDENTIAL CODE 2018 WITH AMENDMENTS)
- ELECTRICAL: THE 2017 NATIONAL ELECTRICAL CODE (NEPA 70-2017)
- DRAINAGE: NOT APPLICABLE TO THESE DRAWINGS
- MUNICIPAL: CHAPTER 151, BUILDING CODE ADMINISTRATION AND ENFORCEMENT OF THE CODE OF THE VILLAGE OF PORT CHESTER
- OTHER: ALL REFERENCED CODES, OTHER CODES AND REGULATIONS, FEDERAL, STATE AND LOCAL, THAT MAY APPLY.

1.7 AUTHORITY HAVING JURISDICTION:
 THE AUTHORITY HAVING JURISDICTION, AS DEFINED IN SECTION 103.1 OF THE RESIDENTIAL CODE, AND WHICH SHALL PROVIDE FOR ADMINISTRATION AND ENFORCEMENT OF THE UNIFORM CODE AND ENERGY CODE BY LOCAL LAW, ORDINANCE, OTHER APPROPRIATE REGULATION, OR COMBINATION THEREOF, IS THE VILLAGE OF PORT CHESTER.

THE DULY APPOINTED BUILDING OFFICIAL OF THE VILLAGE OF PORT CHESTER IS AUTHORIZED TO ENFORCE THE PROVISIONS OF THE CODE.

THE BUILDING OFFICIAL MAY ADOPT POLICIES AND PROCEDURES IN ORDER TO CLARIFY THE APPLICATION OF THE PROVISIONS OF THE CODE. SUCH POLICIES AND PROCEDURES SHALL BE IN COMPLIANCE WITH THE INTENT AND PURPOSE OF THE CODE.

2.0 DESIGN CRITERIA:

2.1 DEAD LOAD:
 PER 301.4, THE ACTUAL WEIGHTS OF MATERIALS AND CONSTRUCTION SHALL BE USED FOR DETERMINING DEAD LOAD; THE FOLLOWING APPROXIMATIONS (IN PSF) ARE USED FOR THIS PROJECT:

USE	PSF	OTHER
FRAMED WALL ASSEMBLY:	15	
ROOF/CEILING ASSEMBLY:	20	
FLOOR ASSEMBLY:	15	

ALL OF THE LOADS LISTED MAY NOT APPLY TO THE CURRENT PROJECT.

2.2 LIVE LOAD:
 UNIFORMLY DISTRIBUTED LIVE LOADS SHALL BE PER TABLE R301.5 AND AS FOLLOWS (IN PSF):

USE	PSF	OTHER
UNINHABITABLE SPACE WITHOUT STORAGE:	10	(-42'H, 24'W)
UNINHABITABLE ATTICS WITH/STORAGE:	20	
HABITABLE ATTICS & ATTICS W/STAIRS:	30	
EXTERIOR BALCONIES & DECKS:	40	
FIRE ESCAPES:	40	
GUARDS & HANDRAILS:	200 (CONCENTRATED)	(50' HORIZONTAL)
GUARD-IN-FILL COMPONENTS:	50 (2,000LB/205)	
PASSENGER VEHICLE GARAGE:	40	
ROOMS OTHER THAN SLEEPING ROOMS:	40	
SLEEPING ROOMS:	40	
STAIRS:	40	(& 300LB/45)
ROOF: PER 301.6 (INC. SNOW):	30	

*SOME OF THE LOADS LISTED ABOVE MAY BE HIGHER THAN THOSE REQUIRED PER CODE.

ALL OF THE LOADS LISTED MAY NOT APPLY TO THE CURRENT PROJECT.

2.3 WIND LOAD:
 WIND LOADS SHALL BE BASED ON THE ULTIMATE DESIGN WIND SPEED LISTED IN TABLE 301.2(1) AND ADJUSTED FOR HEIGHT AND EXPOSURE:

120 MPH. WIND LOADS WILL BE ALLOWED FOR IN: THE DESIGN LOAD PERFORMANCE REQUIREMENTS FOR ROOF COVERINGS, ROOF COVERINGS, WINDOWS, SKYLIGHTS AND DOORS. COMPONENT AND CLADDING LOADS WILL BE PER TABLE R301.2(2)

2.4 ALLOWABLE LIVE LOAD DEFLECTION:

THE ALLOWABLE LIVE LOAD DEFLECTION OF ALL STRUCTURAL MEMBERS, SHALL BE PER TABLE R301.7 AND AS FOLLOWS:

STRUCTURAL MEMBER ALLOWABLE DEFLECTION

RAFTERS HAVING SLOPES GREATER THAN 3:12 WHIT FINISHED CEILING NOT ATTACHED TO RAFTERS	L/180
INTERIOR WALLS AND PARTITIONS	H/180
FLOORS	L/360
CEILING WITH BRITTLE FINISHES (INCLUDING PLASTER AND STUCCO)	L/360
CEILING WITH FLEXIBLE FINISHES (INCLUDING GYPSUM BOARD)	L/240
ALL OTHER STRUCTURAL MEMBERS	L/240
EXTERIOR WALLS-WIND LOAD WITH PLASTER OR STUCCO FINISHES	L/360
EXTERIOR WALLS-WIND LOAD WITH OTHER BRITTLE FINISHES	H/240
EXTERIOR WALLS-WIND LOADS WITH FLEXIBLE FINISHES	H/120
LINTELS SUPPORTING MASONRY VENEER WALLS	L/600

2.5 CLIMATIC AND GEOGRAPHIC CRITERIA:

CLIMATIC AND DESIGN CRITERIA FOR THE VILLAGE OF PORT CHESTER ARE PER TABLE R301.2(1)

BELOW:

PER 2020 RESIDENTIAL CODE OF NEW YORK STATE, TABLE 301.2(1) (WIND) EXPOSURE CATEGORY: B										CLIMATE ZONE: 4A			
WIND DESIGN			SUBJECT TO DAMAGE FROM			WINTER DESIGN			ICE BARRIER	FLOOD HAZARDS	AIR FREEZING INDEX	MEAN ANNUAL TEMP	
GROUND SNOW LOAD	WIND SPEED MPH	TOPOGRAPHIC EFFECTS	SPECIAL WIND REGION	WINDBORNE DEBRIS ZONE	SEISMIC DESIGN CATEGORY	WEATHERING	FROSTLINE DEPTH	TERMITE	TEMP.	REQUIRED			
20 PSF	120	NO	YES	NO	B	SEVERE	3'-6"	MOD/HEAVY	7.7°	YES	09.28.2007	1,500	52.5°

2.6 INSULATION & FENESTRATION CRITERIA:

THERMAL AND MOISTURE PROTECTION SHALL BE PROVIDED PER THE ARCHITECTURAL DRAWINGS AND SPECIFICATIONS AND THE CRITERIA DENOTED IN TABLE R1102.1.2 (R402.1.2)

INSULATION AND FENESTRATION REQUIREMENTS BY COMPONENT*											
CLIMATE ZONE	FENESTRATION U-FACTOR*	SKYLIGHT U-FACTOR	GLAZED FENESTRATION SHGC*	CEILING & WALL R-VALUE	WOOD FRAME WALL R-VALUE	MASS WALL R-VALUE	FLOOR R-VALUE	BASEMENT WALL R-VALUE	SLAB & CRAWL SPACE R-VALUE	WALL R-DEPTH	WALL R-VALUE
4	0.32	0.55	0.40	49	20 of 13 - 5'	8/13	19	10/12	10/13	2 ft	

2.7 THERMAL & MOISTURE PROTECTION:

ALL WORK IS TO COMPLY WITH CHAPTER 11 ENERGY EFFICIENCY (REFERRED TO HEREIN AS "THIS CHAPTER") OF THE 2020 RESIDENTIAL CODE OF NEW YORK STATE (INTERNATIONAL RESIDENTIAL CODE 2018 WITH AMENDMENTS) AND ENERGY CONSERVATION CONSTRUCTION CODE OF NEW YORK STATE 2020 (INTERNATIONAL ENERGY CONSERVATION CODE 2018).

ADDITIONS, ALTERATIONS AND REPAIRS:

NEW AND REPLACEMENT MATERIALS:
 EXCEPT AS OTHERWISE REQUIRED OR PERMITTED BY THIS CODE, MATERIALS PERMITTED BY THE APPLICABLE CODE FOR NEW CONSTRUCTION SHALL BE USED. LIKE MATERIALS SHALL BE PERMITTED FOR REPAIRS, PROVIDED THAT HAZARDS TO LIFE, HEALTH OR PROPERTY ARE NOT CREATED. HAZARDOUS MATERIALS SHALL NOT BE USED WHERE THE CODE FOR NEW CONSTRUCTION WOULD NOT ALLOW THEIR USE IN BUILDINGS OF SIMILAR OCCUPANCY, PURPOSE AND LOCATION.

ALTERATIONS TO ANY BUILDING OR STRUCTURE SHALL COMPLY WITH THE REQUIREMENTS OF THE CODE FOR NEW CONSTRUCTION. ALTERATIONS SHALL BE SUCH THAT THE EXISTING BUILDING OR STRUCTURE IS NOT LESS CONFORMING WITH THE PROVISIONS OF THIS CHAPTER THAN THE EXISTING BUILDING OR STRUCTURE WAS PRIOR TO THE ALTERATION.

UNALTERED PORTIONS OF THE EXISTING BUILDING OR BUILDING SUPPLY SYSTEM SHALL NOT BE REQUIRED TO COMPLY WITH THIS CHAPTER.

EXISTING CEILING, WALL OR FLOOR CAVITIES EXPOSED DURING CONSTRUCTION SHALL NOT BE REQUIRED TO COMPLY WITH THE REQUIREMENTS FOR NEW CONSTRUCTION PROVIDED THAT THE ENERGY USE OF THE BUILDING IS NOT INCREASED AND THAT THESE CAVITIES ARE FILLED WITH INSULATION.

ROOFS WITHOUT INSULATION IN THE CAVITY AND WHERE THE SHEATHING OR INSULATION IS EXPOSED DURING RE-ROOFING SHALL NOT BE REQUIRED TO COMPLY WITH THE REQUIREMENTS FOR NEW CONSTRUCTION PROVIDED THAT THE ENERGY USE OF THE BUILDING IS NOT INCREASED AND THE ROOF SHALL BE INSULATED EITHER ABOVE OR BELOW THE SHEATHING.

MOISTURE PROTECTION:

CLIMATE ZONE (WESTCHESTER COUNTY): ZONE 4A

WALL ASSEMBLIES IN THE BUILDING THERMAL ENVELOPE SHALL COMPLY WITH THE VAPOR RETARDER REQUIREMENTS OF SECTION R702.7 AND AS FOLLOWS:

INSTALL CLASS I OR CLASS II VAPOR RETARDER ON THE INTERIOR SIDE OF ALL EXPOSED AREAS OF EXTERIOR WALLS AND CEILINGS.

CLASS I: SHEET POLYETHYLENE, UNPERFORATED ALUMINUM FOIL.

CLASS II: KRAFT-FACED FIBERGLASS BATTING.


EXCEPTIONS:

- BASEMENT WALLS.
- BELOW-GRADE PORTION OF ANY WALL.
- CONSTRUCTION WHERE MOISTURE OR ITS FREEZING WILL NOT DAMAGE THE MATERIALS.

3.0 CONTRACTOR'S RESPONSIBILITIES:

THE CONTRACTOR SHALL:

- PROVIDE ALL LABOR, MATERIALS AND EQUIPMENT NECESSARY FOR A COMPLETE AND FINISHED JOB.
- PROVIDE ALL NECESSARY SHORING AND BRACING FOR ALL BUILDING COMPONENTS IN ORDER TO ADEQUATELY PROTECT AGAINST ANY FAILURES.
- OBTAINT AND PAY FOR ALL REQUIRED PERMITS - UNLESS OTHERWISE STIPULATED.
- PRIOR TO THE SUBMISSION OF ANY BID, AND BEFORE PROCEEDING WITH ANY WORK, VISIT THE SITE AND VERIFY AND FAMILIARIZE HIMSELF WITH ALL SITE DIMENSIONS AND CONDITIONS, WITH SITE WORKING CONDITIONS, HOURS OF LEGAL OPERATION, METHODS AND ROUTES OF ACCESS, AND THE EXISTENCE AND EXTENT OF

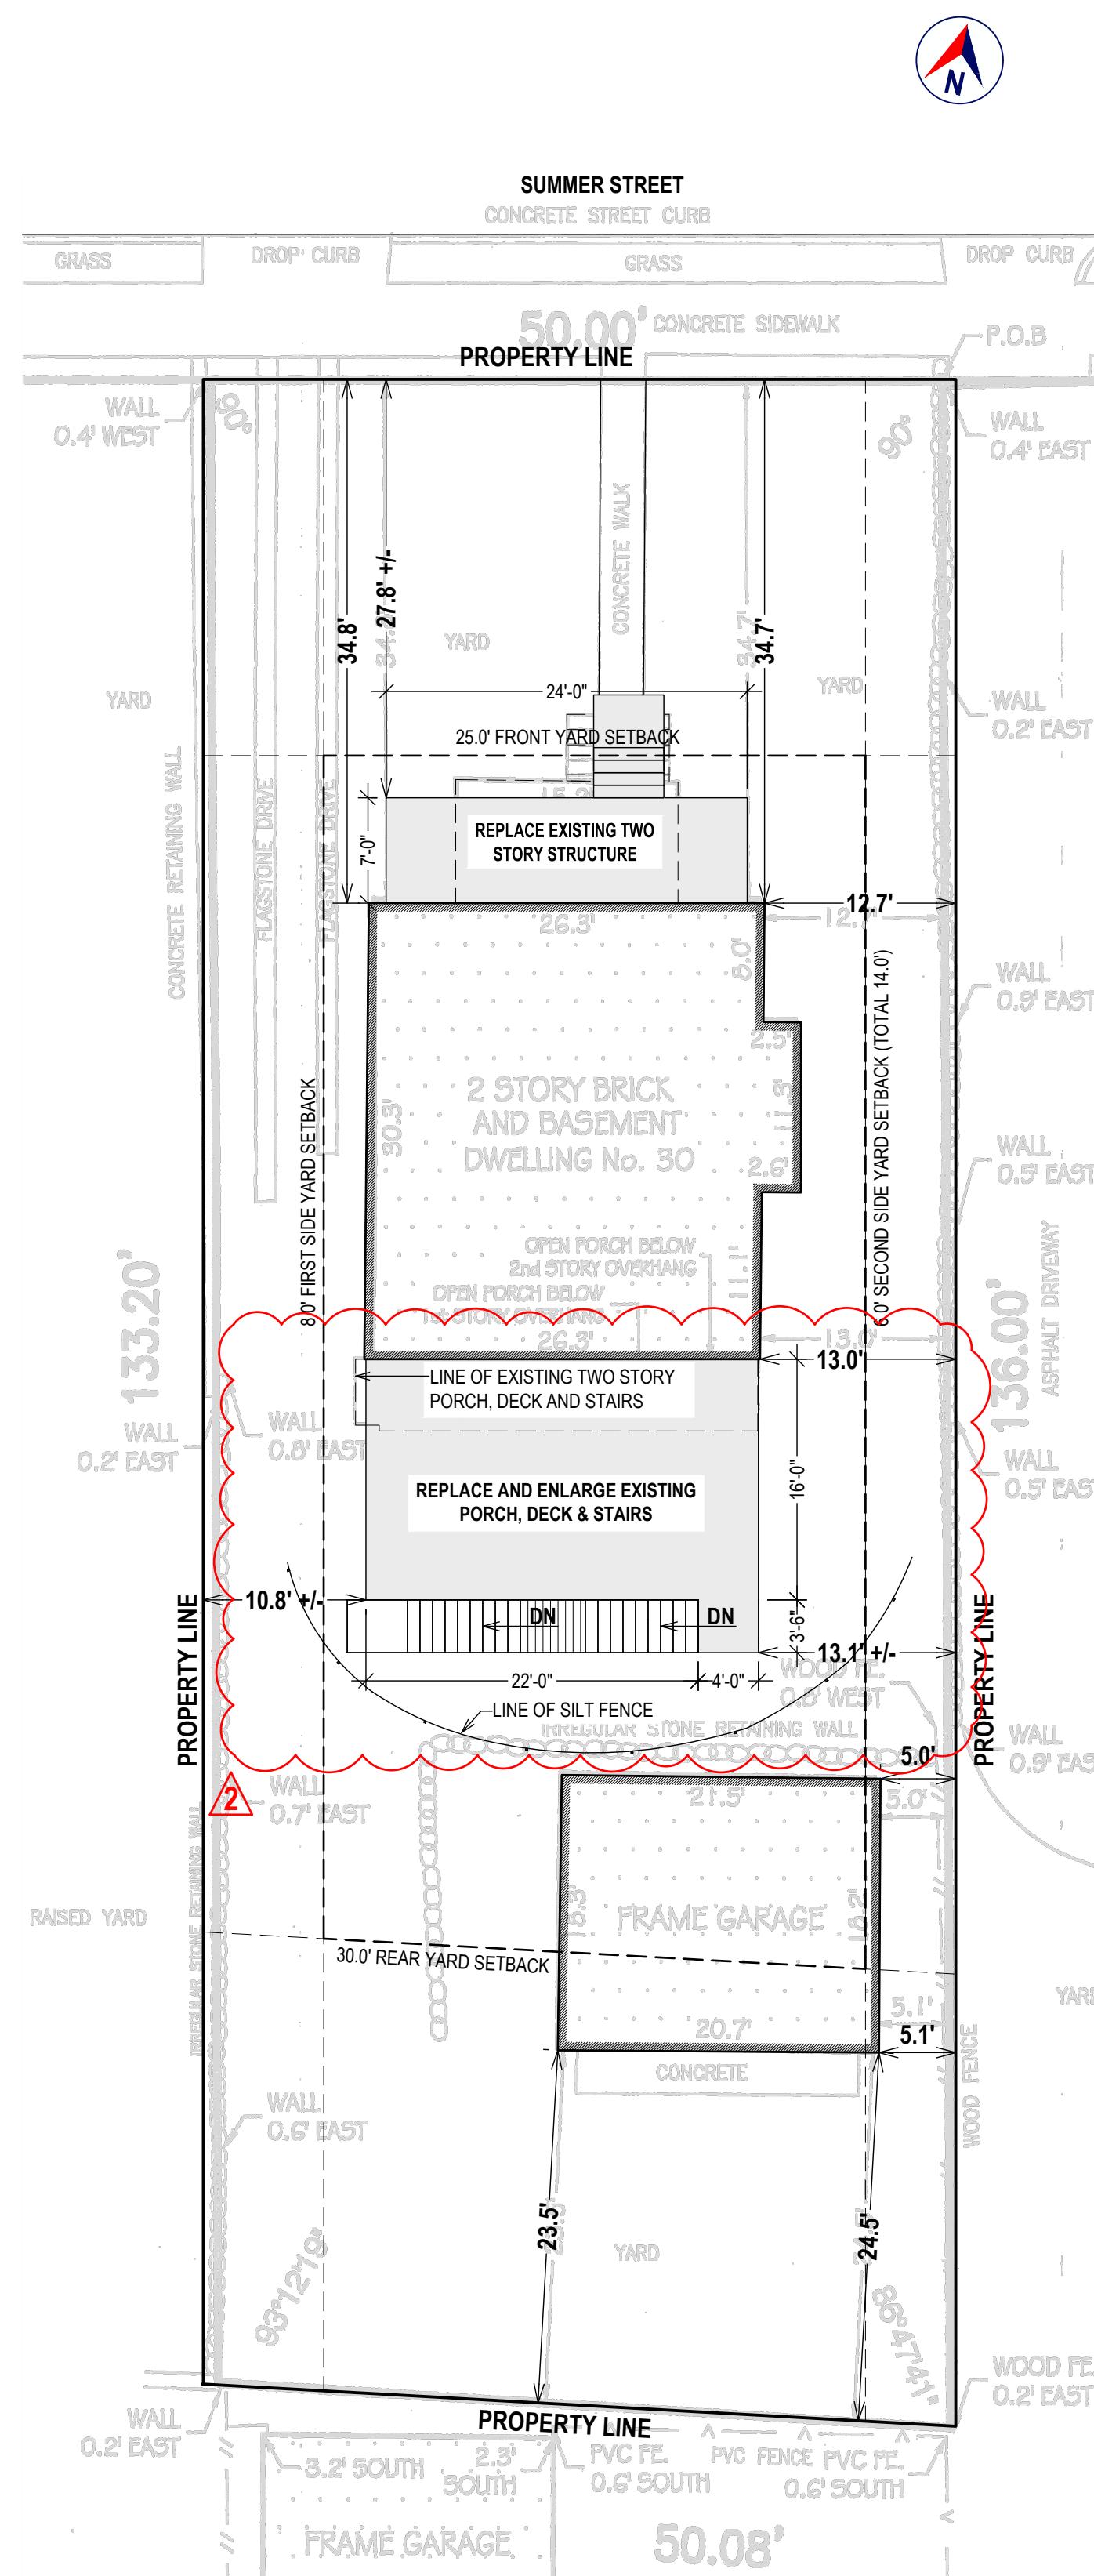

SITE WORK

EXCAVATION SAFETY:
THE CONTRACTOR SHALL COMPLY WITH THE TRENCHING AND EXCAVATION REQUIREMENTS OF 29 CFR 1926.651 AND 1926.652 OR COMPARABLE OSHA-APPROVED STATE PLAN REQUIREMENTS. TRENCHES 5 FEET DEEP OR GREATER REQUIRE A PROTECTIVE SYSTEM UNLESS THE EXCAVATION IS MADE ENTIRELY IN STABLE ROCK.

THE CONTRACTOR SHALL HAVE A COMPETENT PERSON INSPECT EXCAVATIONS DAILY AND AS CONDITIONS CHANGE TO ENSURE ELIMINATION OF EXCAVATION HAZARDS.

A COMPETENT PERSON IS AN INDIVIDUAL WHO IS CAPABLE OF IDENTIFYING EXISTING AND PREDICTABLE HAZARDS OR WORKING CONDITIONS THAT ARE HAZARDOUS, UNSANITARY, OR DANGEROUS TO WORKERS, SOIL TYPES AND PROTECTIVE SYSTEMS REQUIRED, AND WHO IS AUTHORIZED TO TAKE PROMPT CORRECTIVE MEASURES TO ELIMINATE THESE HAZARDS AND CONDITIONS.

EXCAVATION - LOCATING UTILITIES - CALL 811:
NEW YORK STATE LAW (16 NYCRR PART 753) REQUIRES ALL EXCAVATORS TO PLACE A LOCATION REQUEST WITH DIG SAFELY NEW YORK AT LEAST TWO (2) FULL WORKING DAYS, BUT NO MORE THAN 10 WORKING DAYS BEFORE BEGINNING AN EXCAVATION PROJECT IN ORDER TO ENSURE ALL UNDERGROUND UTILITY LINES ARE PROPERLY MARKED BY THEIR OWNERS.

A LOCATION REQUEST MAY BE PLACED, AND THE PROCESS OF MARKING UNDERGROUND UTILITIES MAY BE TRACKED, BY USING THE ONLINE LOCATION REQUEST PROGRAM, EXACTIX, OR, THE EXCAVATOR MAY CALL 811 TO PLACE THE LOCATION REQUEST.

- NOTIFY: NOTIFY 811 ONLINE WITH EXACTIX OR BY CALLING 811.
- WAIT: AT LEAST TWO DAYS FOR UTILITIES TO RESPOND (NOT INC. THE DAY YOU CALL).
- CONFIRM: CHECK ALL UTILITIES HAVE RESPONDED.
- RESPECT: ADHERE TO UTILITY MARKS AND FLAGS.
- DIG WITH CAUTION: DIG CAREFULLY AROUND BURIED UTILITIES.

NOTE:
THE VILLAGE OF PORT CHESTER MAY REQUIRE THE CONTRACTOR TO PROVIDE A "DIG SAFELY" CODE 753 CASE NUMBER.


EROSION CONTROL:
THE NEW YORK STATE DEPARTMENT OF ENVIRONMENTAL CONSERVATION (NYS DEC) PROVIDES MINIMUM STANDARDS AND SPECIFICATIONS FOR THE CONTROL OF STORMWATER DISCHARGES ASSOCIATED WITH CONSTRUCTION ACTIVITY. EROSION CONTROL SHALL BE PROVIDED IN ACCORDANCE WITH THE NEW YORK STATE STANDARDS AND SPECIFICATIONS FOR EROSION AND SEDIMENT CONTROL, WITH ALL RELEVANT REGULATIONS OF THE VILLAGE OF PORT CHESTER AND AS FOLLOWS:

THE SILT FENCE SHALL BE INSTALLED BEFORE UP-SLOPE GROUND COVER IS REMOVED. FENCE SHALL BE PLACED ON THE FLATTEST AREA AVAILABLE: A RUN OF SILT FENCE SHOULD FOLLOW THE CONTOUR AS CLOSELY AS POSSIBLE WITH THE ENDS TURNED UPSLOPE TO POND WATER BEHIND THE FENCE.

THE SILT FENCE FABRIC SHOULD BE BURIED AT LEAST 6' DEEP AND HAVE A TOTAL OF 8" (MINIMUM) FABRIC BELOW THE GROUND.

STAKES SHALL BE A MINIMUM OF 2X2 NOMINAL (1 1/2" X 1 1/2" ACTUAL) HARDWOOD AND OF SOUND QUALITY; THE STAKES SHALL BE PLACED ON THE DOWN-SLOPE SIDE OF THE GEOTEXTILE AND AT A MAXIMUM SPACING OF 8'0" ON CENTER.

THE APPLICANT AND/OR CONTRACTOR SHALL ESTABLISH EROSION CONTROL AS NOTED IN THESE DRAWINGS AND SHALL MAINTAIN EROSION CONTROL MEASURES THROUGHOUT CONSTRUCTION UNTIL SUCH TIME THAT THE BUILDING INSPECTOR KEEPS THE LAND TO BE STABLE.

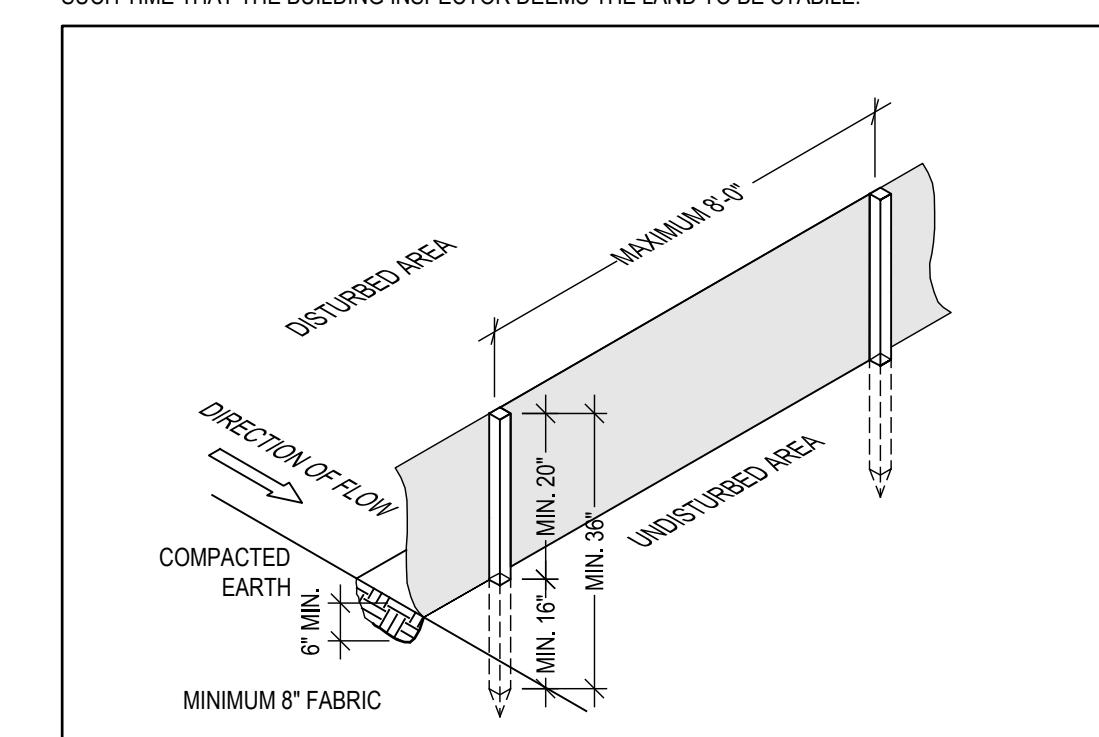

SITE PLAN

BACKGROUND INFORMATION FROM SURVEY BY LALSA LAND SURVEYING PLLC, 03.24.2025
1" = 10'-0"

LOT AREA AND IMPERVIOUS COVERAGE			
		LOT AREA COVERAGE	IMPERVIOUS COVERAGE
EXISTING	PROPOSED	EXISTING	PROPOSED
HOUSEFOOTPRINT	825.6 +/-	825.6 +/-	825.6 +/-
DETACHED GARAGE	387.9 +/-	387.9 +/-	387.9 +/-
FRONT PORCH/DECK	-	-	120 +/-
FRONT STEPS	-	-	30.3 +/-
FRONTWALKWAY	-	-	66.26 +/-
REAR PORCH/DECK	-	-	134.8 +/-
REAR STEPS	-	-	431.3 +/-
FLAGSTONE DRIVEWAY	-	-	81.6 +/-
TOTAL:	1,213.5 +/-	1,213.5 +/-	1,704.46 +/-
			2,128.3 +/-

ZONING COMPLIANCE		
ADDRESS: 30 SUMMERSTREET	ZONE: R5 ONEFAMILY MUNICIPALITY: VILLAGE OF PORT CHESTER	RESIDENCE TAXID: 136.70-1-38
LOTINFORMATION	REQUIRED	EXISTING
LOTAREA (SF)	5,000.0	6730 +/-
LOTFRONTAGE (FT)	50.0	50.0
YARD SETBACKS (FT):		
FRONTYARD	25.0	34.7
REARYARD	30.0	70.1 +/-
FIRSTSIDERYARD	8.0	12.7
TOTAL OF TWO SIDEYARD ALONG STREET	14.0	>14.0
PRINCIPAL BUILDING INFORMATION		
GROSSLOORAREA (SF)		NO CHANGE
BUILDINGHEIGHT		NO CHANGE
STORES		NO CHANGE
HEIGHTTOPRINCIPALFADE (FT)		NO CHANGE
HEIGHTTOHIGHESTROOFRODGE (FT)		NO CHANGE
BUILDING COVERAGE		
PRINCIPALBUILDINGCOVERAGE (SF)		825.6 +/-
PRINCIPALBUILDINGCOVERAGE (%)		12.3% +/-
ACCESSORYBUILDINGCOVERAGE (SF)		NO CHANGE
ACCESSORYBUILDINGCOVERAGE (%)		NO CHANGE
ACCESSORYSTRUCTURES		
DETACHED GARAGE		
SETBACKS		
TOPRINCIPALBUILDING (FT)	10.0	27.6 +/-
TOSIDELOTLINE (FT)	5.0	5.0
TOREARLOTLINE (FT)	5.0	23.5
BUILDINGHEIGHT		
HEIGHTTOPRINCIPALFADE (FT)		NO CHANGE
HEIGHTTOHIGHESTROOFRODGE (FT)		NO CHANGE
IMPERVIOUS SURFACE COVERAGE		
IMPERVIOUSSURFACECOVERAGE (SF)		1,704.46 +/-
IMPERVIOUSSURFACECOVERAGE (%)		2,128.3 +/-

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NOT FOR REPRODUCTION
OR UNAUTHORIZED USE

PROPERTY ADDRESS:

PORT CHESTER, NY 10573
(VILLAGE OF PORT CHESTER
BUILDING DEPARTMENT)

S-B-L:

CLIENT:
*** ***

TEL: ***
EMAIL: ***

DATE: 05.15.2025 **ISSUE:** PRELIMINARY
07.23.2025 FOR PERMIT
08.15.2025 FOR PERMIT
12.04.2025 AMENDMENT


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DRAWING NAME: SITE PLAN


DRAWING NUMBER: C-02

DATE: 05.15.2025
SCALE: AS NOTED

NOTE:
THIS DRAWING IS VALID FOR CONSTRUCTION IF (AND ONLY IF) A PERMIT IS ISSUED, BASED ON THIS DRAWING, BY THE VILLAGE OF PORT CHESTER.

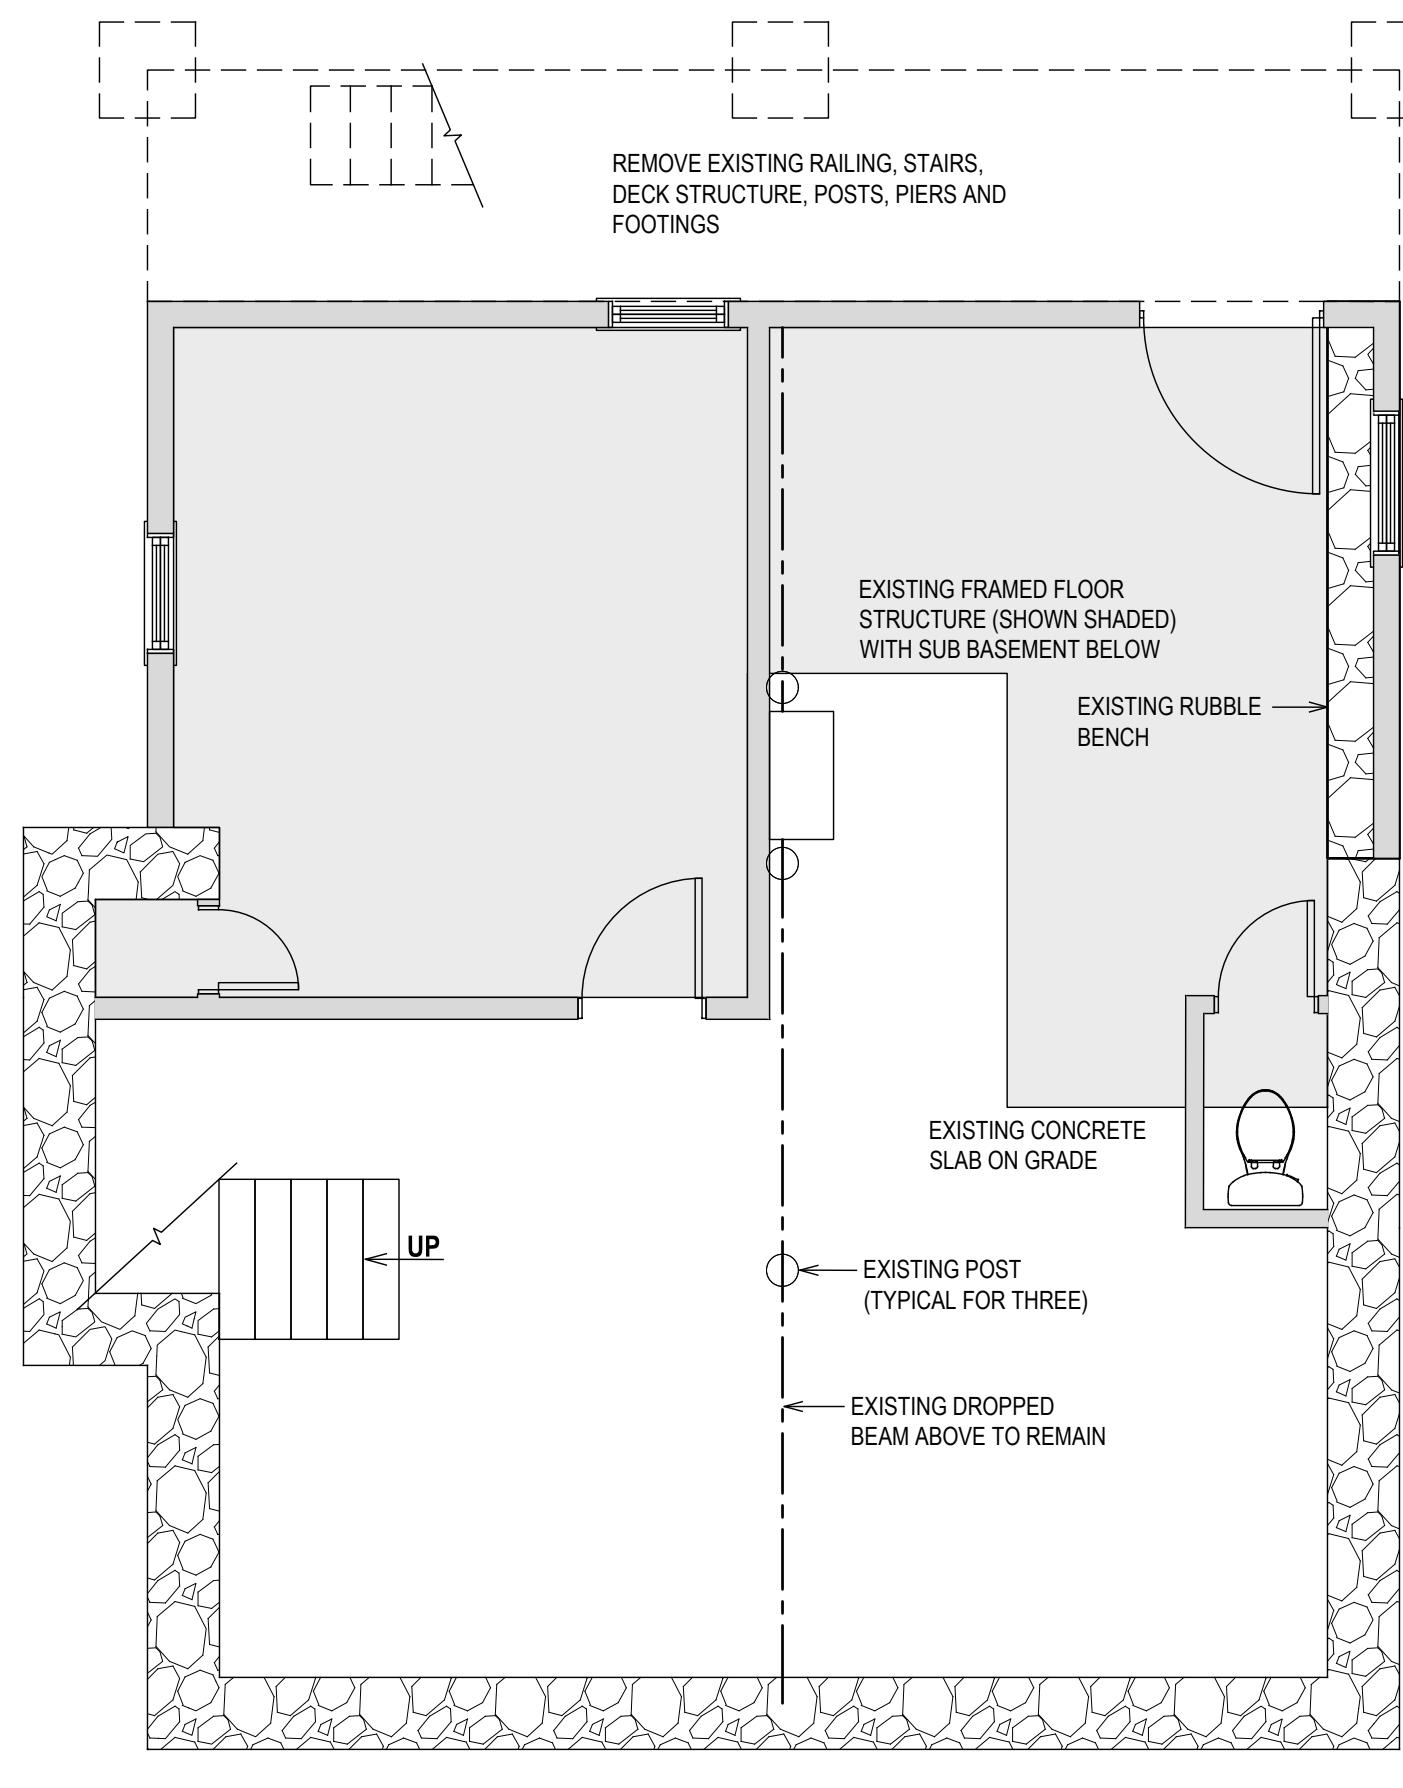

FOUNDATION PLAN EXISTING AND DEMOLITION
 $\frac{1}{8}'' = 1'-0''$

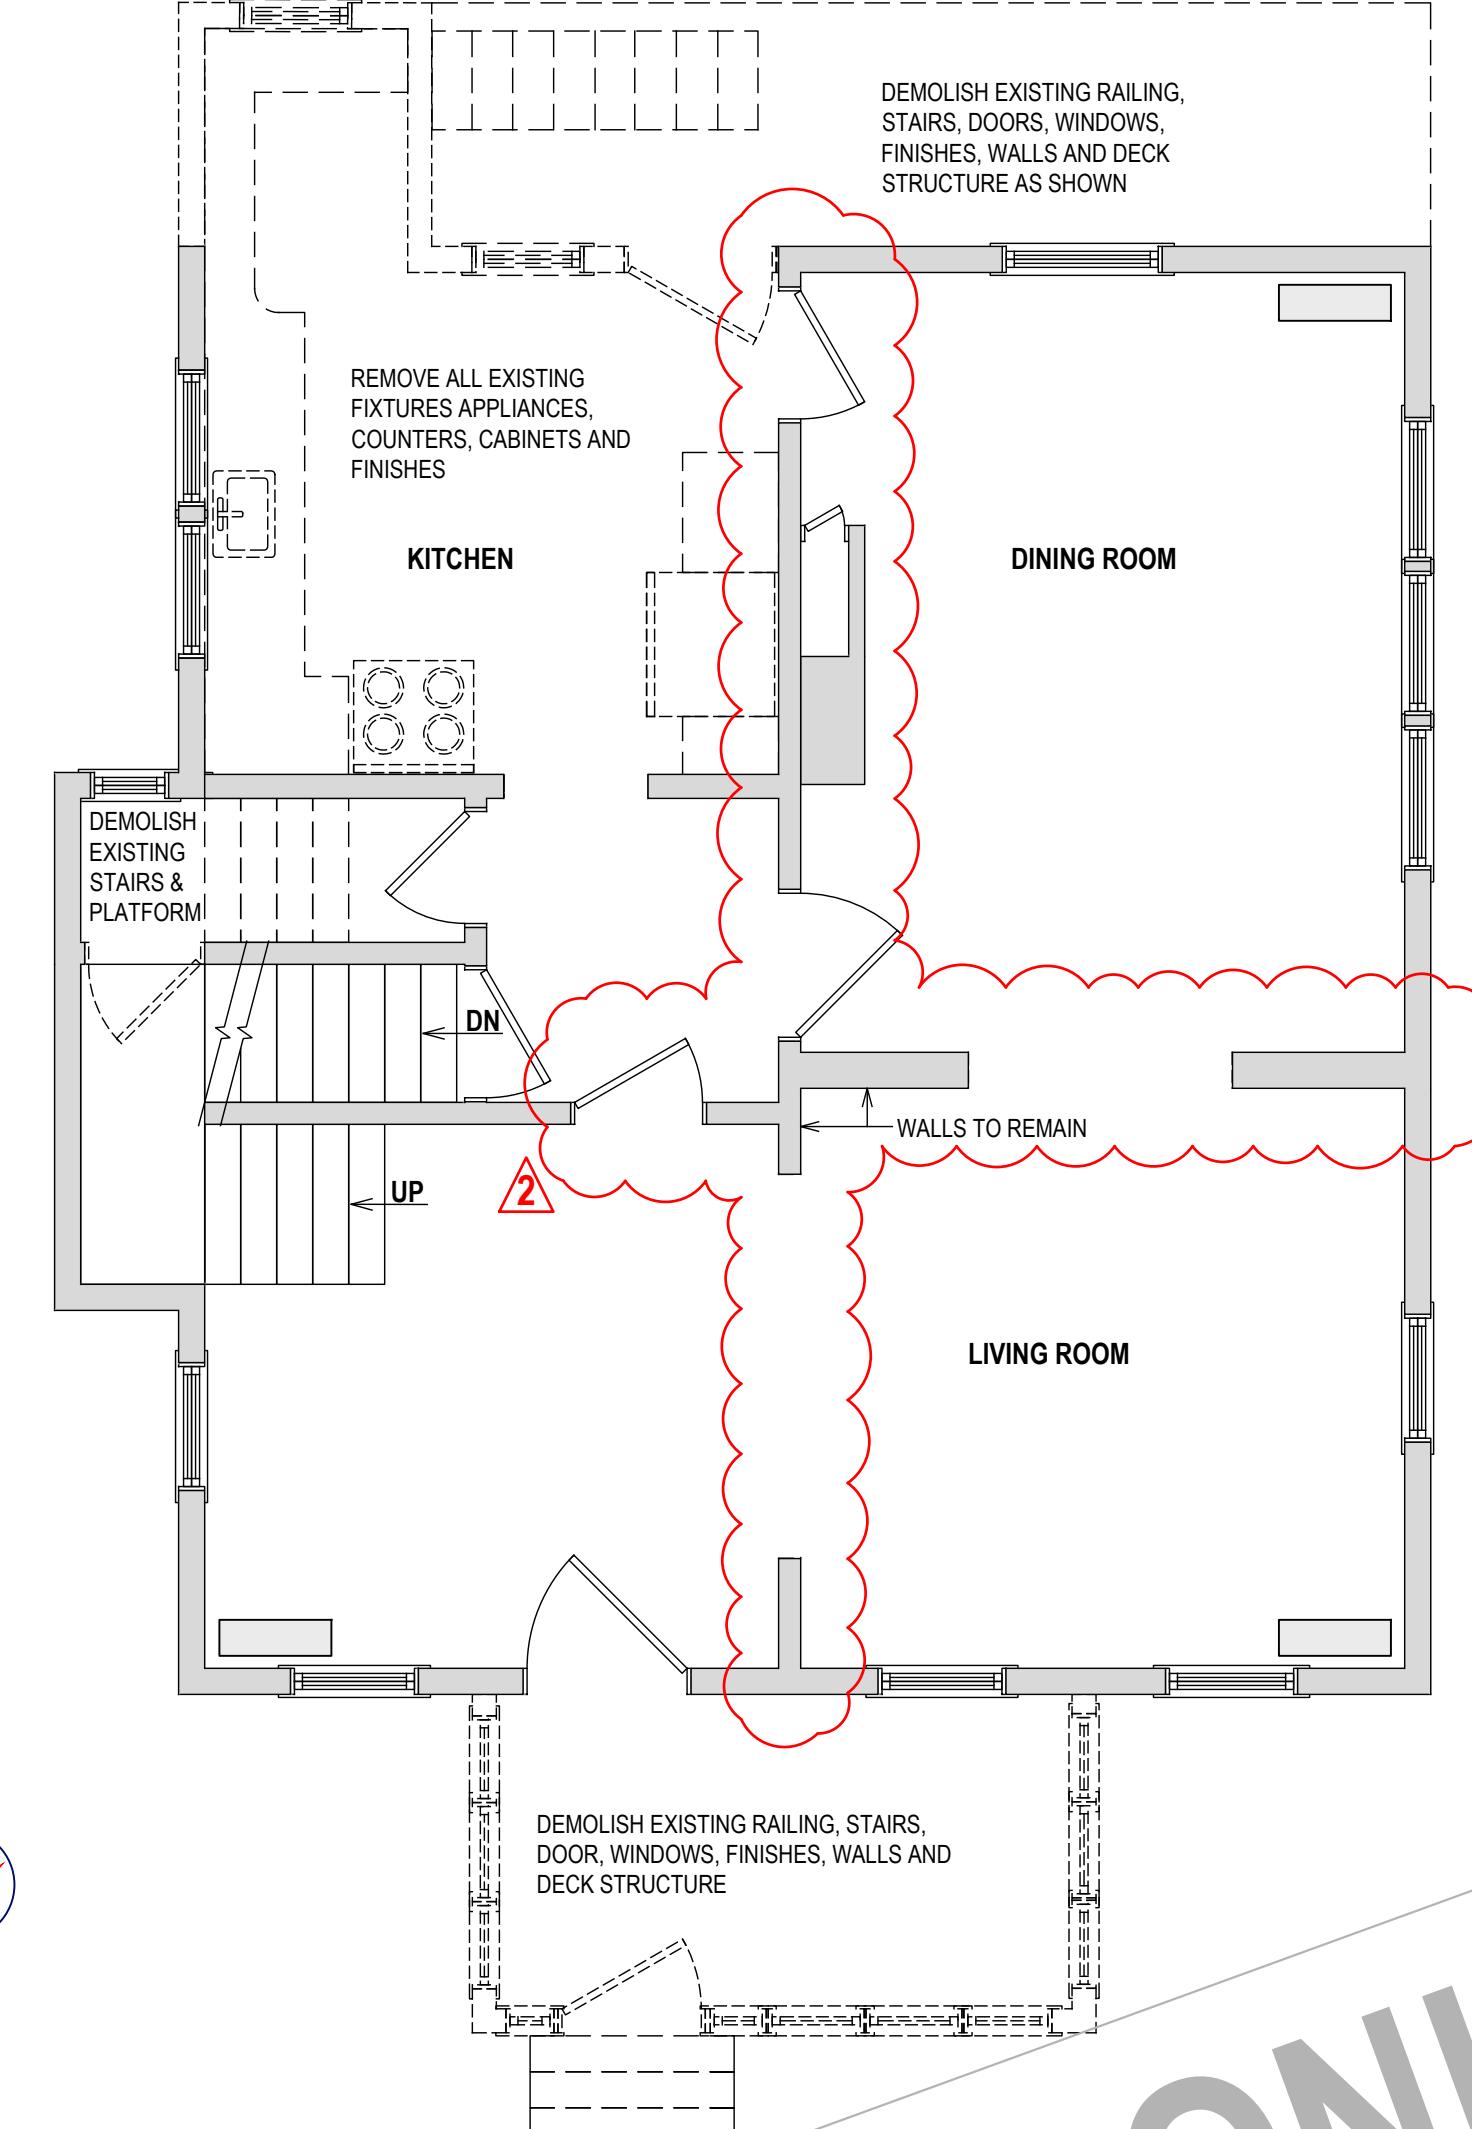

FIRST FLOOR EXISTING AND DEMOLITION
 $\frac{1}{8}'' = 1'-0''$



PROPERTY ADDRESS:

 PORT CHESTER, NY 10573
 (VILLAGE OF PORT CHESTER
 BUILDING DEPARTMENT)

S-B-L:

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 *** ***

TEL: ***
 EMAIL:

DATE: ISSUE:
 05.15.2025 PRELIMINARY
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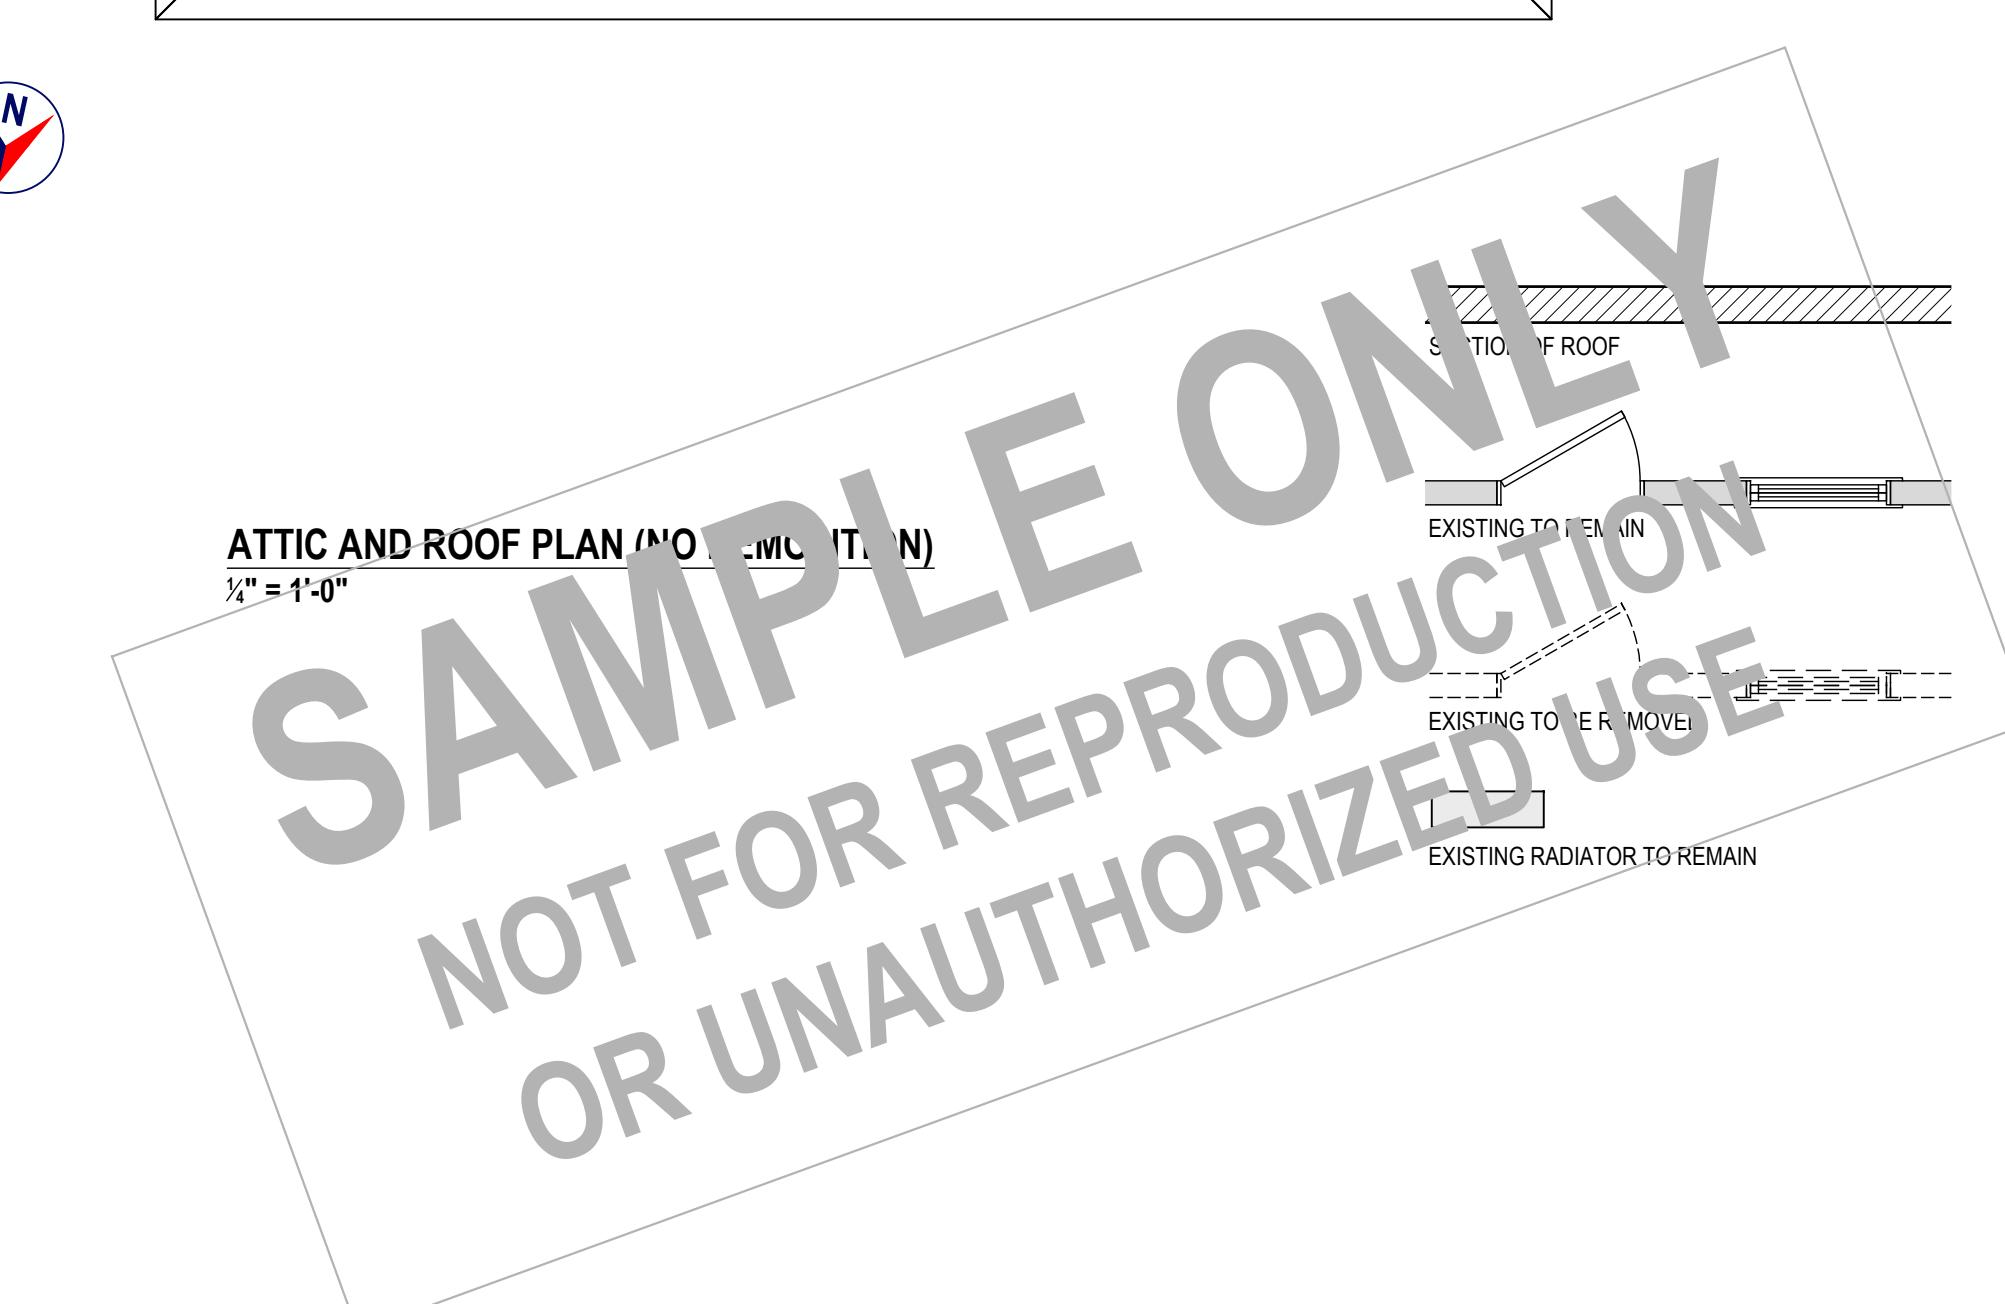
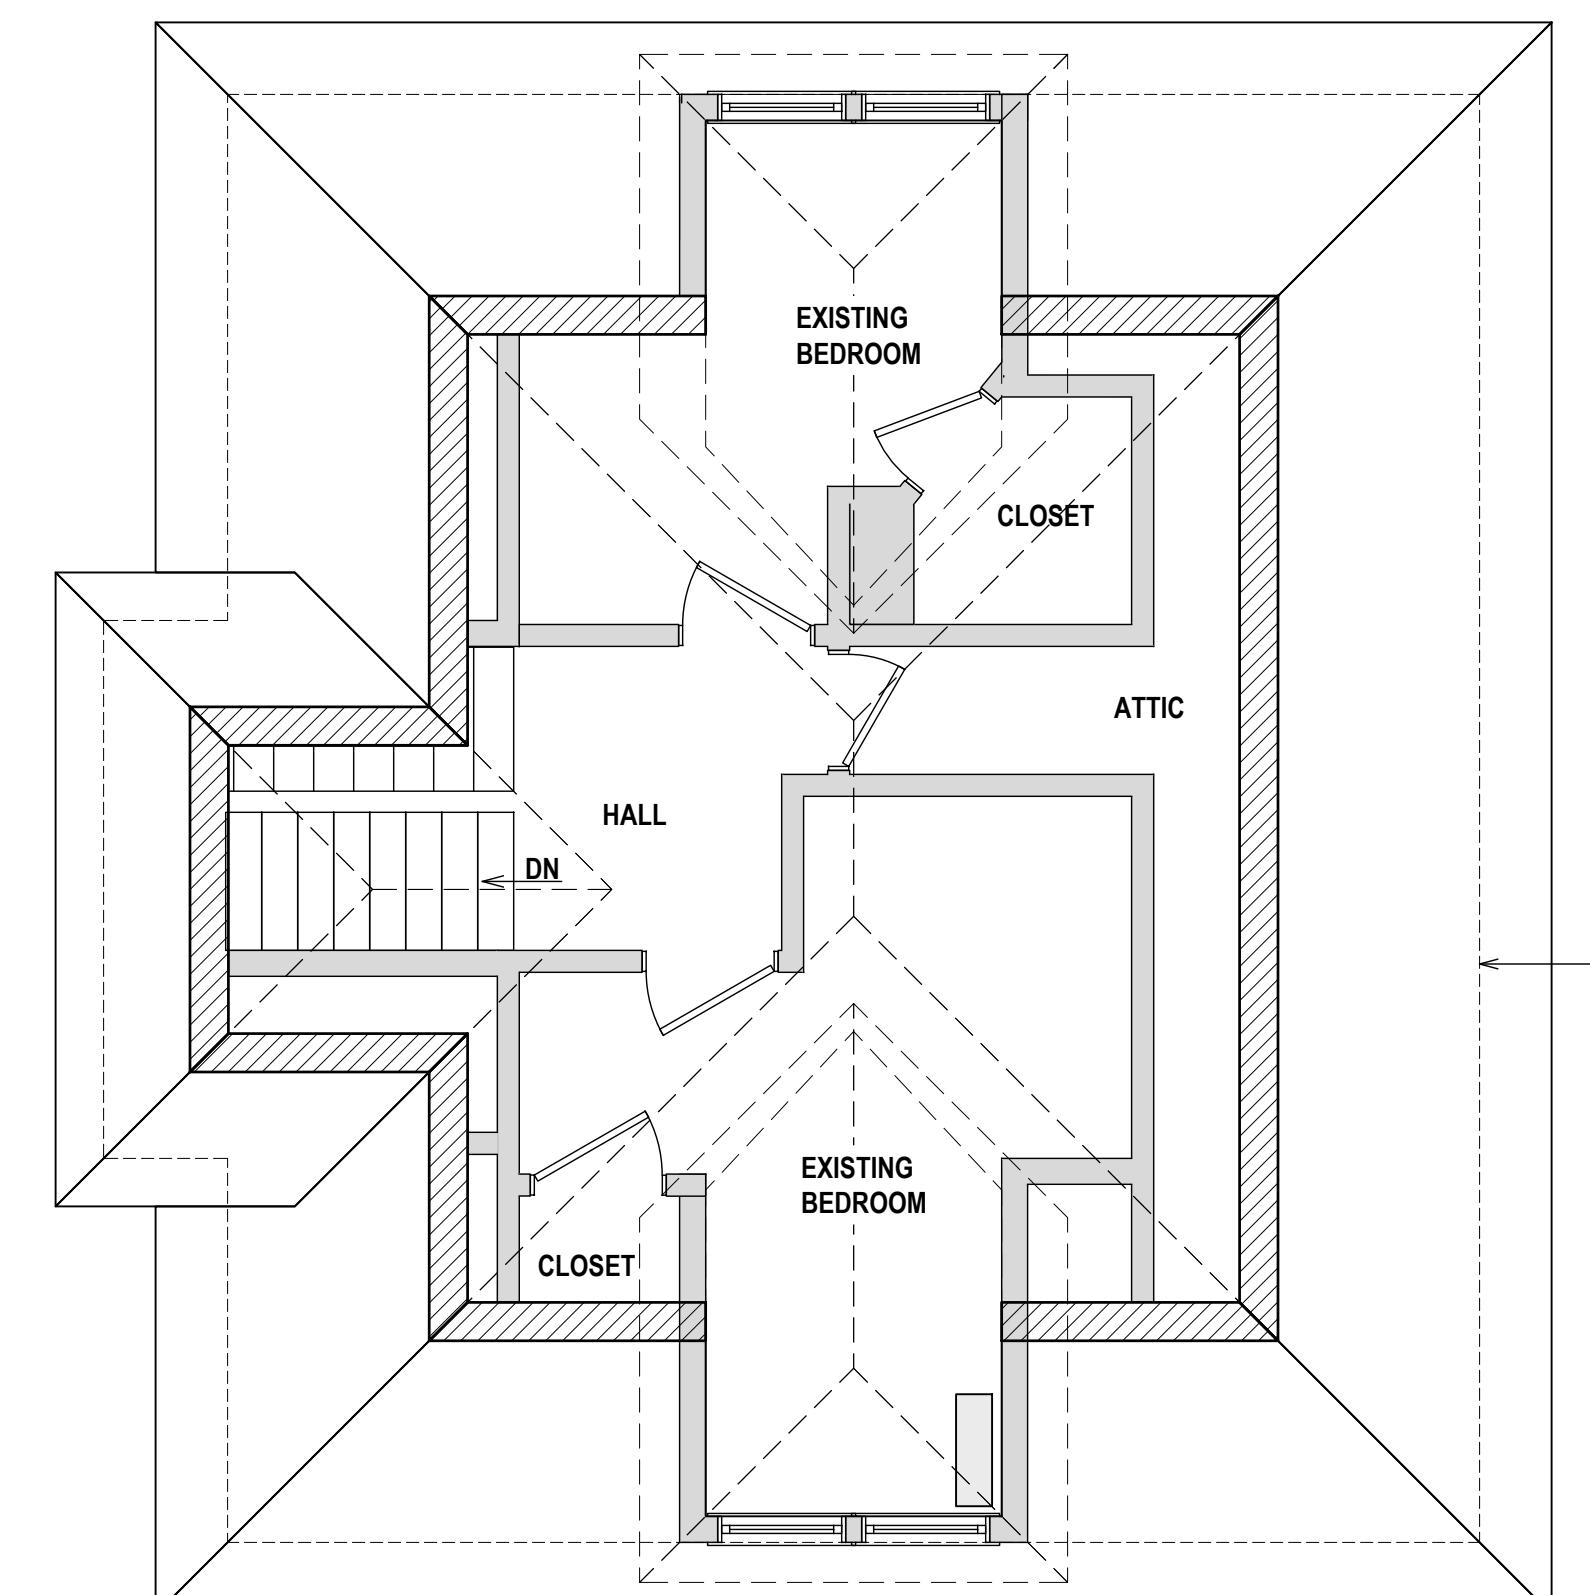
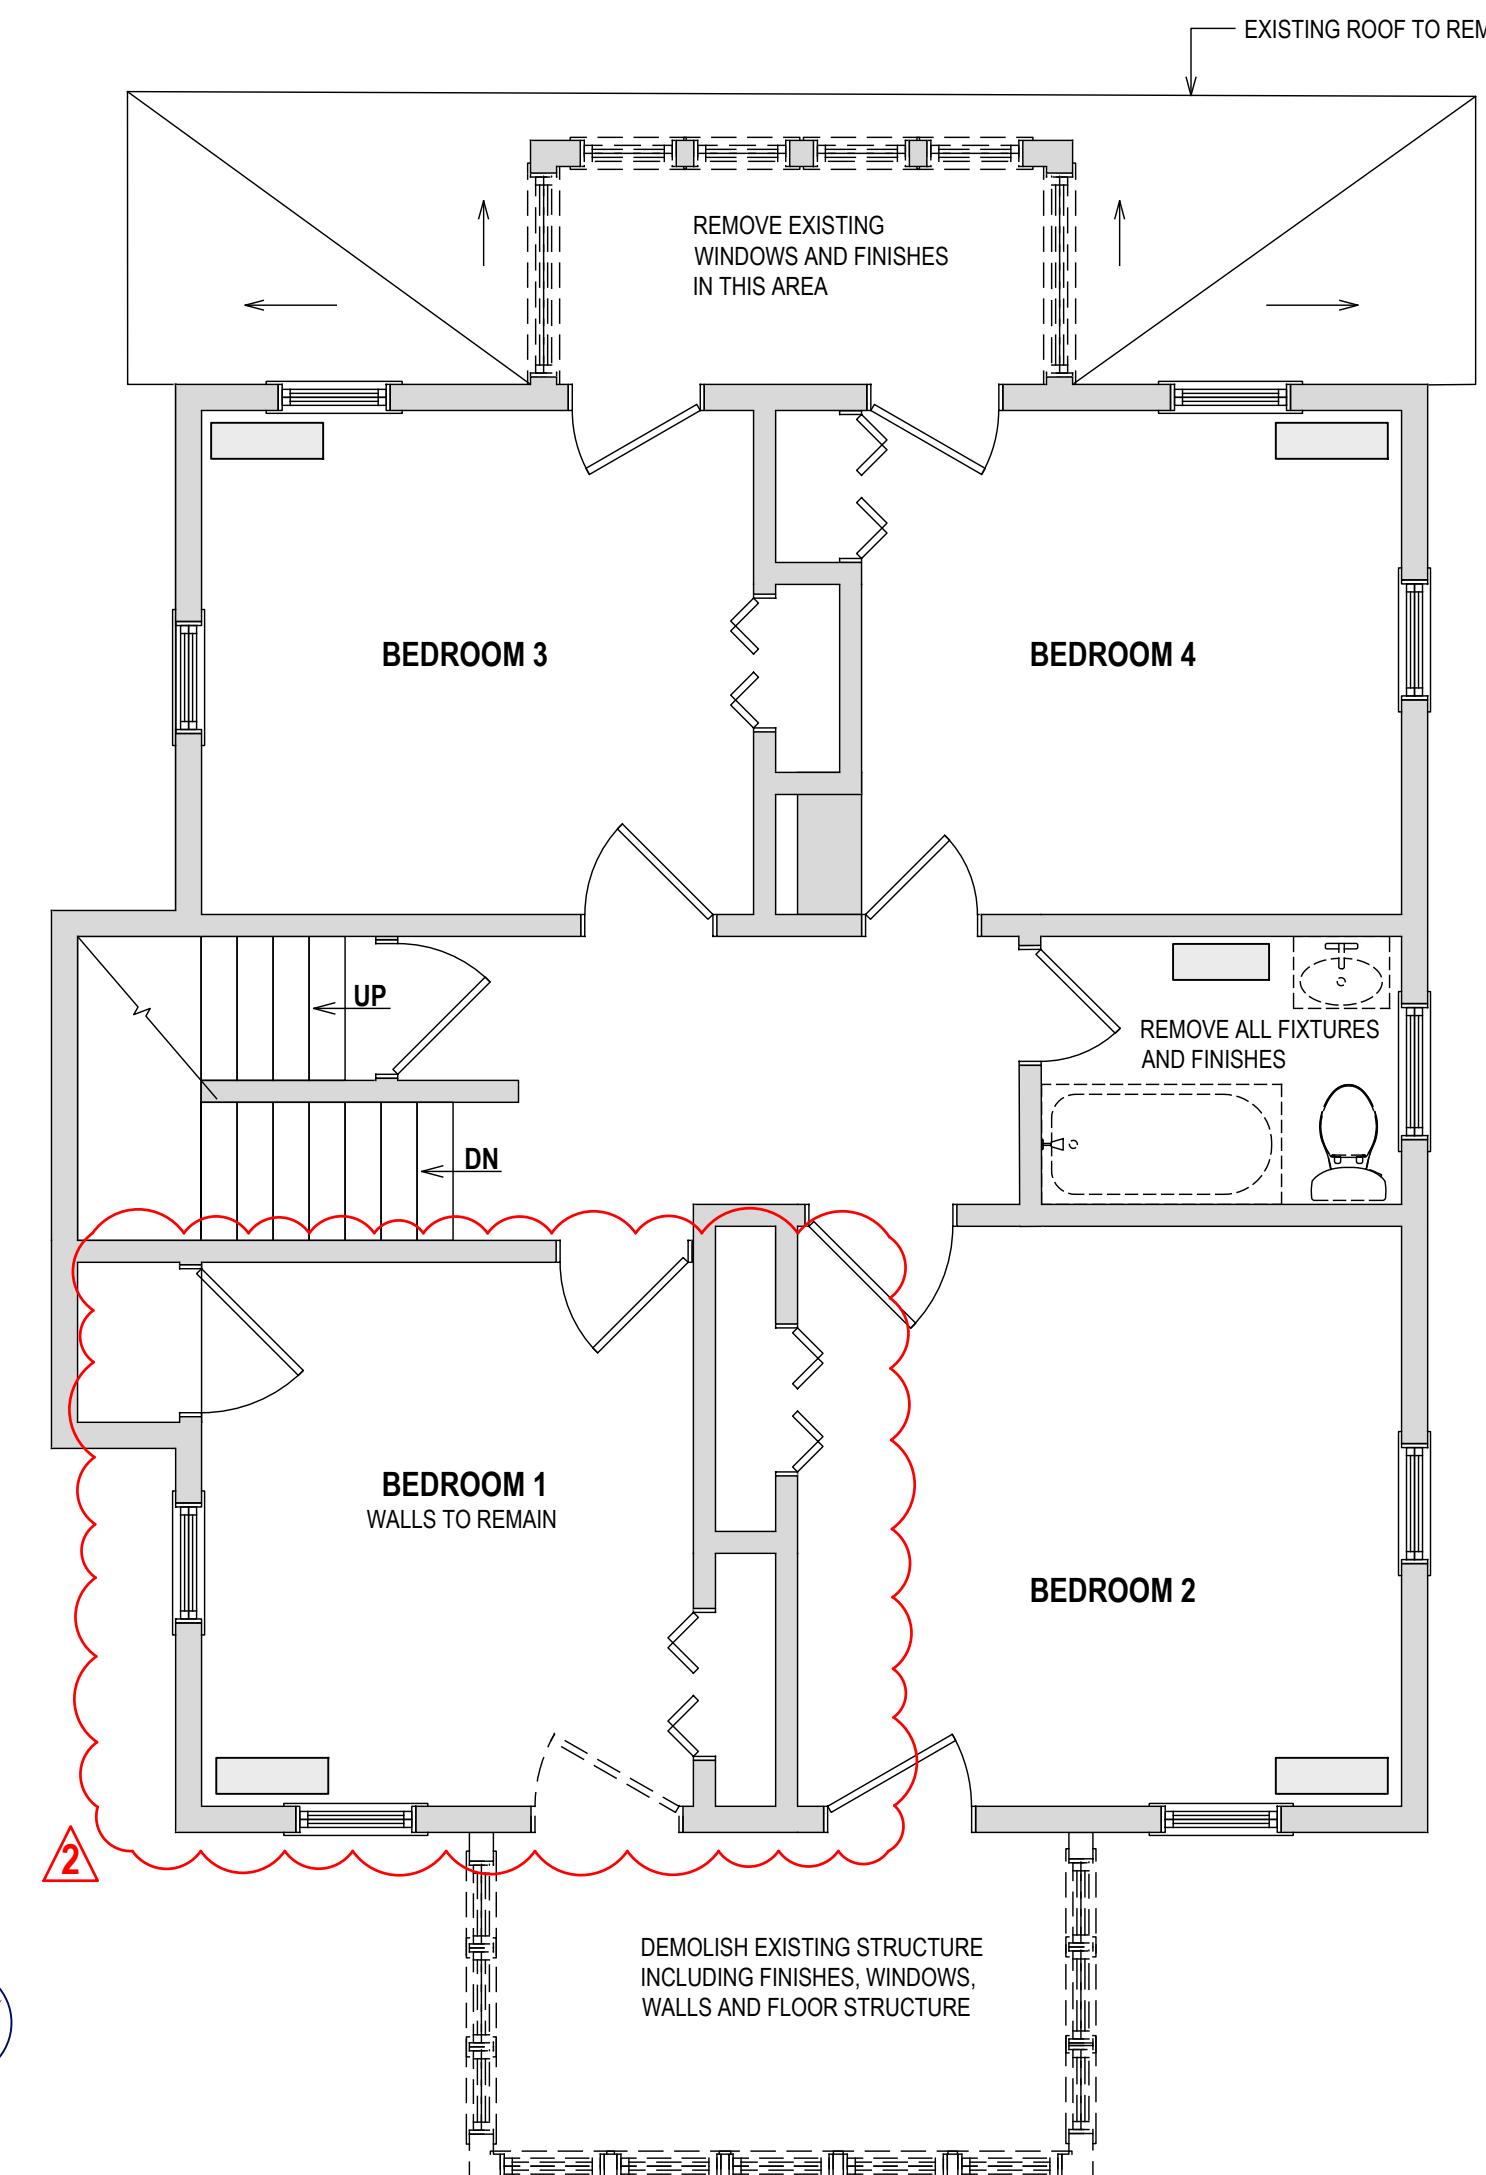
PROJECT NAME:
 FLOOR PLAN ALTERATION

DRAWING NAME:
 EXISTING AND DEMOLITION 01

DRAWING NUMBER:
 D-01

DATE:
 05.15.2025
 SCALE:
 AS NOTED

NOTE:
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 CONSTRUCTION IF (AND ONLY IF) A
 PERMIT IS ISSUED, BASED ON THIS
 DRAWING, BY THE VILLAGE OF PORT
 CHESTER.



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PROPERTY ADDRESS:

 PORT CHESTER, NY 10573
 (VILLAGE OF PORT CHESTER
 BUILDING DEPARTMENT)

S-B-L:

CLIENT:
 *** ***

TEL: ***
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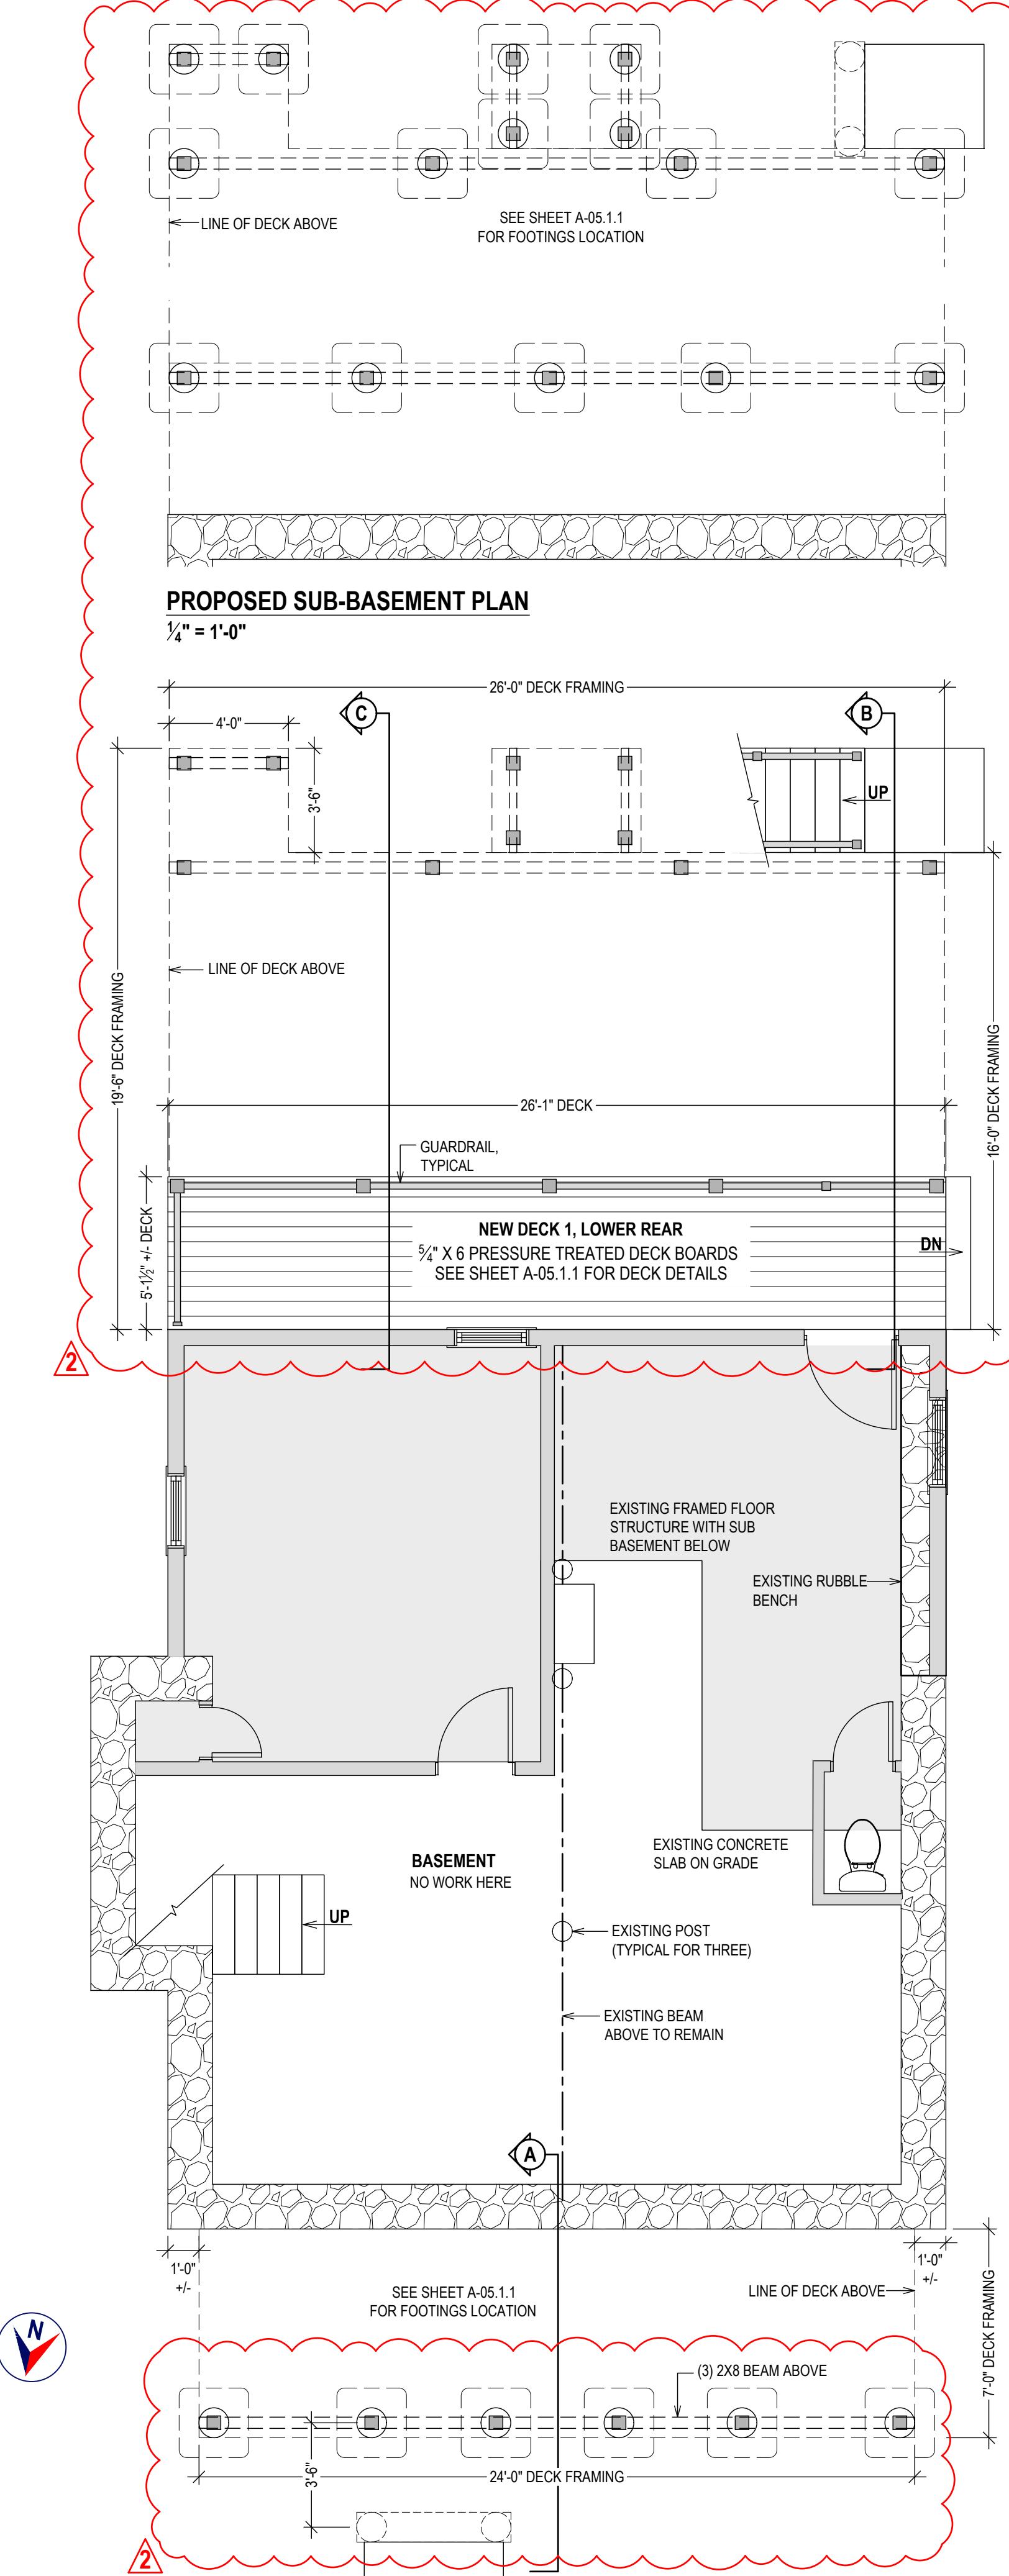
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 FLOOR PLAN ALTERATION

DRAWING NAME:
 EXISTING AND DEMOLITION
 02

DRAWING NUMBER:
 D-02



DATE:
 05.15.2025
 SCALE:
 AS NOTED

NOTE:
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 CONSTRUCTION IF (AND ONLY IF) A
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 DRAWING, BY THE VILLAGE OF PORT
 CHESTER.



DOOR SCHEDULE									
TO BE APPROVED BY OWNER									
CONFIRM ALL DIMENSIONS									
MARK	NO.	TYPE	MODEL**	HAND	WIDE*	HIGH*	HARDWARE**	OTHER	
D-1	1	ANDERSEN A 100-SERIES PATIO DOOR			71 1/4"	79 1/2"	ENTRY	SLIDING	
D-2	1	12 LITE PRIMED STEEL PREHUNG FRONT DOOR		L.H.	36"	80"	ENTRY	OUTSWING	
INTERIORS	VARIES	MATCH WITH EXISTING			-	-	-	VARIES	

NOTES: **ALL ITEMS ABOVE ARE SUBJECT TO OWNER APPROVAL AND/OR AS SELECTED BY OWNER;
 * CONFIRM ALL DIMENSIONS BEFORE ORDERING DOORS

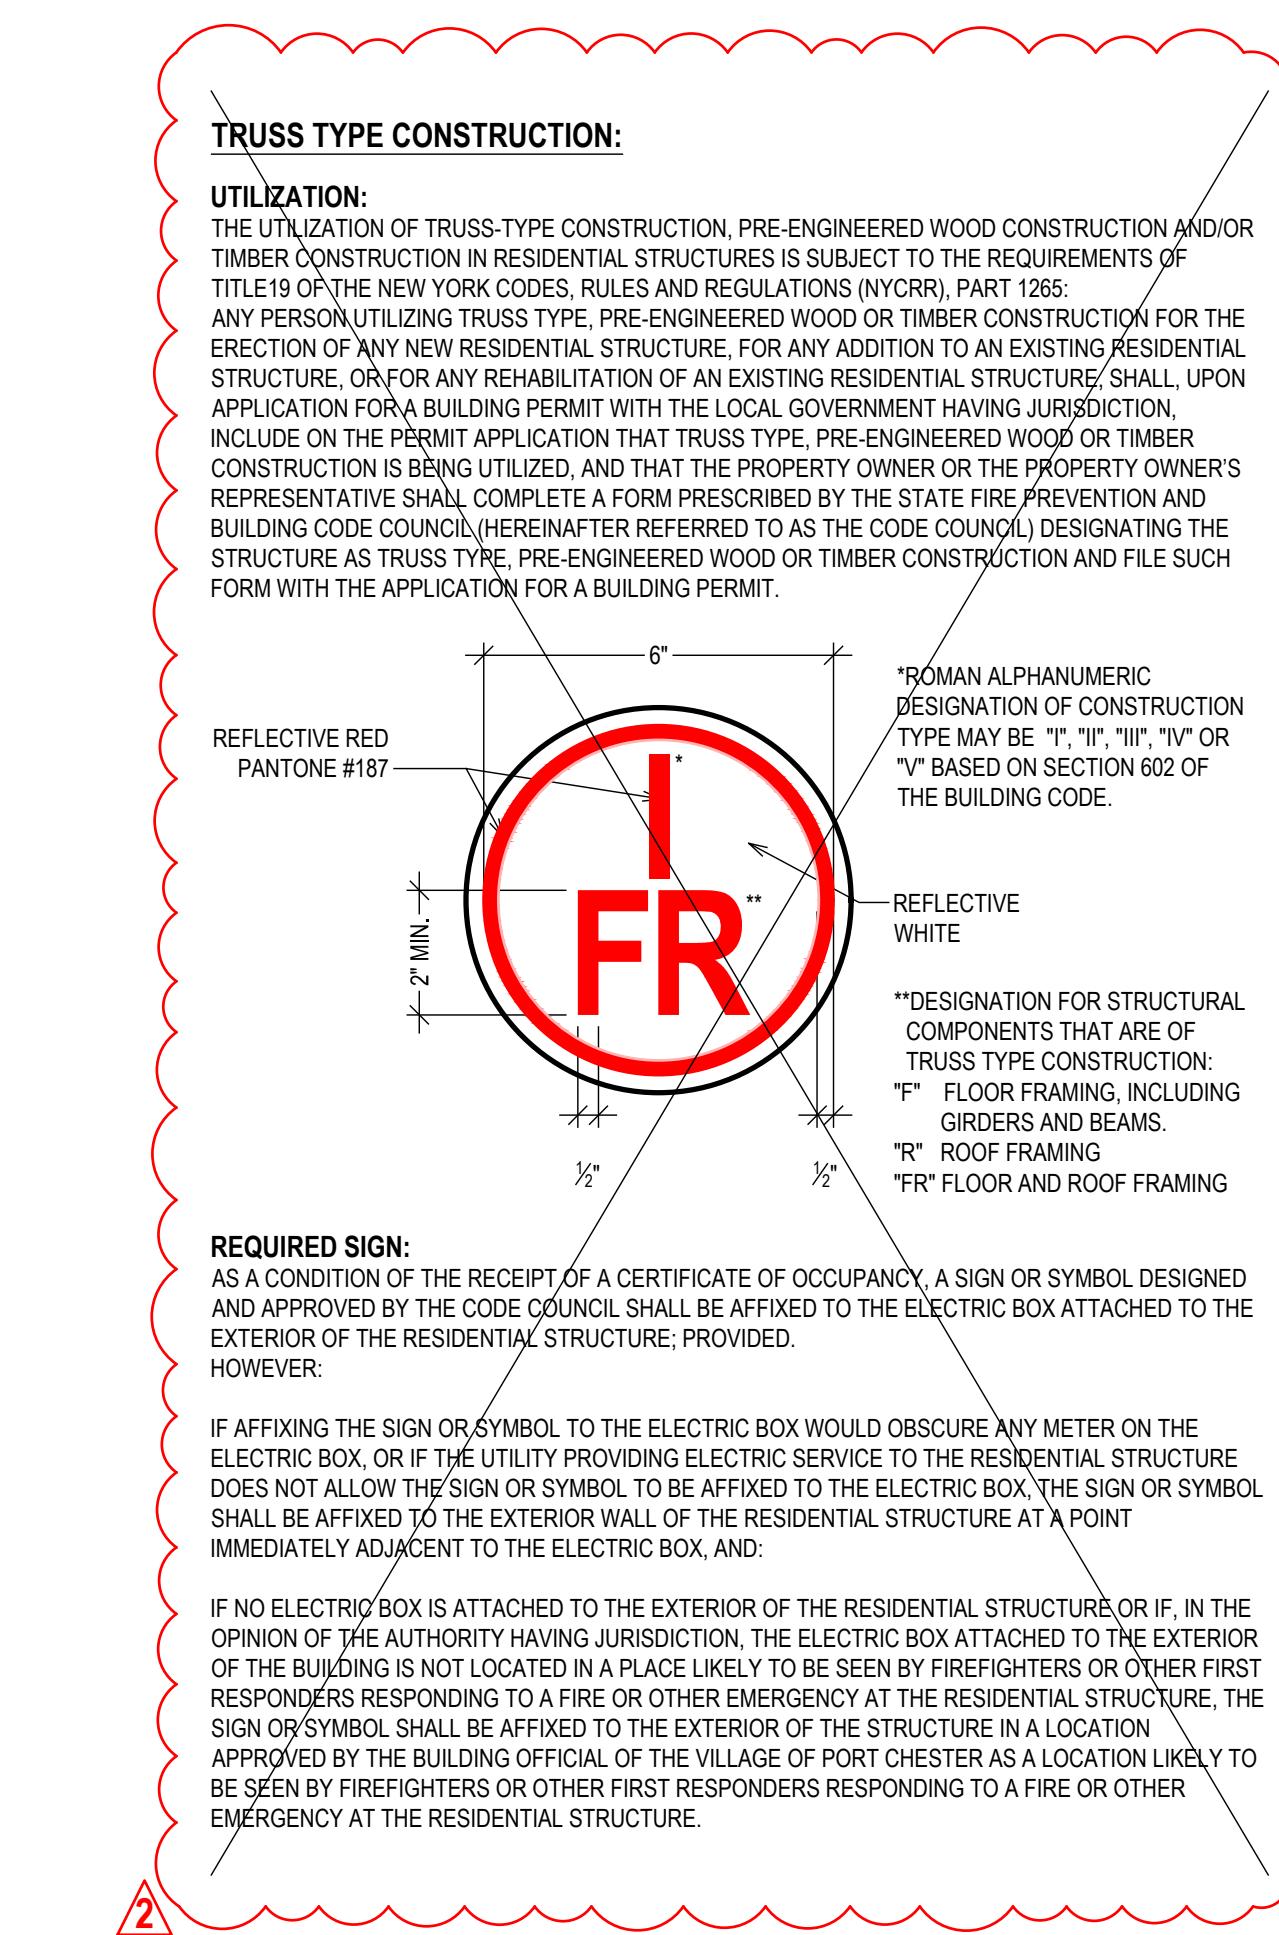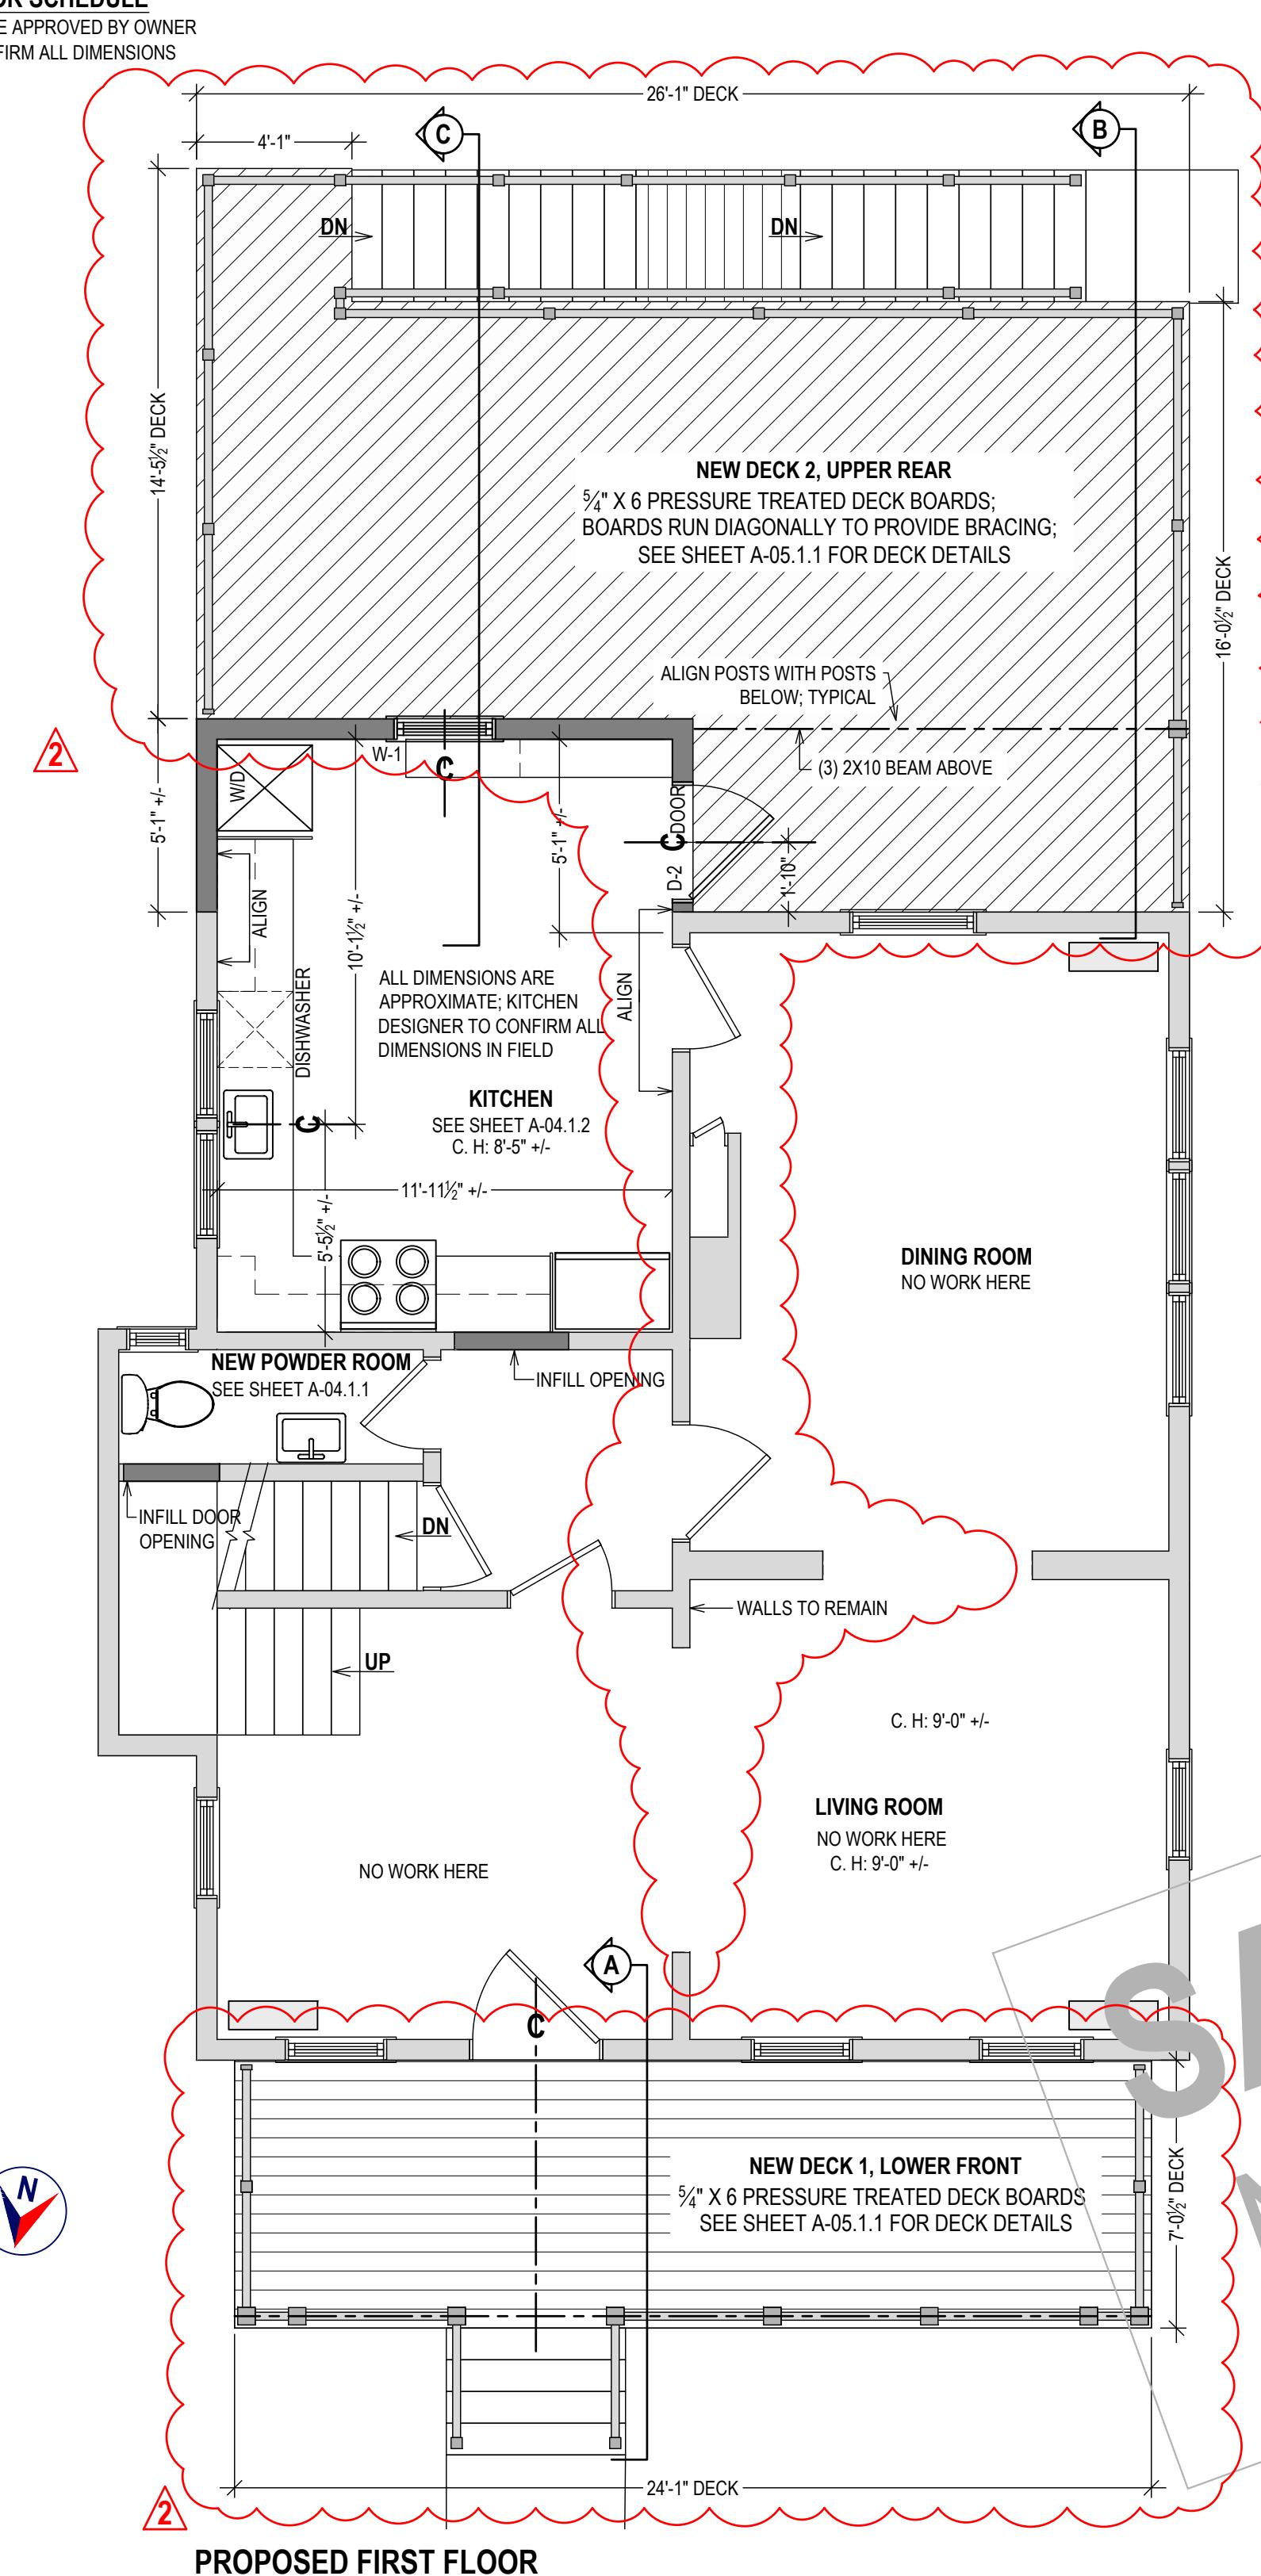

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EXISTING TO PER AI

NEW 2X FRAME WALL;
MATCH WITH INTERIOR AND EXTERIOR EXISTING WALL;
ALIGN INTERIOR AND EXTERIOR FINISHES

EXISTING RADIATOR TO REMAIN

7'-0½" DECK

This diagram illustrates a wall section with a large, diagonal watermark reading "SAMPLE ONLY NOT FOR REPRODUCTION OR UNAUTHORIZED USE". The diagram shows a wall section with a "NEW 2X FRAME WALL" being added to an "EXISTING TO PER AI" wall. The new wall is to be aligned with the interior and exterior existing walls and match their finishes. An "EXISTING RADIATOR TO REMAIN" is indicated. A dimension line shows a height of "7'-0½" for the deck. The diagram is a technical architectural drawing.

Oliver Engineering, P.C.
Design - Permit Applications - Legalizations
Code Compliance - Project Supervision
188 Main Street | Staten Island, NY 10301 | (914) 774-9878 | www.proeng.nyc | vc@proeng.nyc

PROPERTY ADDRESS:
PORT CHESTER, NY 10573
VILLAGE OF PORT CHESTER
BUILDING DEPARTMENT)

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TE: ISSUE:
15.2025 PRELIMINARY
23.2025 FOR PERMIT
15.2025 FOR PERMIT
04.2025 AMENDMENT


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DOOR PLAN ALTERATION

**DRAWING NAME:
PROPOSED 01**

DRAWING NUMBER:
11.1


DATE:
15.2025

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REAR STAIRS LANDING FRAMING

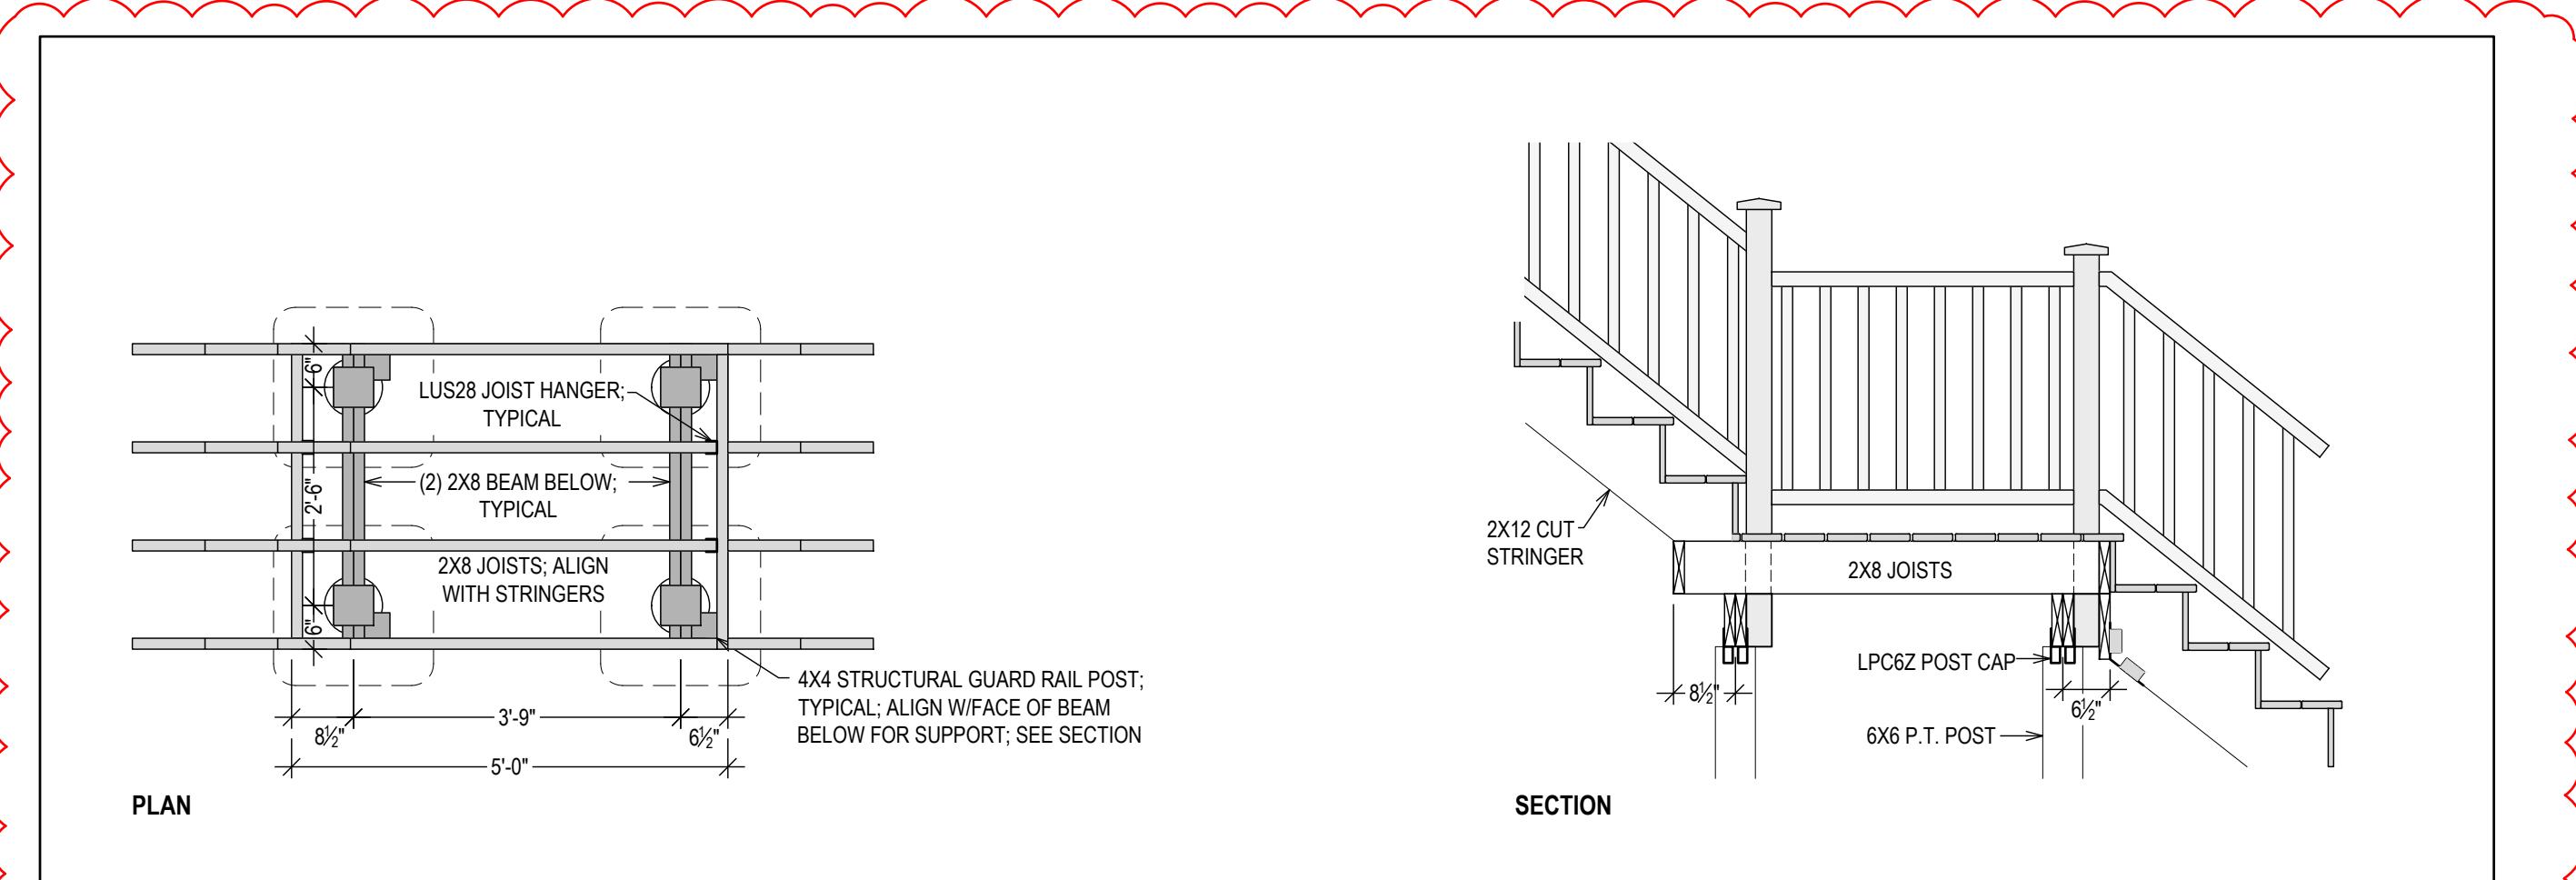
$\frac{1}{2}'' = 1'-0"$



FRONT ELEVATION

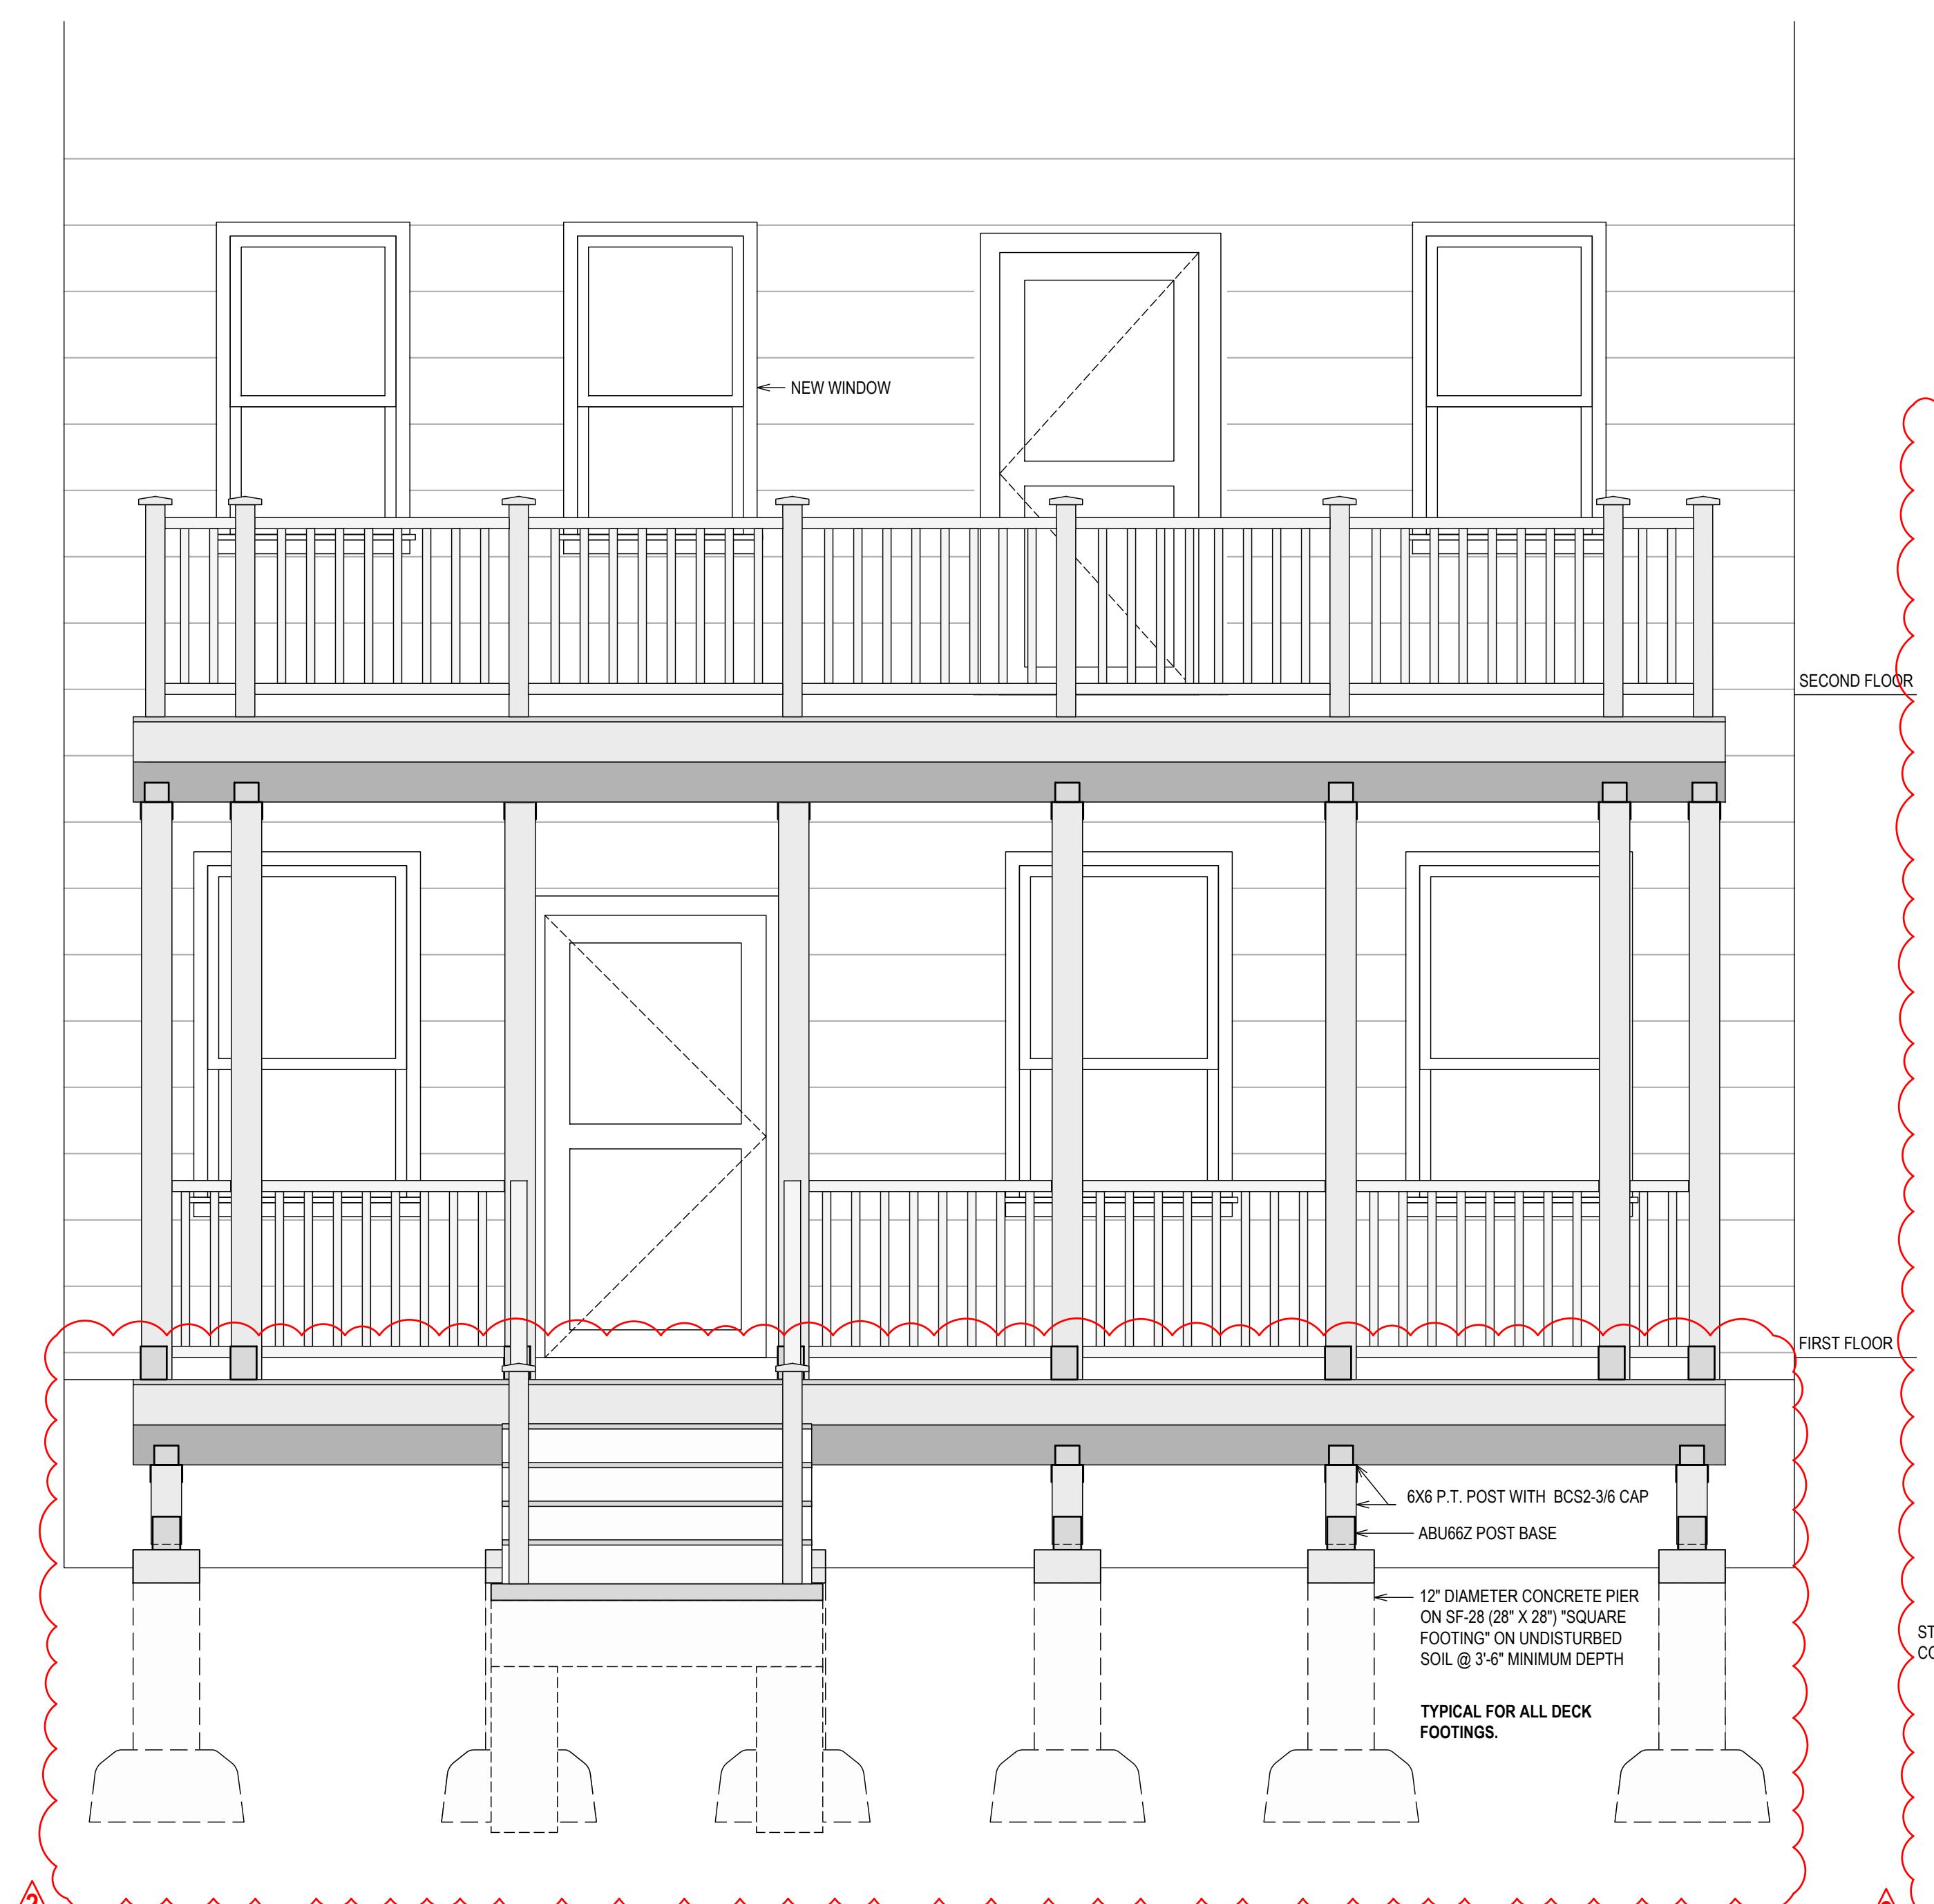$\frac{1}{2}'' = 1'-0"$

THIS DRAWING IS AS A SAMPLE ONLY
 ** PERSONAL (CLIENT) INFORMATION WITHHELD

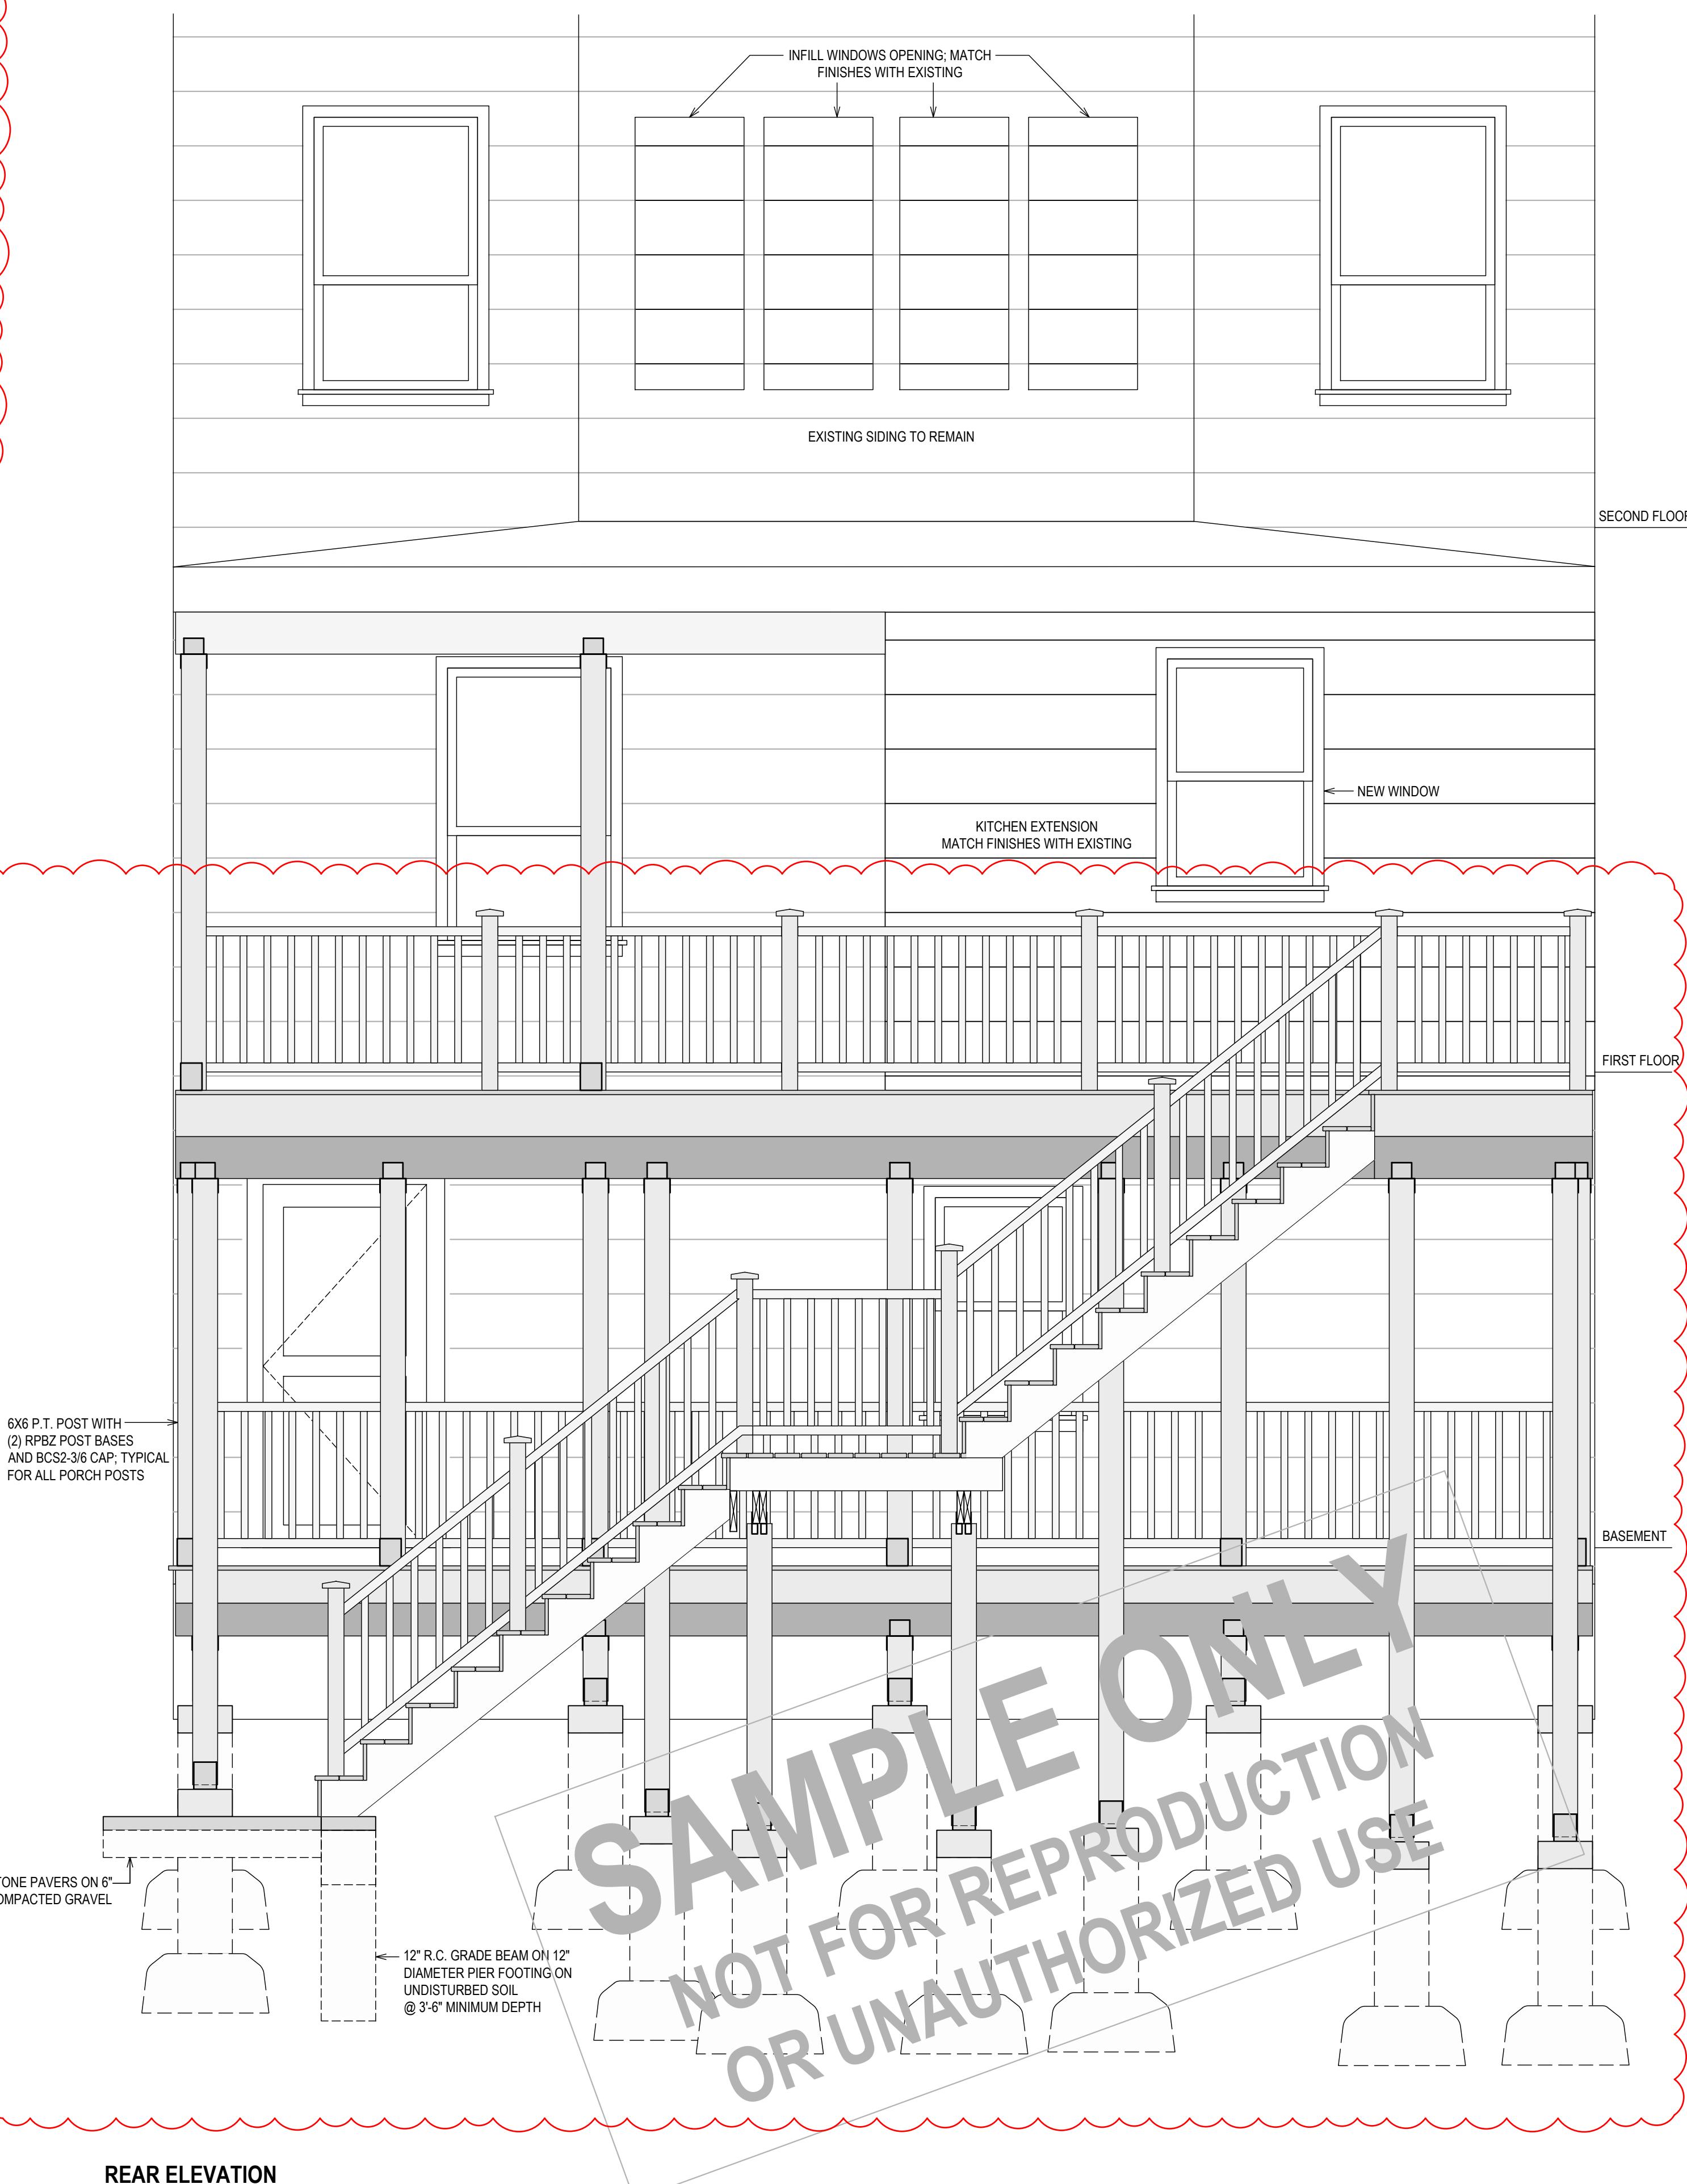

REAR ELEVATION

$\frac{1}{2}'' = 1'-0"$

SAMPLE ONLY
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 OR UNAUTHORIZED USE

PROPERTY ADDRESS:

 PORT CHESTER, NY 10573
 (VILLAGE OF PORT CHESTER
 BUILDING DEPARTMENT)

S-B-L:

CLIENT:
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TEL: ***
 EMAIL:

DATE: ISSUE:
 05.15.2025 PRELIMINARY
 07.23.2025 FOR PERMIT
 08.15.2025 FOR PERMIT
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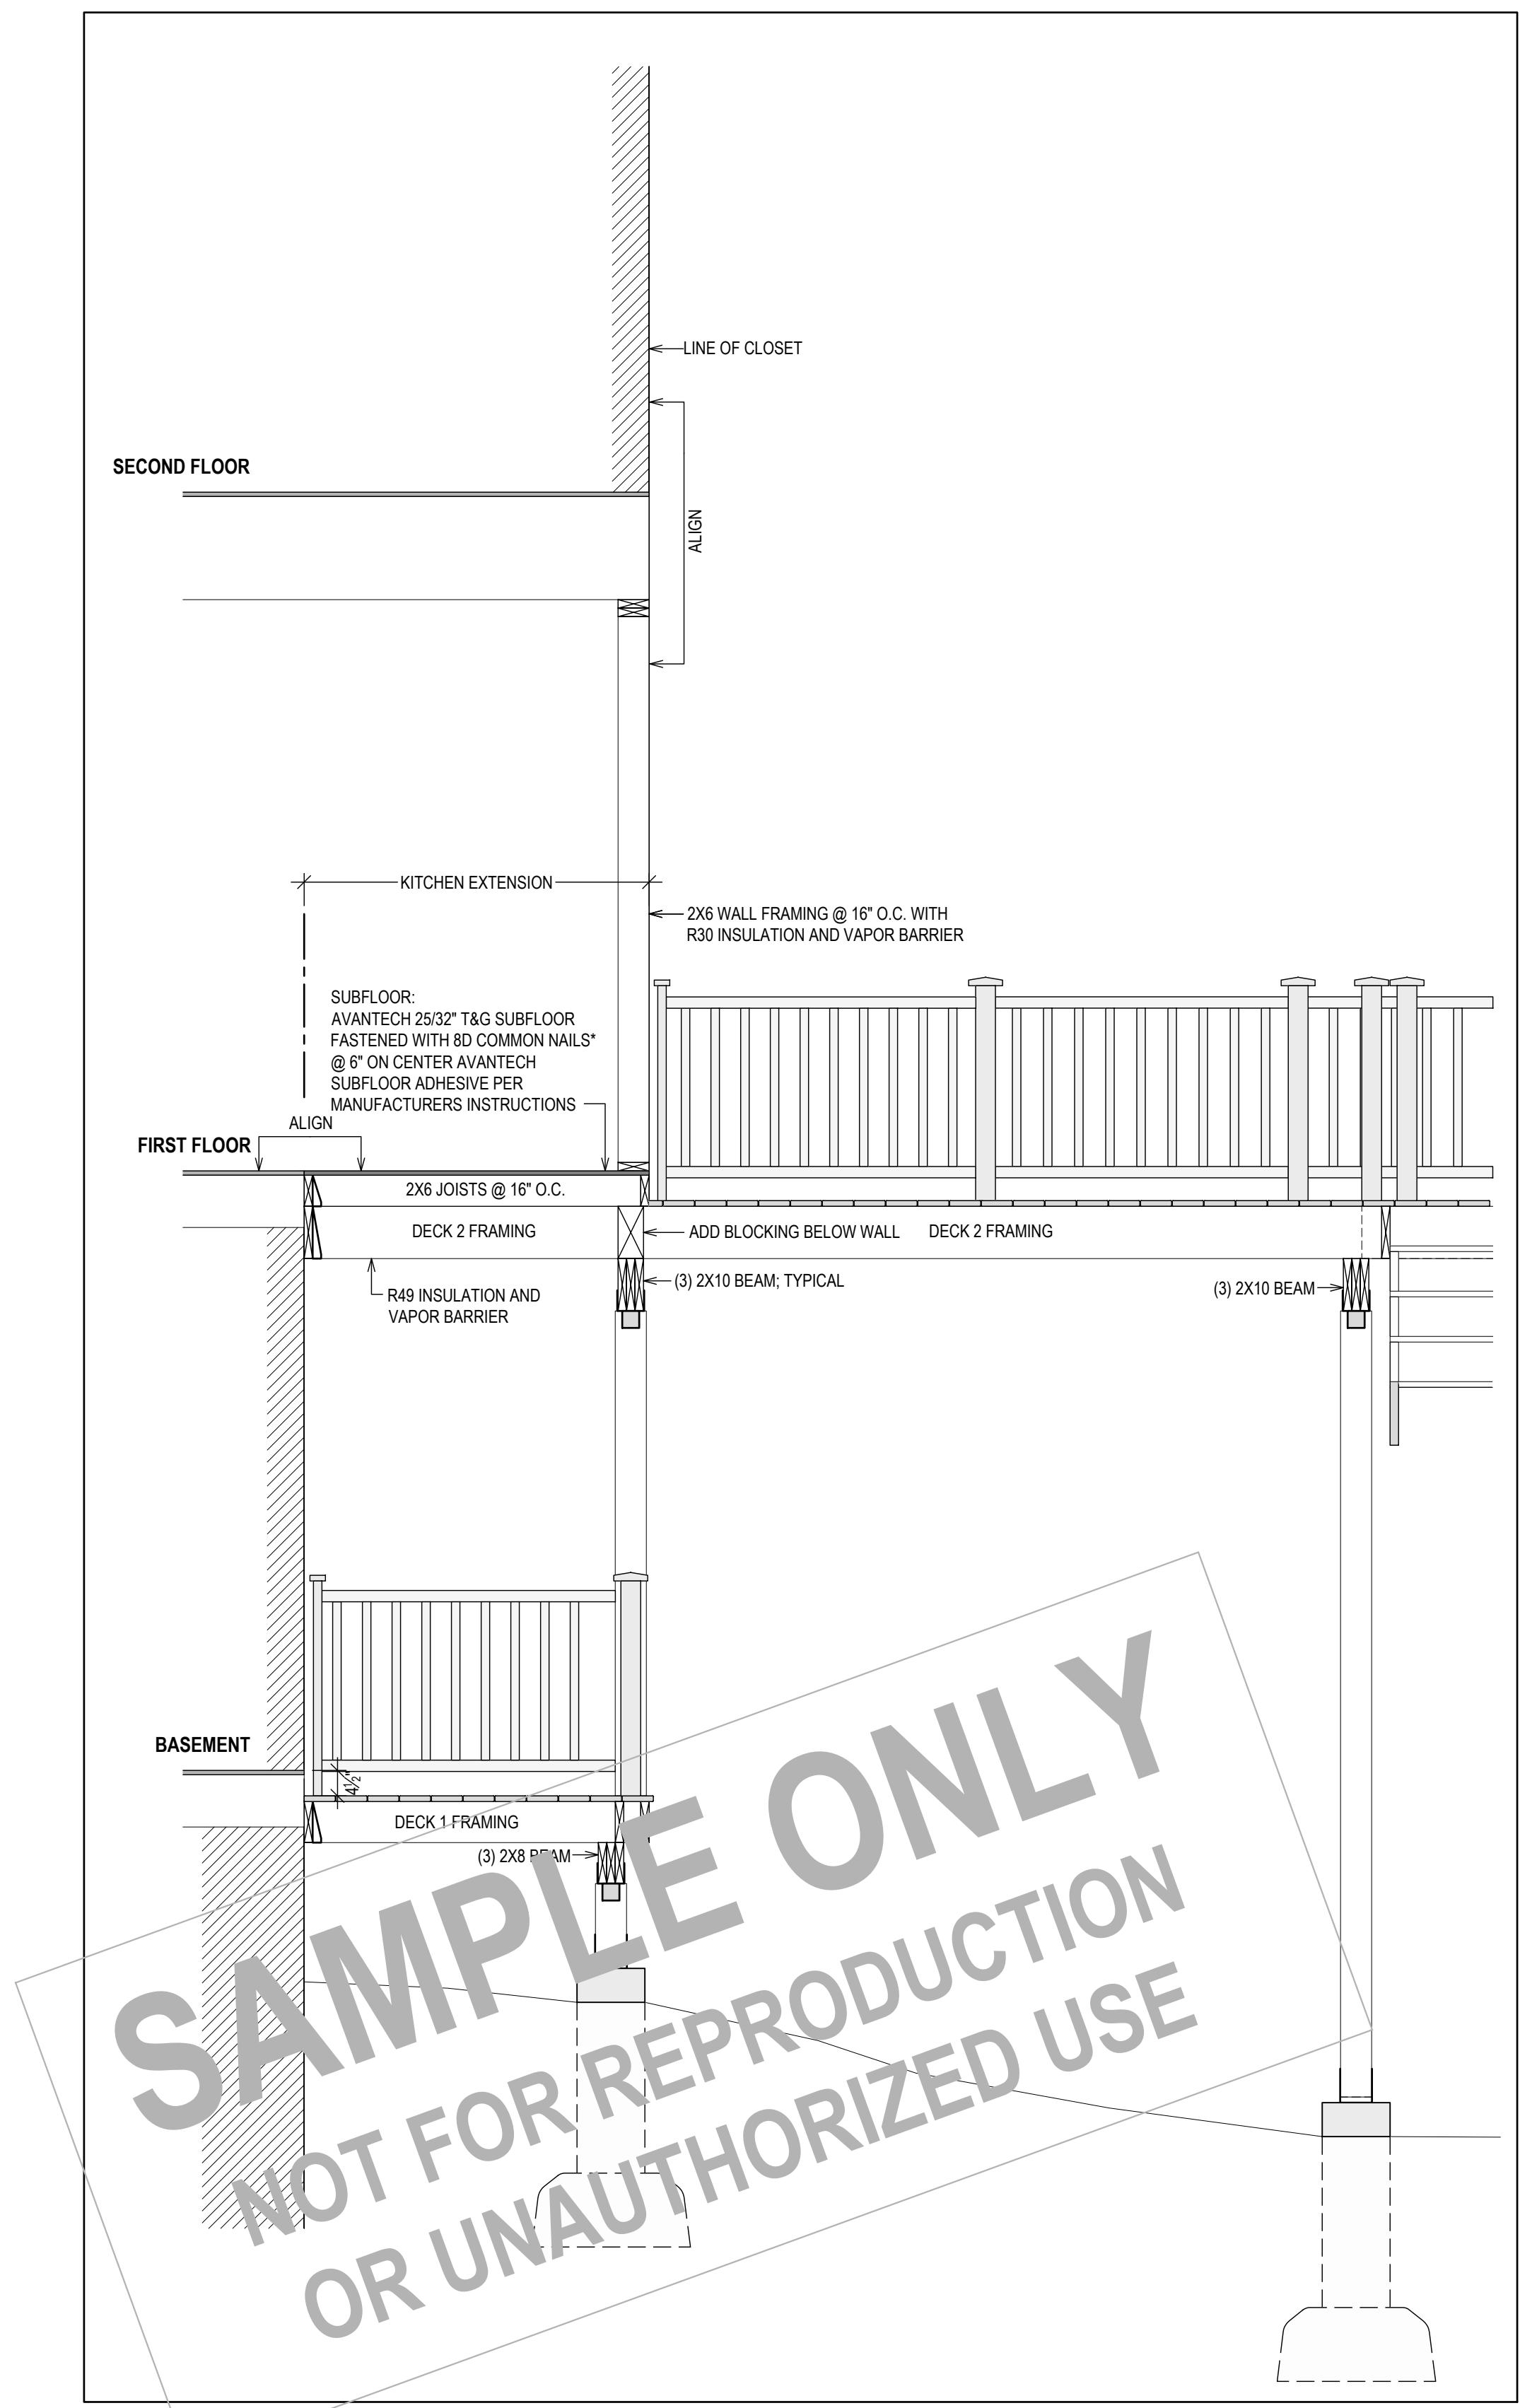
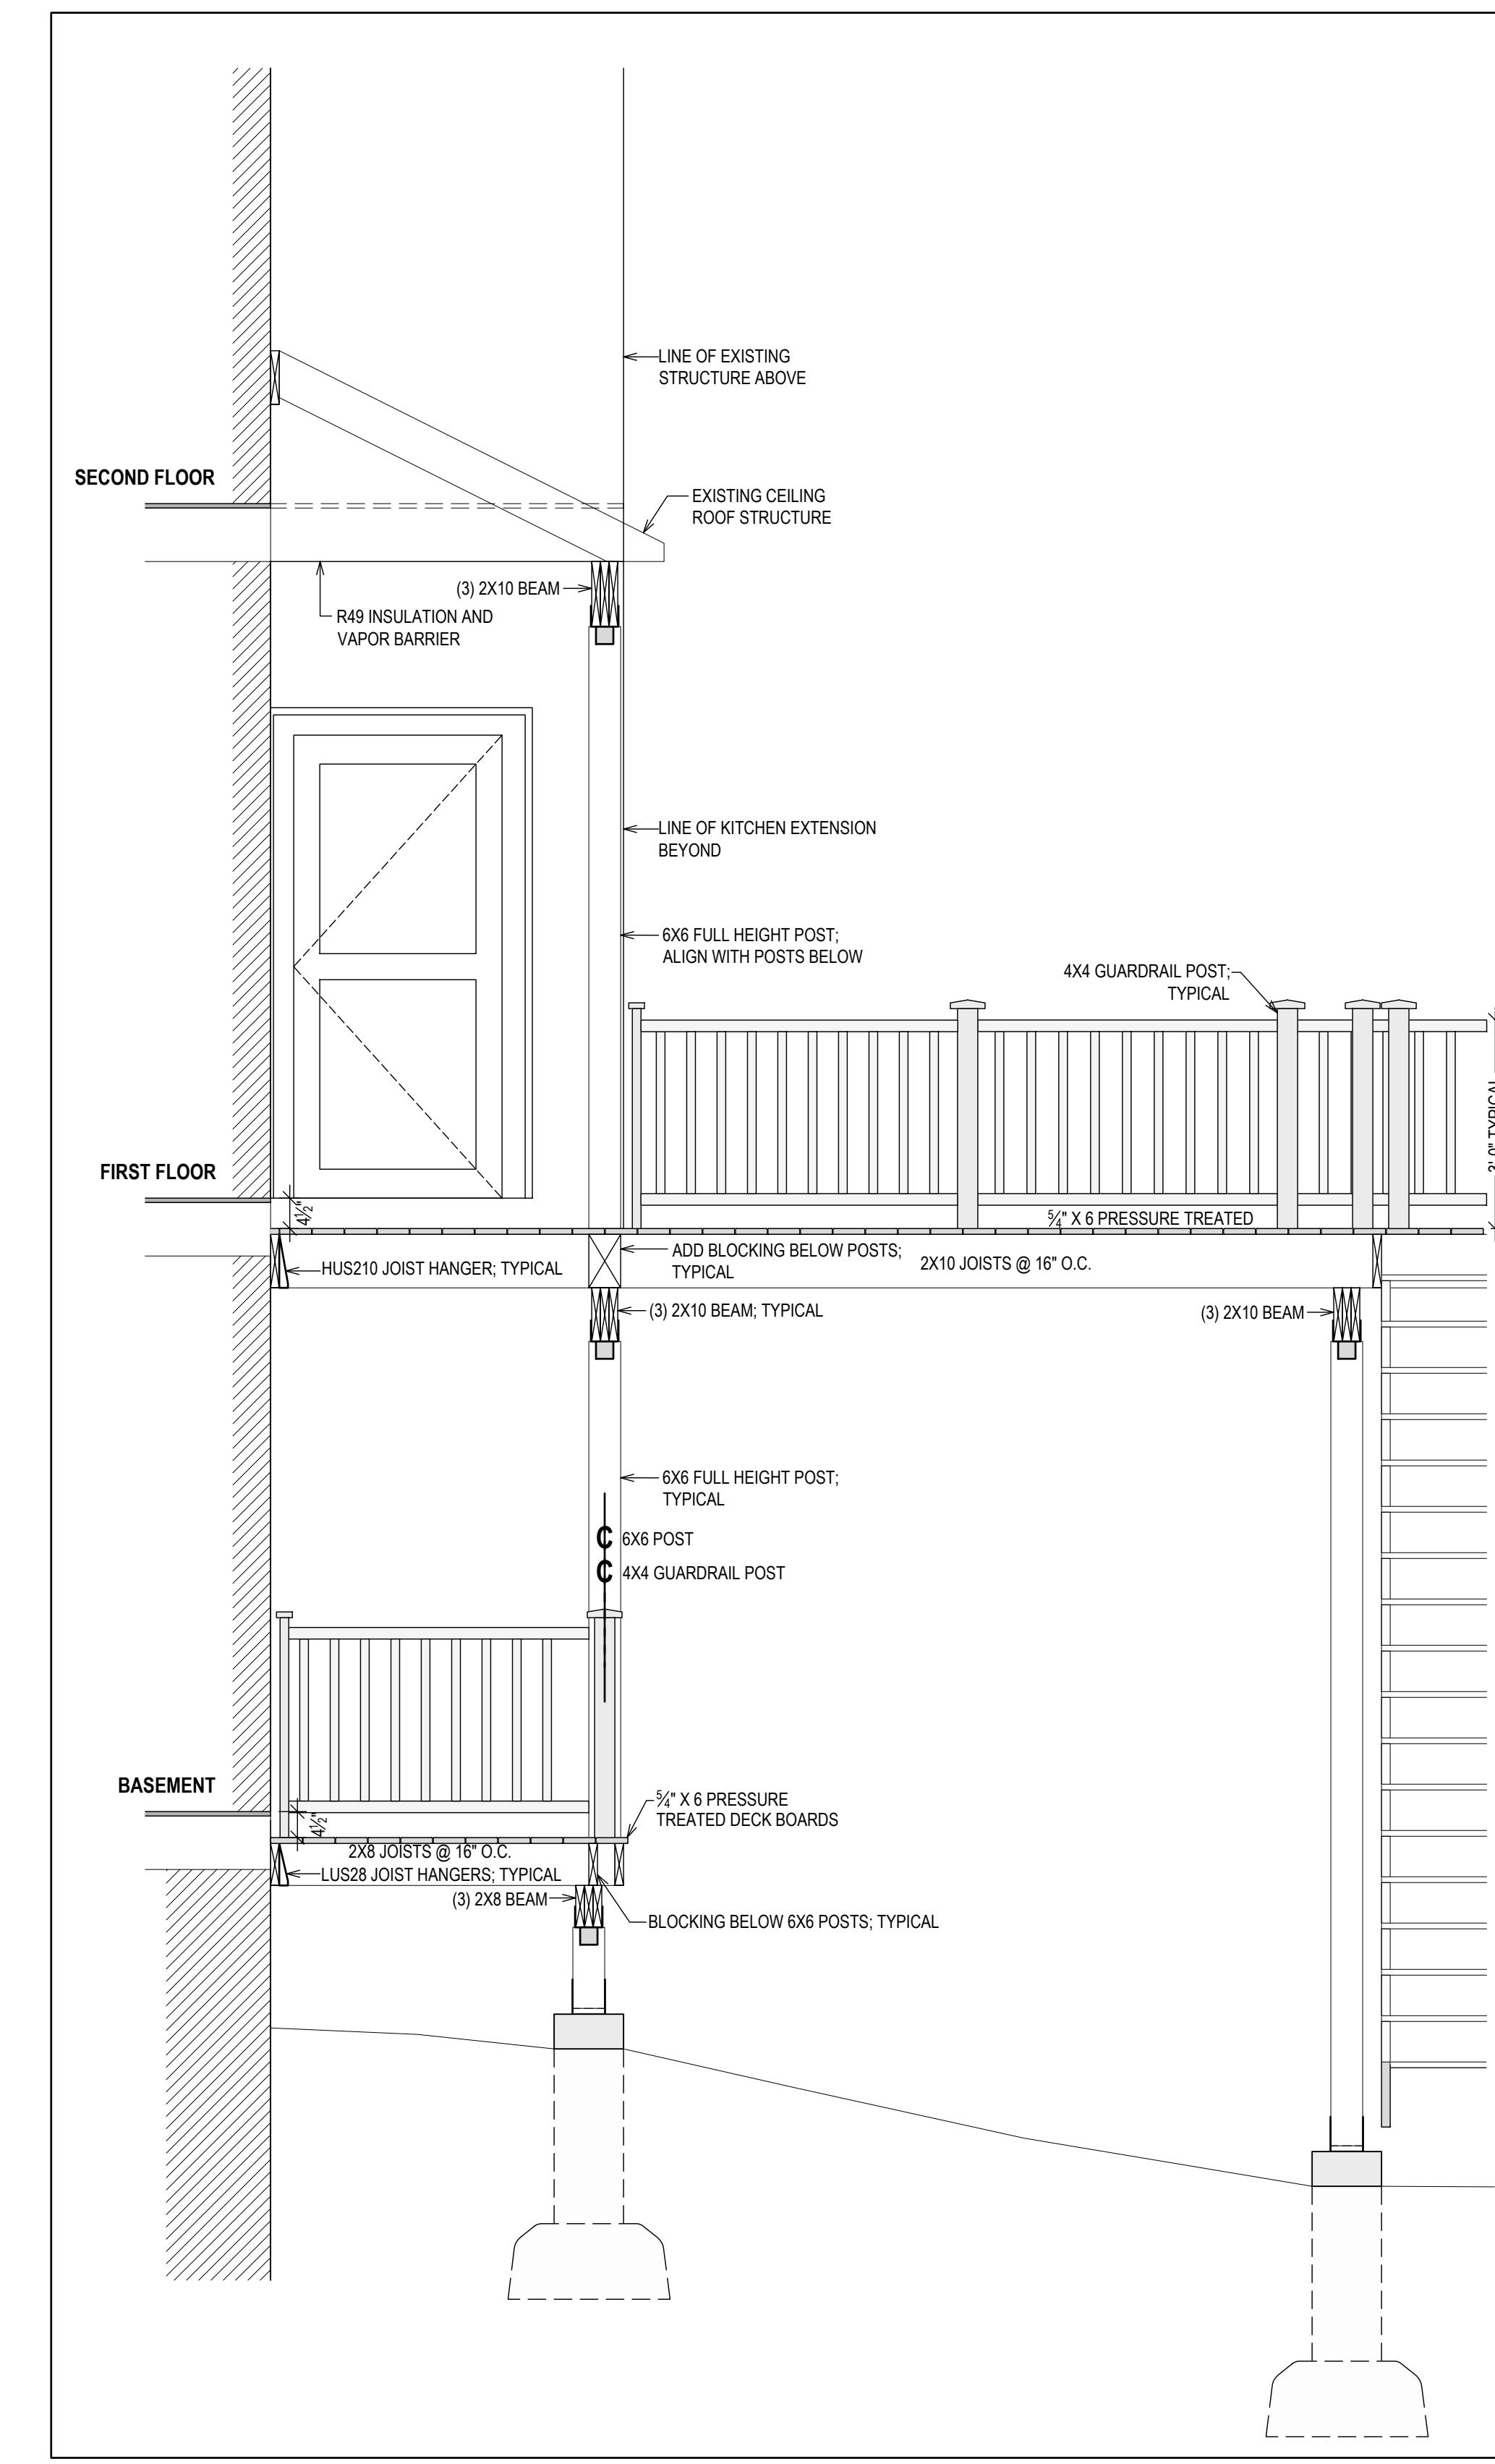
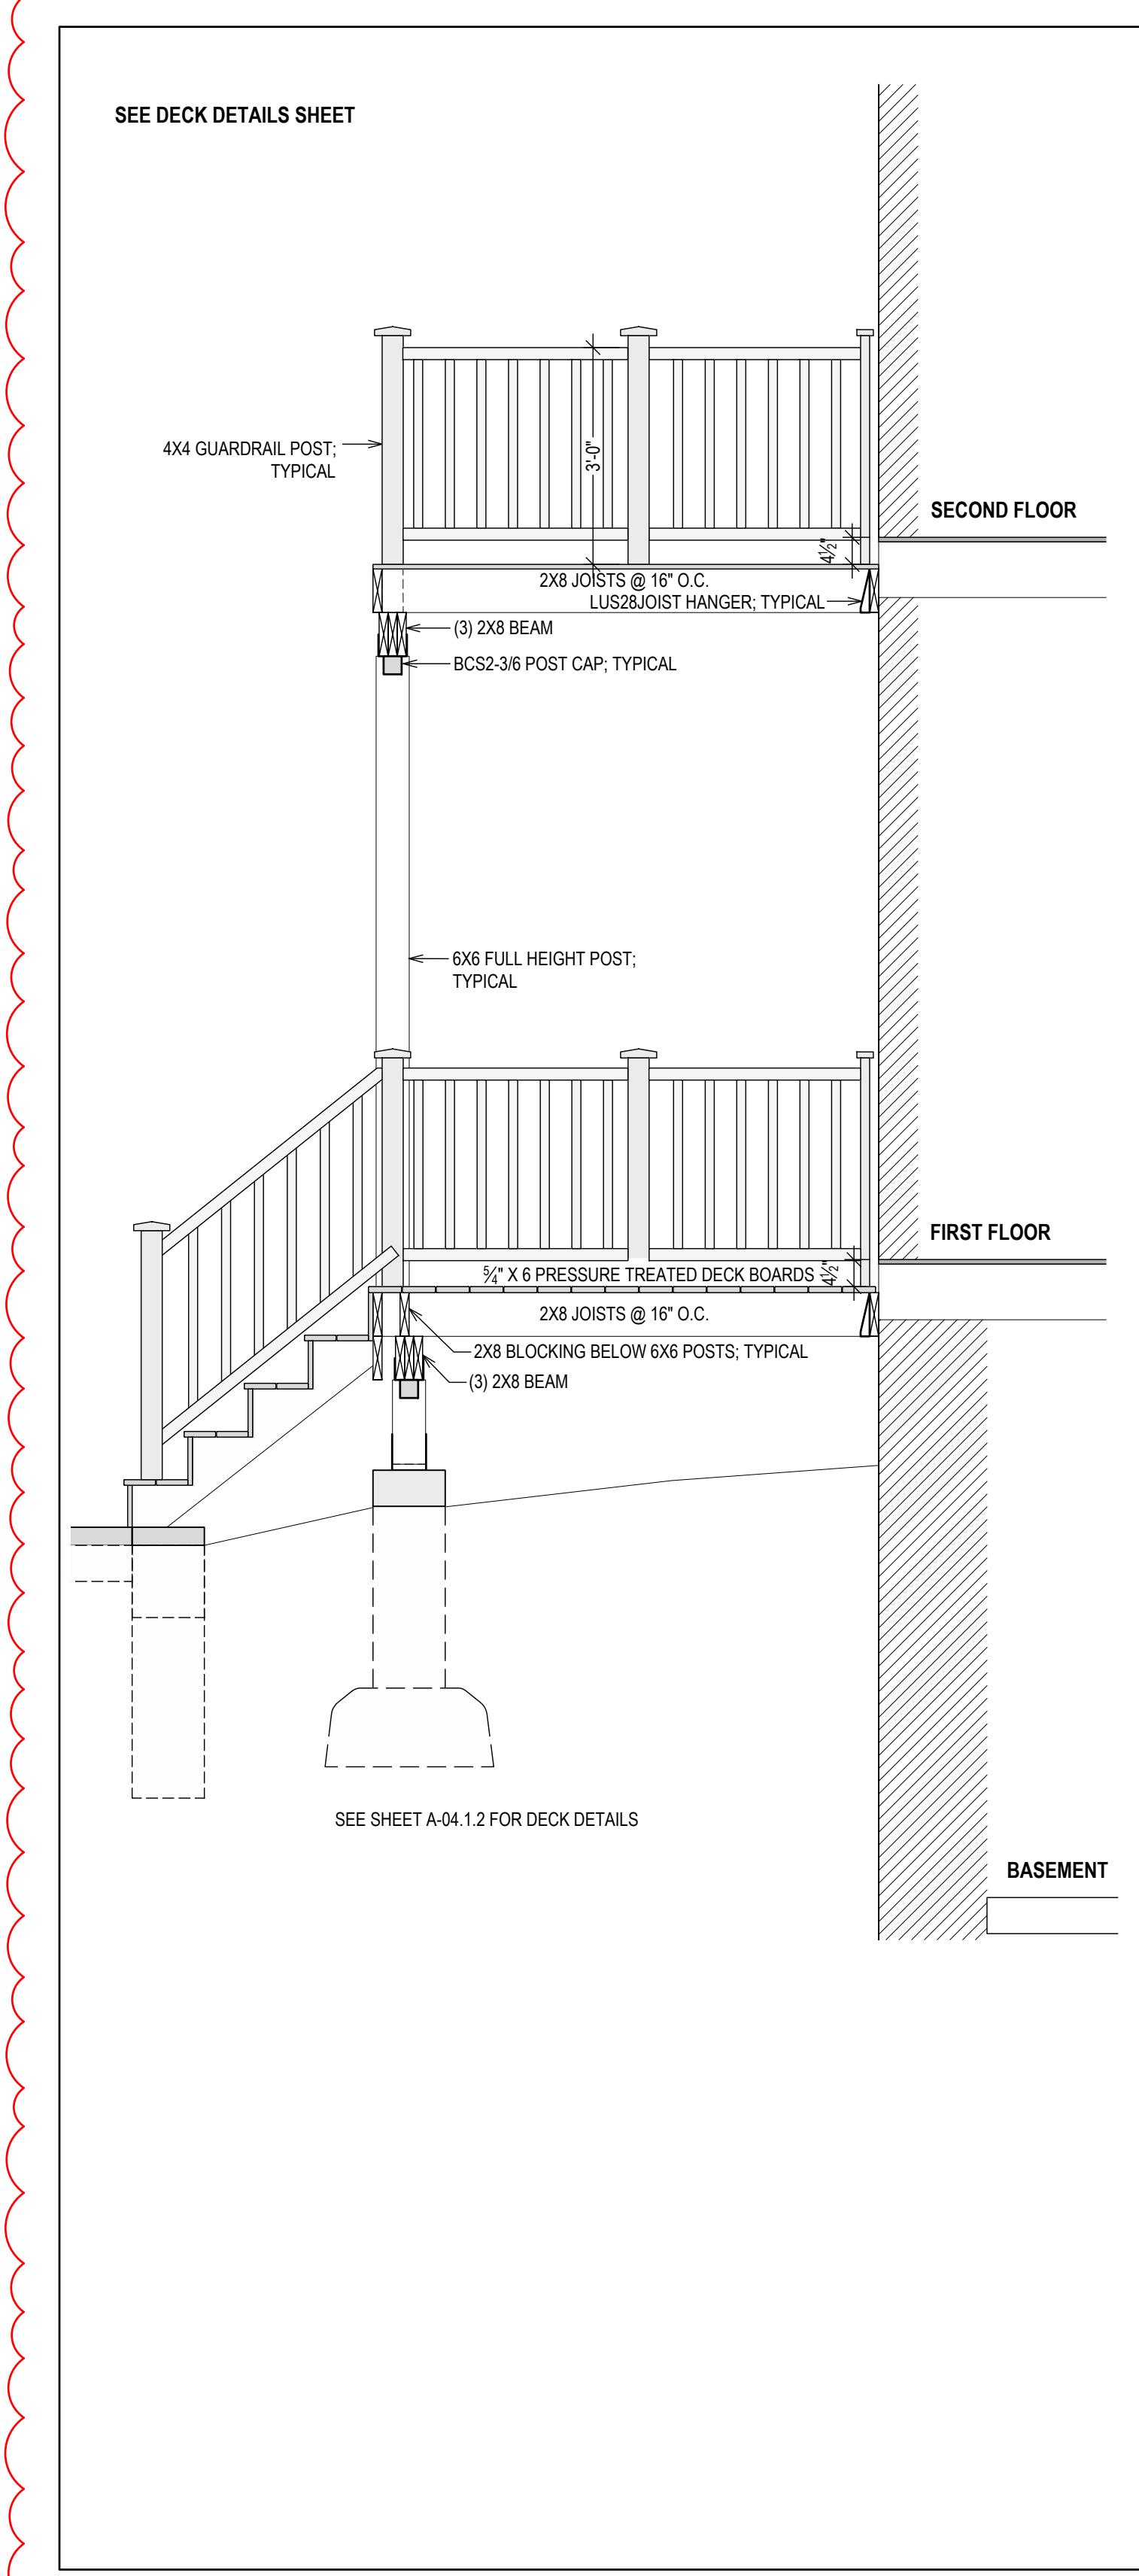
PROJECT NAME:
 FLOOR PLAN ALTERATION

DRAWING NAME:
 ELEVATIONS

DRAWING NUMBER:
 A-02.1

DATE:
 05.15.2025
 SCALE:
 AS NOTED

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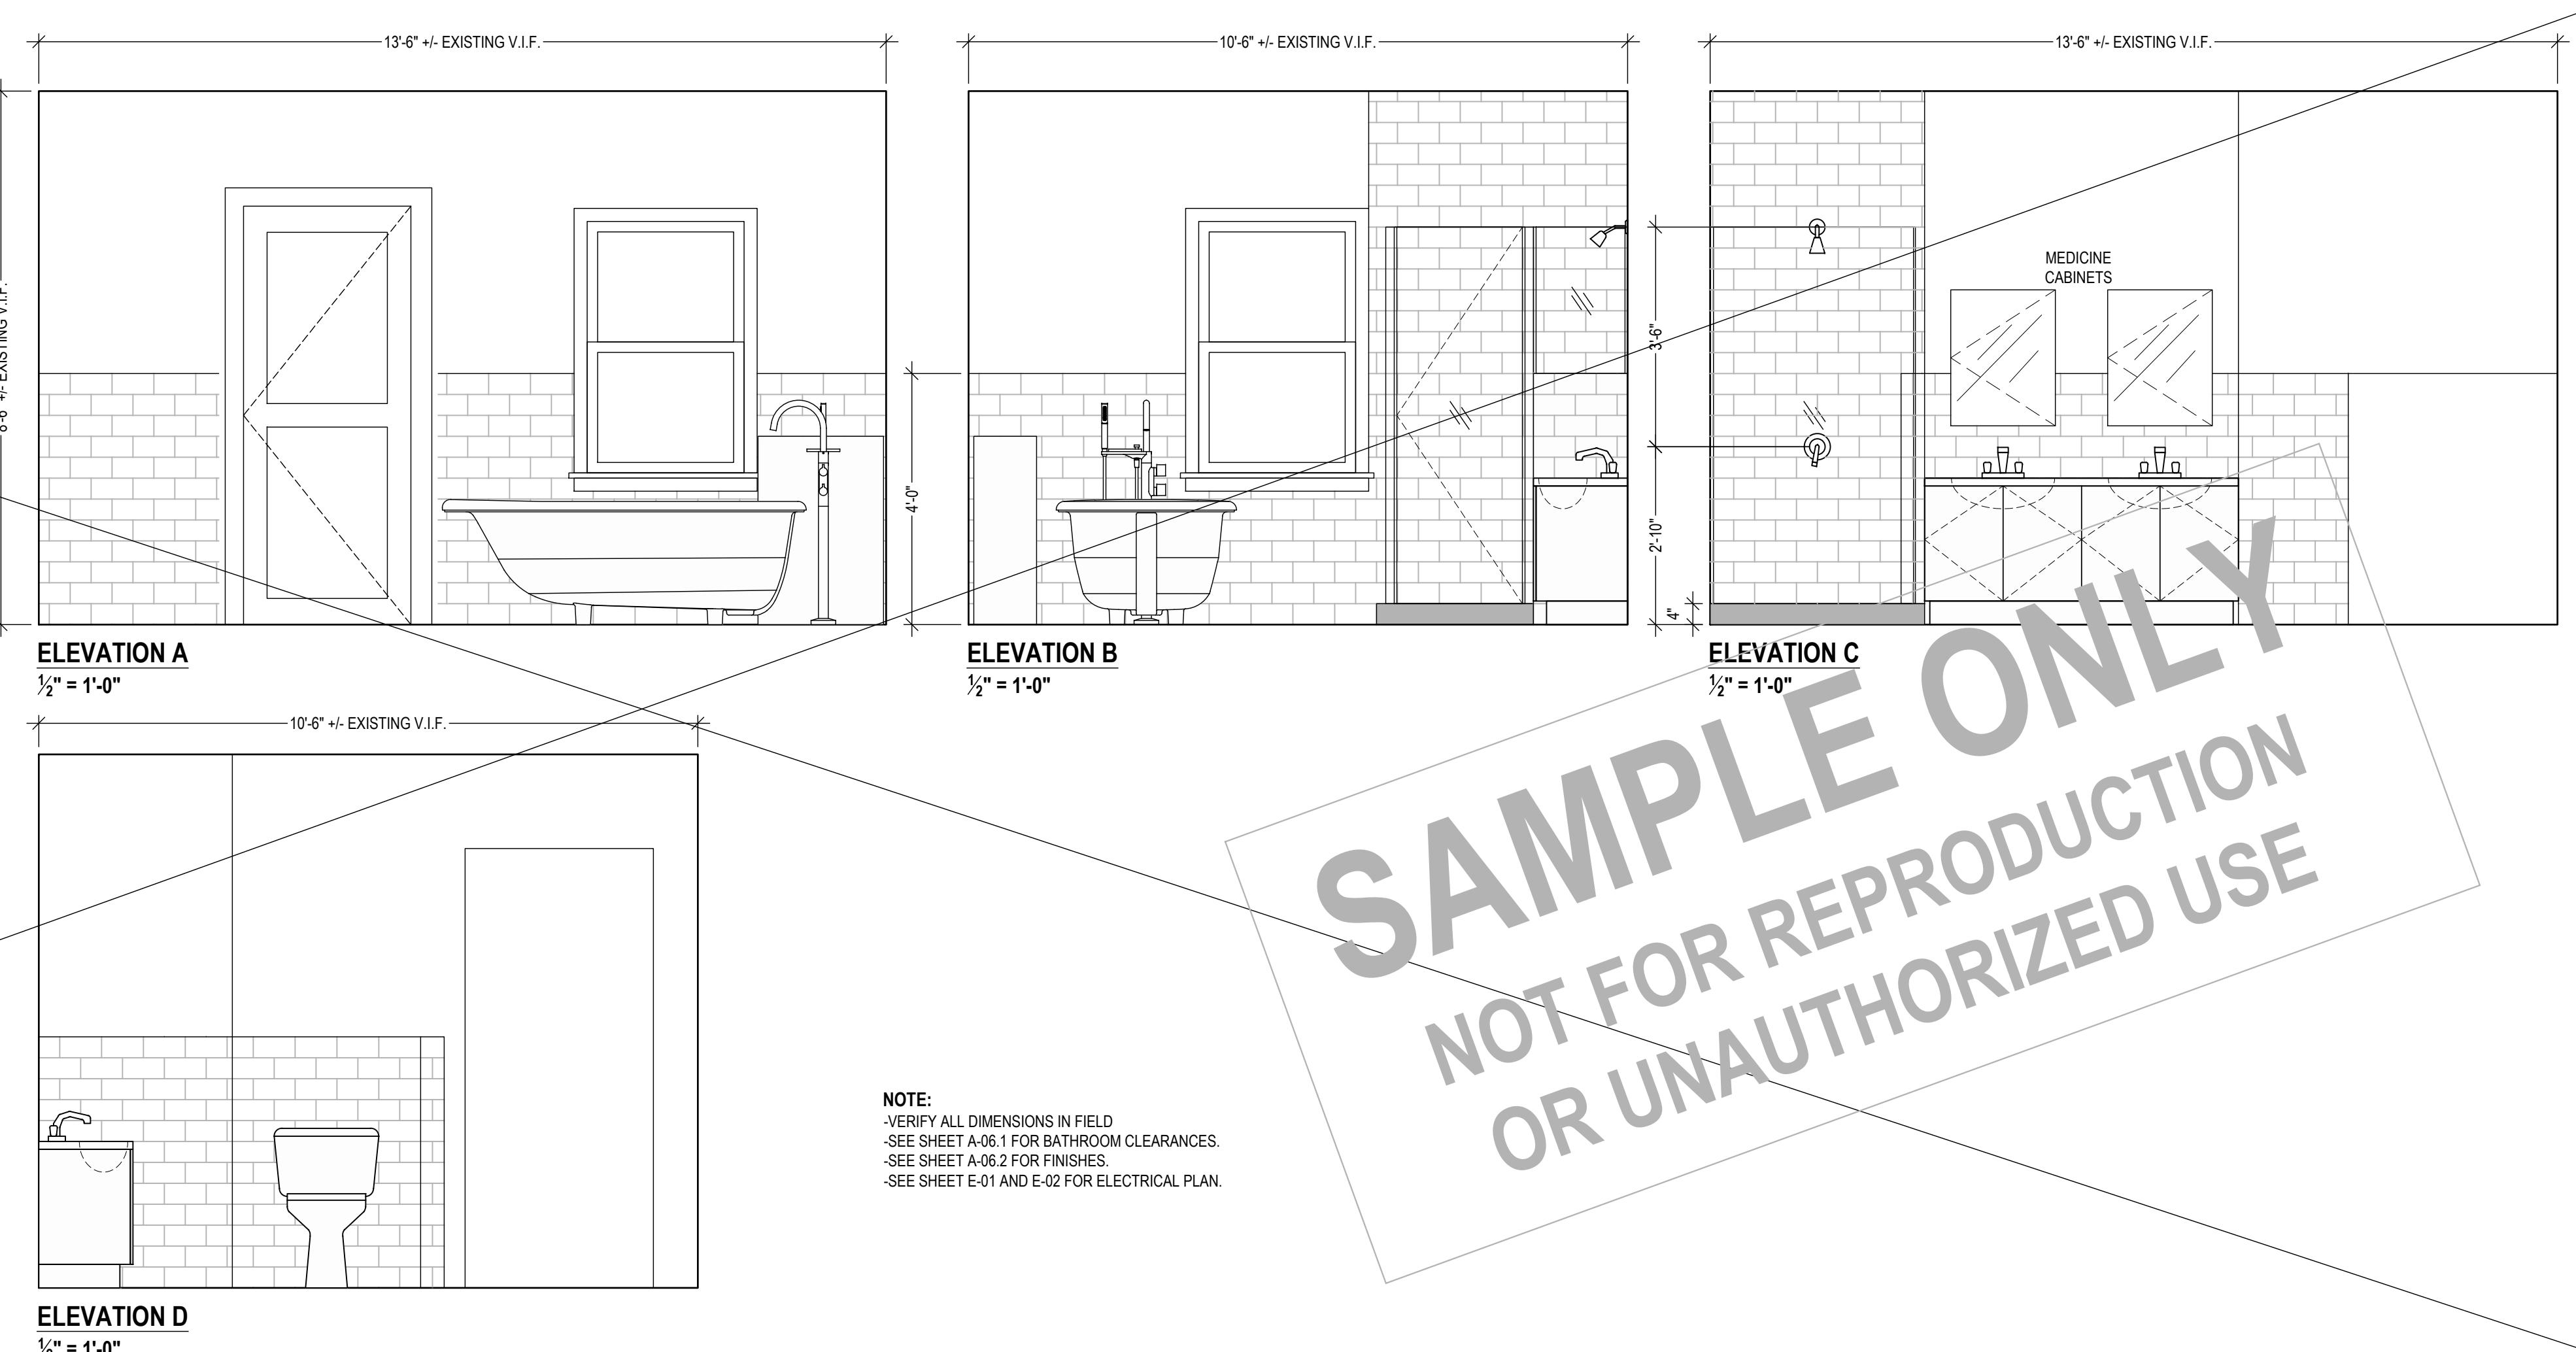
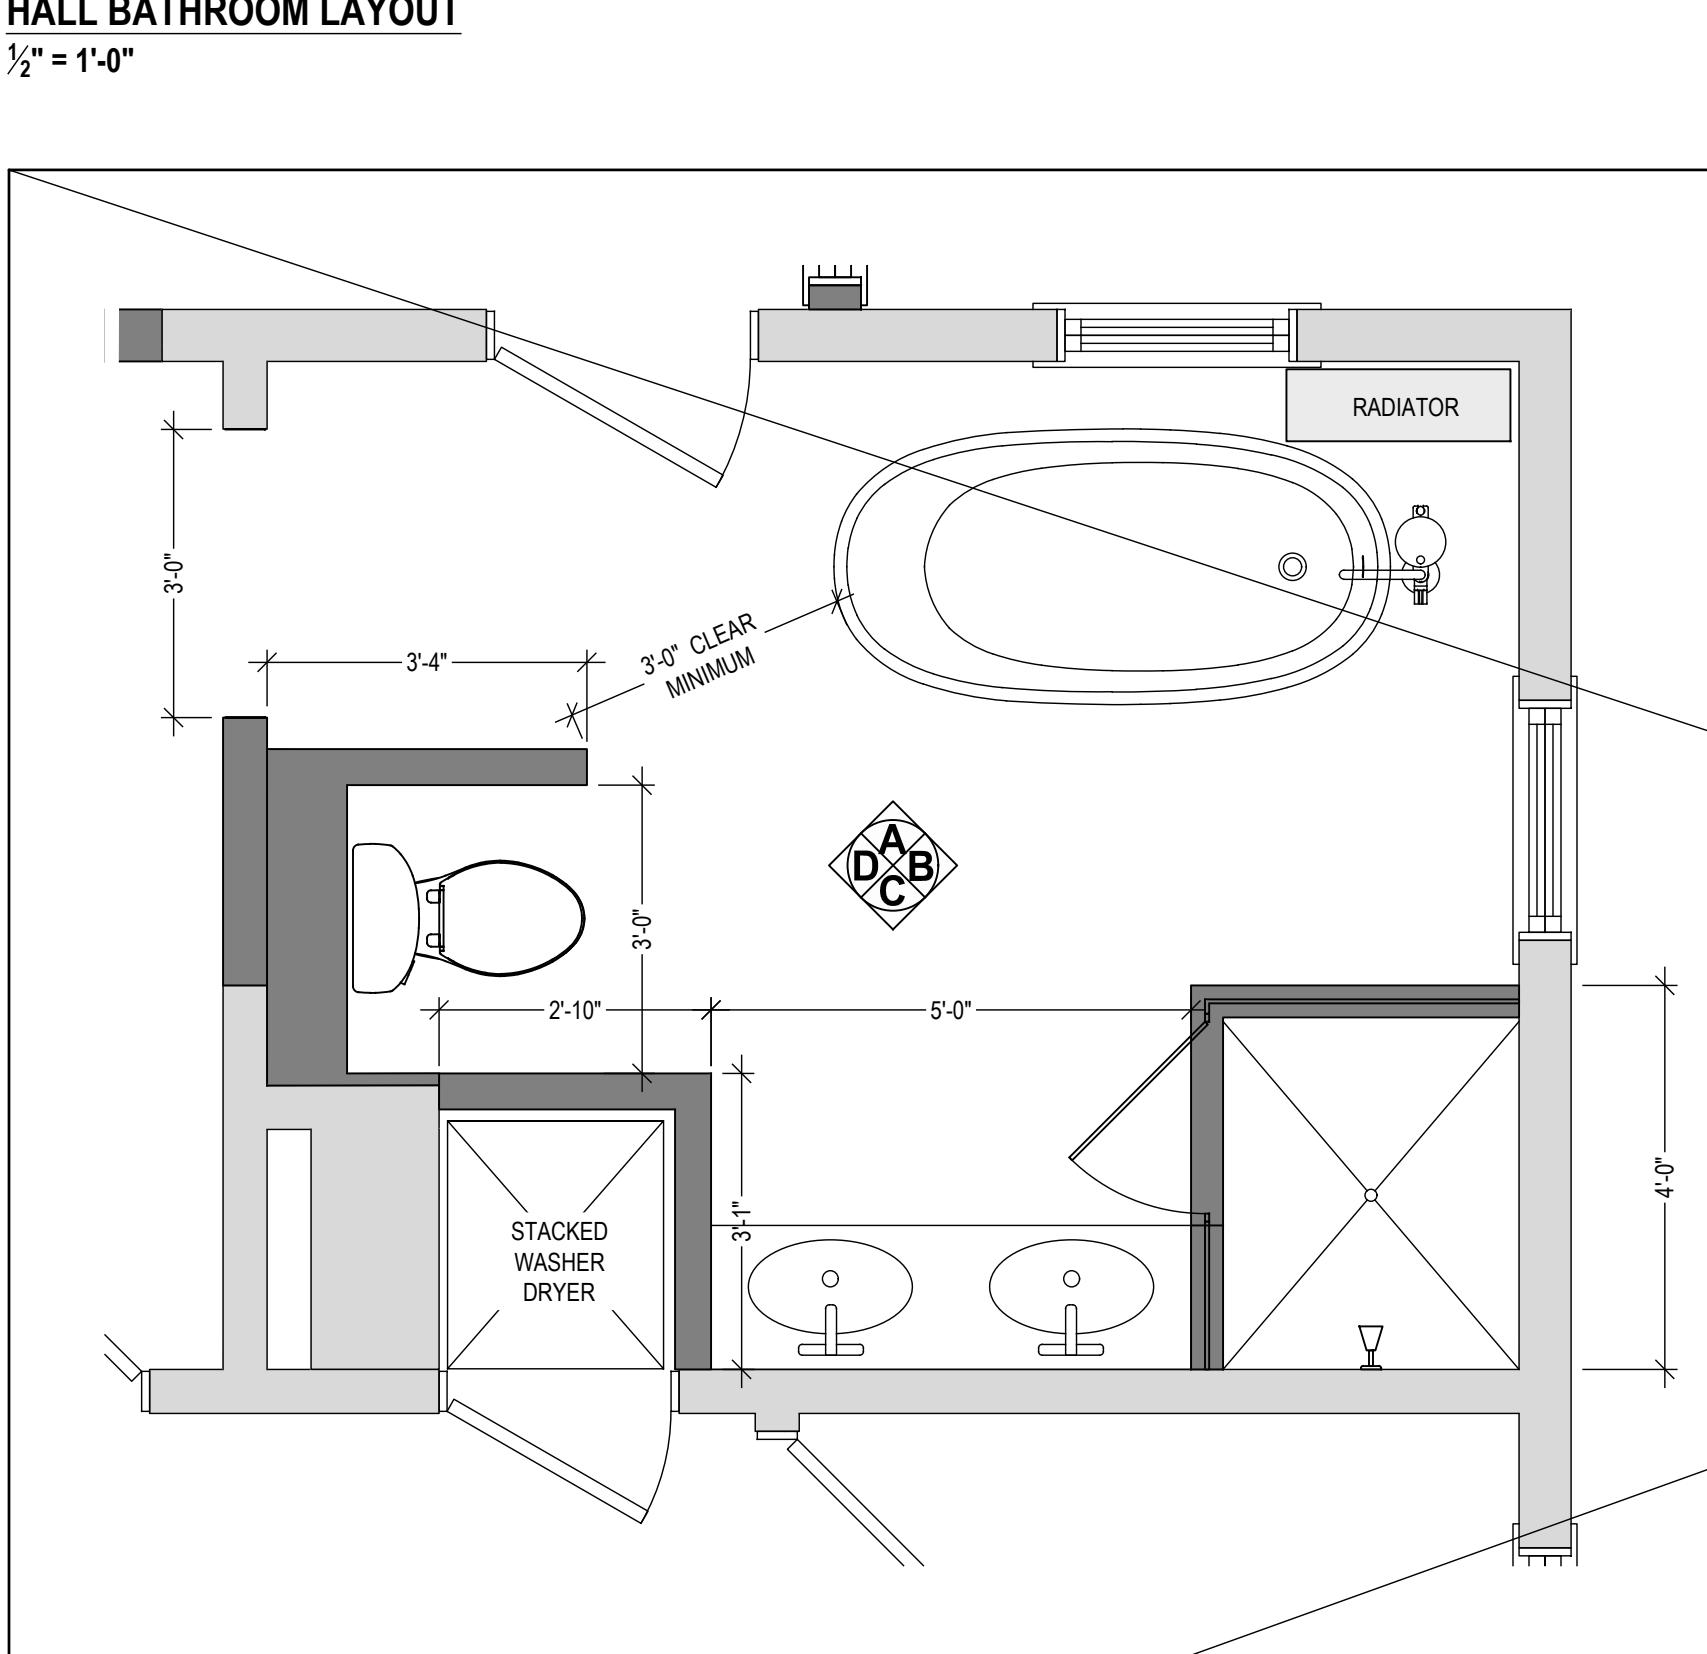
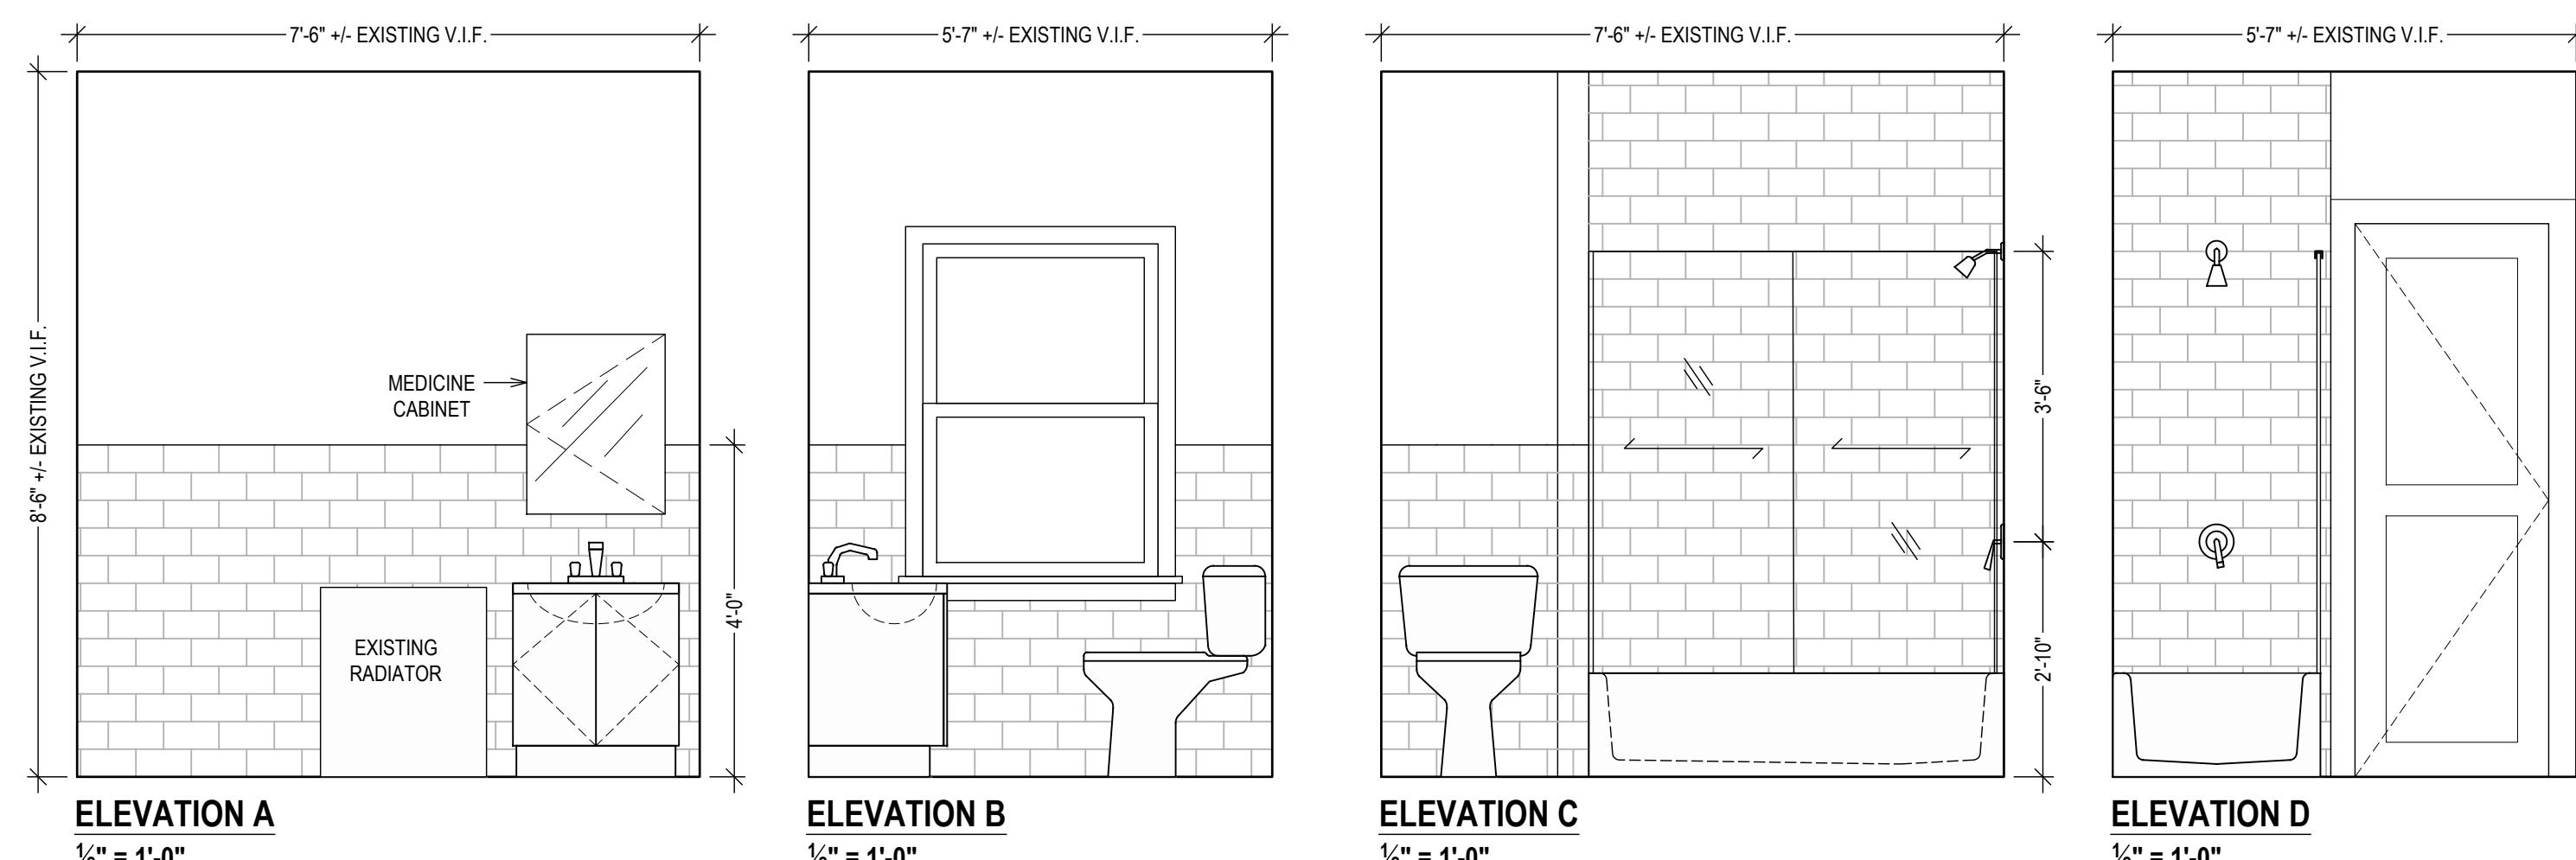
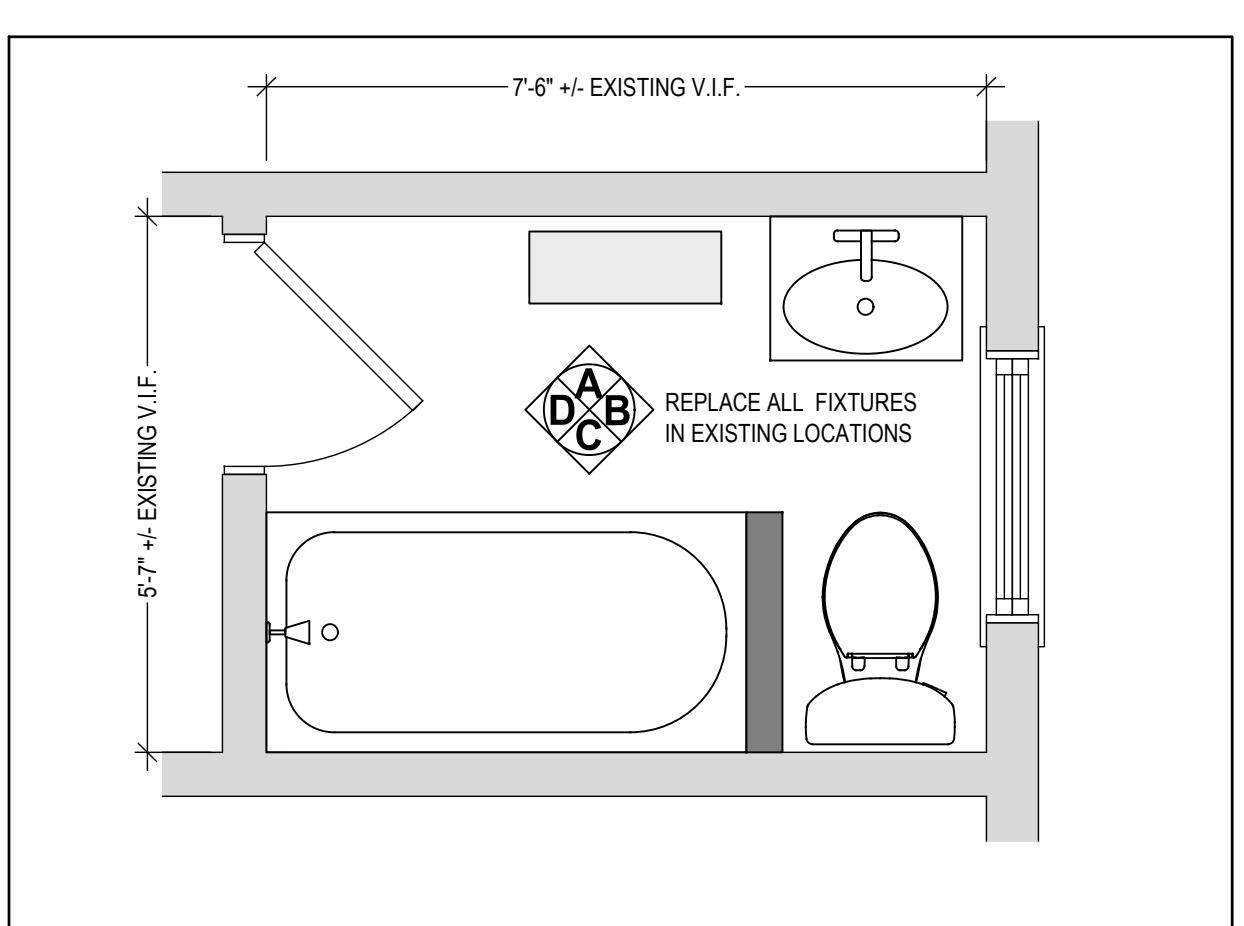
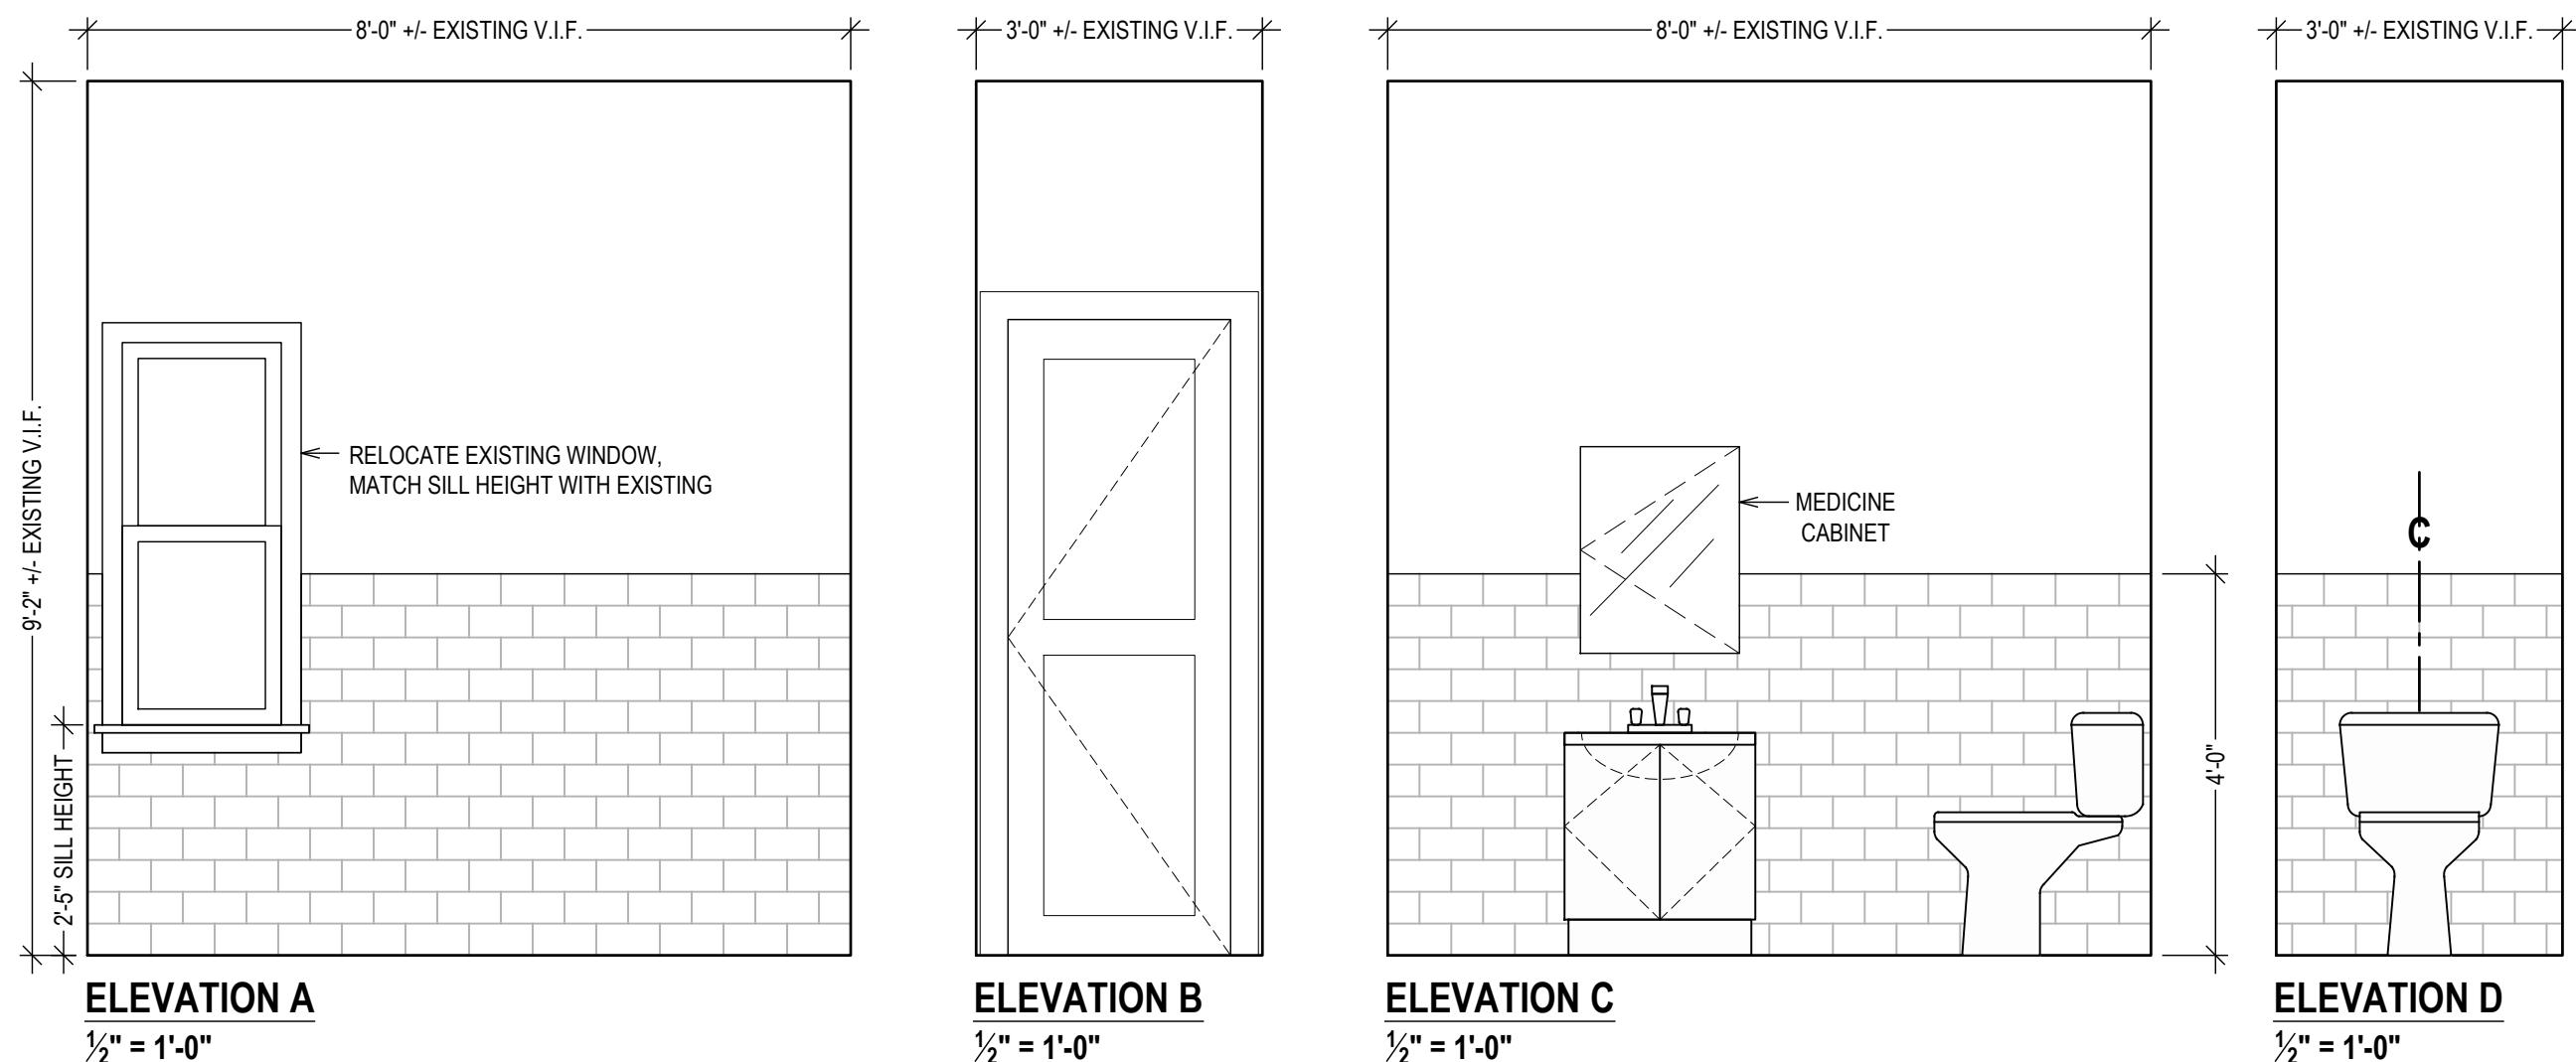
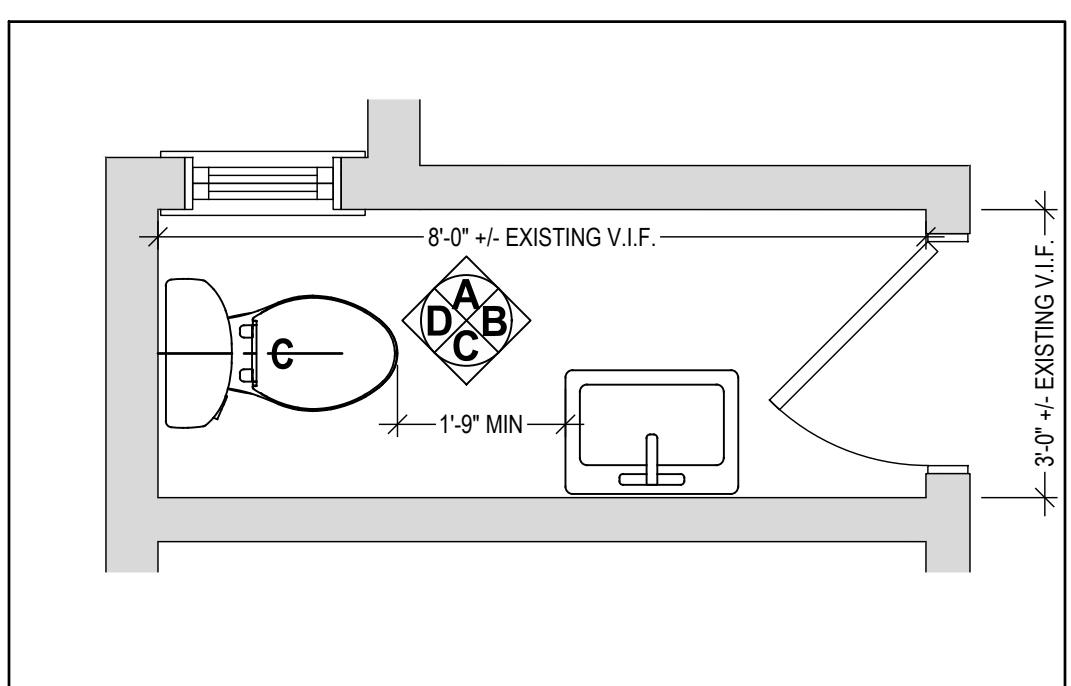
PROJECT NAME:
 FLOOR PLAN ALTERATION

DRAWING NAME:
 SECTIONS

DRAWING NUMBER:
 A-03.1


DATE:
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NOTE:
 -VERIFY ALL DIMENSIONS IN FIELD
 -SEE SHEET A-06.1 FOR BATHROOM CLEARANCES.
 -SEE SHEET A-06.2 FOR FINISHES.
 -SEE SHEET E-01 AND E-02 FOR ELECTRICAL PLAN.



KITCHEN LAYOUT
 VERIFY ALL DIMENSIONS IN FIELD
 SEE SHEET A-06.2 FOR FINISHES
 SEE SHEET E-01 FOR ELECTRICAL PLAN
 $1/2'' = 1'-0''$

PLUMBING:

1. ALL PLUMBING WORK IS TO BE:
 • PERFORMED BY A PLUMBER LICENSED TO WORK IN WESTCHESTER COUNTY AND IN THE VILLAGE OF PORT CHESTER.
- COMPLETED PART VII OF THE 2017 NATIONAL ELECTRICAL CODE (NFPA 70-2017).
- FILED UNDER A SEPARATE PERMIT.
- INSPECTED PER THE REQUIREMENTS OF THE BUILDING DEPARTMENT, AND BUILDING OFFICIAL, OF THE VILLAGE OF PORT CHESTER.
2. ALL ABANDONED PIPING MUST BE REMOVED TO A POINT OF CONCEALMENT AND PROPERLY CAPPED.
3. ALL EXPOSED EXISTING AND NEW HOT AND COLD WATER AND HEATING PIPES MUST BE PROPERLY INSULATED.
4. ALL MATERIALS USED SHALL BE NEW, BEST OF THEIR RESPECTIVE BRANDS AND CONFORM TO THE REQUIREMENTS OF ALL STATE AND LOCAL AUTHORITIES HAVING JURISDICTION.

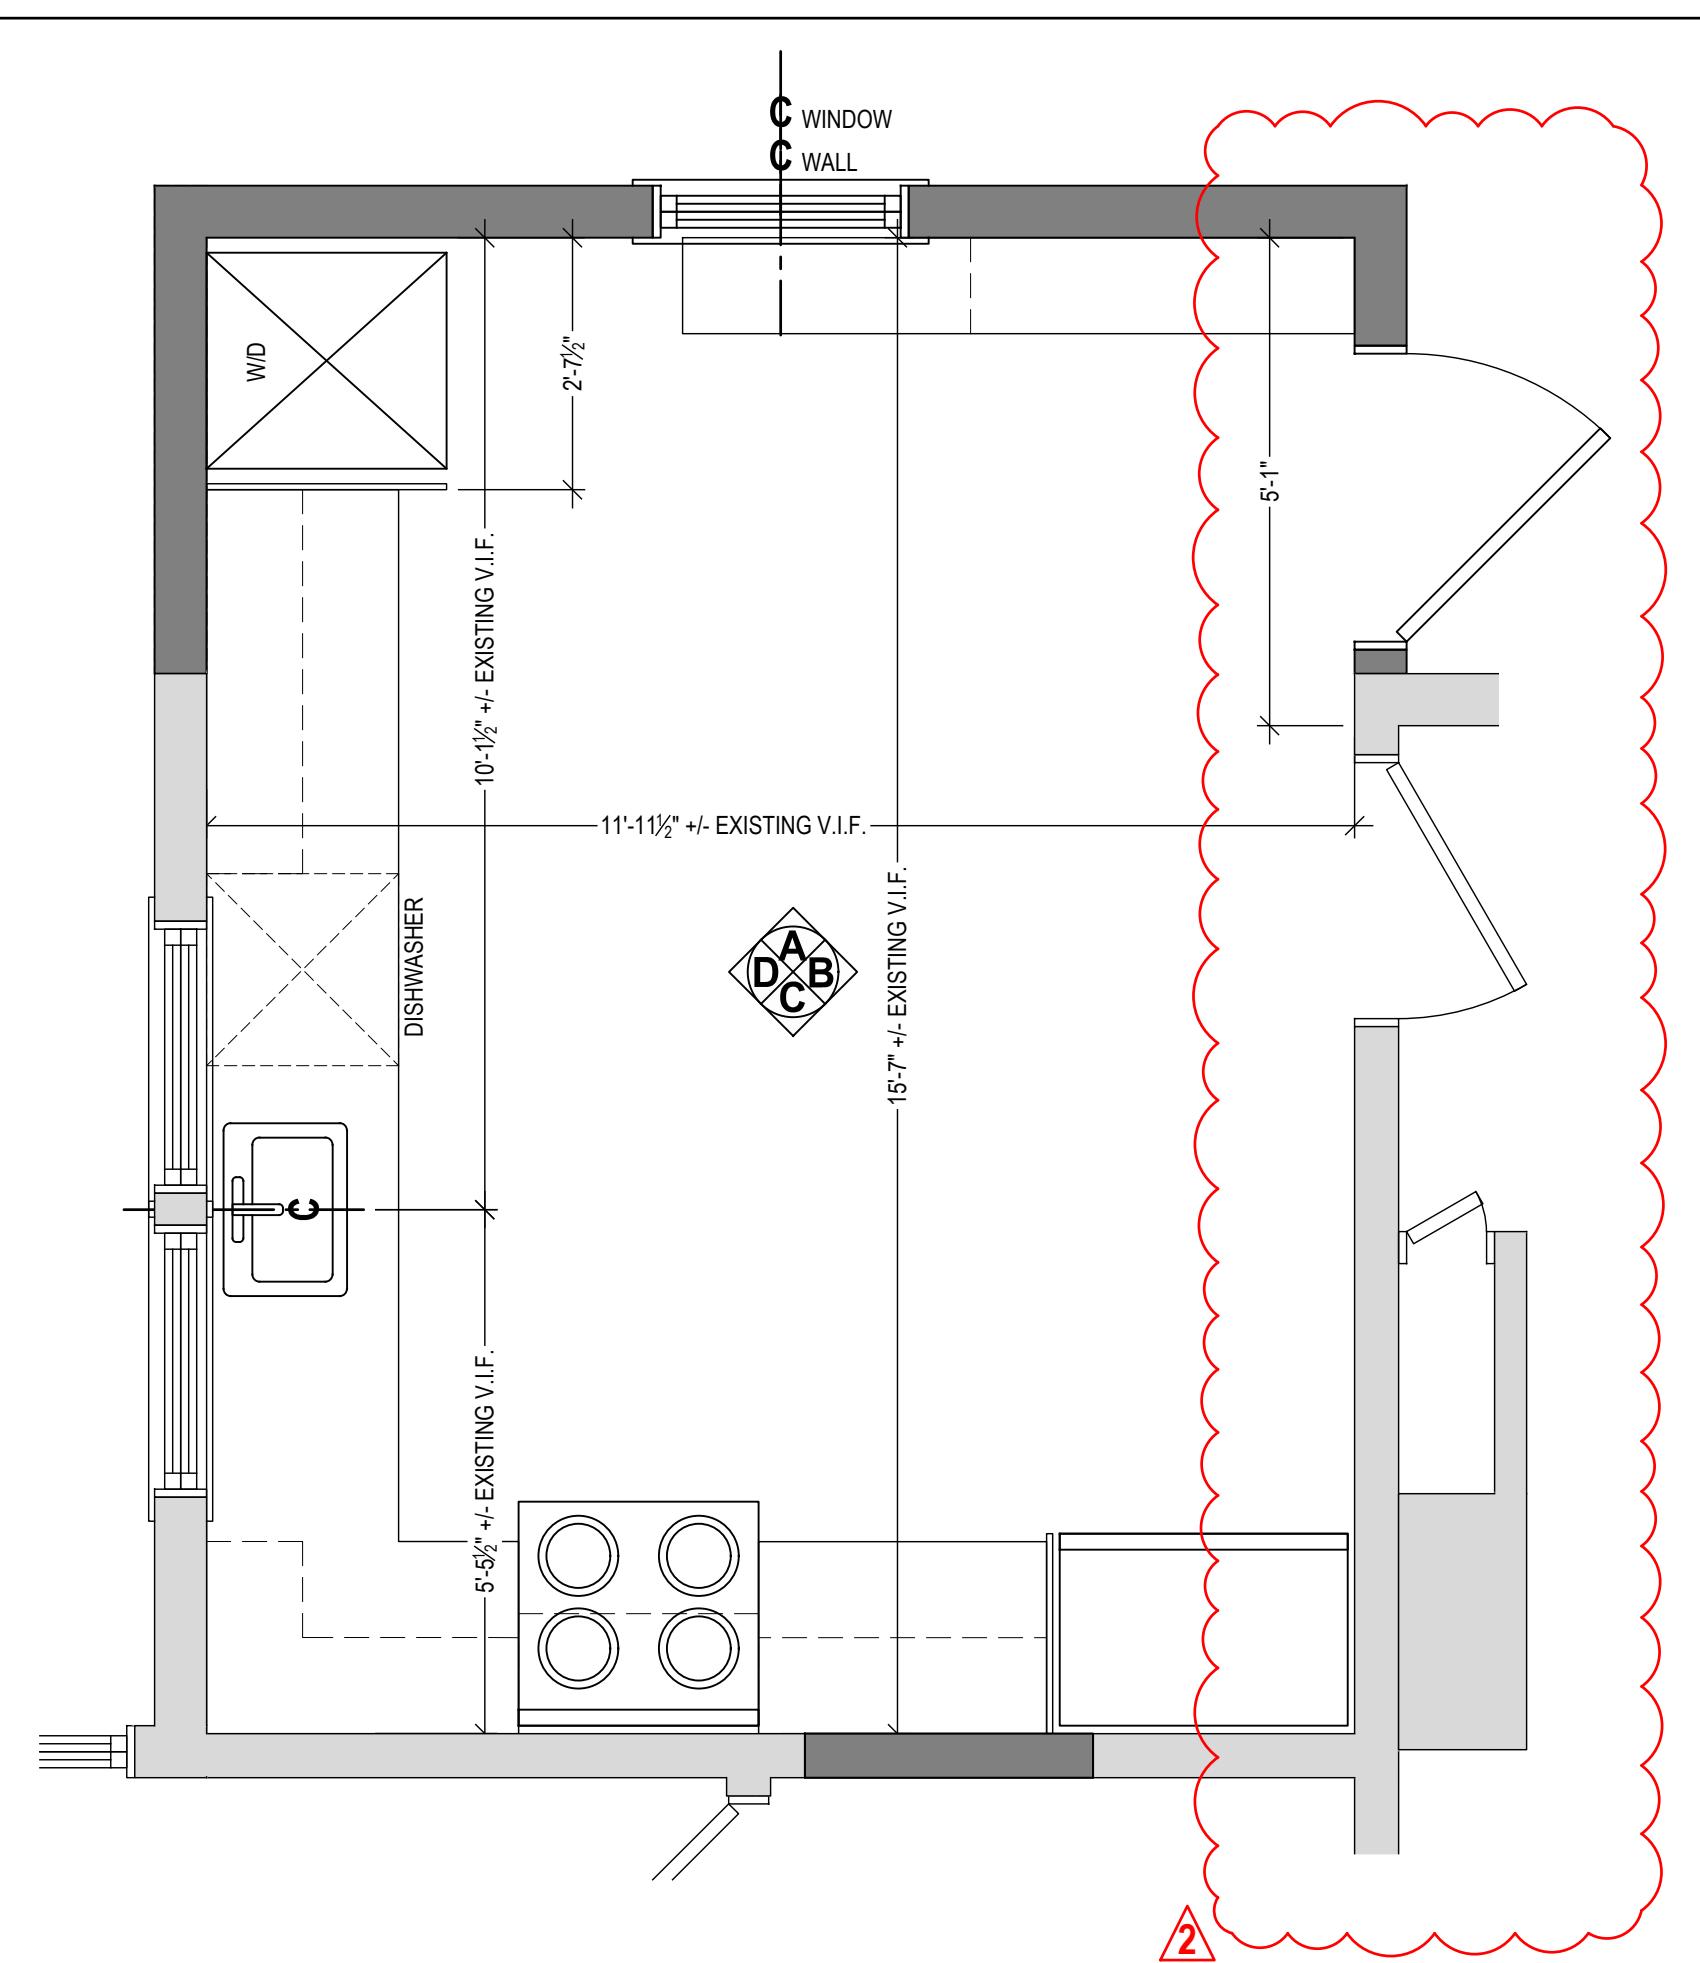ADDITIONS, ALTERATIONS OR REPAIRS
 ADDITIONS, ALTERATIONS, RENOVATIONS OR REPAIRS TO ANY PLUMBING SYSTEM SHALL CONFORM TO THAT REQUIRED FOR A NEW PLUMBING SYSTEM WITHOUT REQUIRING THE EXISTING PLUMBING SYSTEM TO COMPLY WITH THE REQUIREMENTS OF THIS CODE. ADDITIONS, ALTERATIONS OR REPAIRS SHALL NOT CAUSE AN EXISTING SYSTEM TO BECOME UNSAFE, UNSANITARY OR OVERLOADED. MINOR ADDITIONS, ALTERATIONS, RENOVATIONS AND REPAIRS TO EXISTING PLUMBING SYSTEMS SHALL BE PERMITTED IN THE SAME MANNER AND ARRANGEMENT AS IN THE EXISTING SYSTEM, PROVIDED THAT SUCH REPAIRS OR REPLACEMENT ARE NOT HAZARDOUS AND ARE APPROVED.

INSPECTION REQUIRED:
 NEW PLUMBING WORK AND PARTS OF EXISTING SYSTEMS AFFECTED BY NEW YORK OR ALTERATIONS SHALL BE INSPECTED BY THE BUILDING OFFICIAL TO ENSURE COMPLIANCE WITH THE REQUIREMENTS OF THE CODE.

A PLUMBER OR DRAINAGE SYSTEM, OR PART THEREOF, SHALL NOT BE COVERED, CONCEALED OR PUT INTO USE UNTIL IT HAS BEEN TESTED, INSPECTED AND APPROVED BY THE BUILDING OFFICIAL. WASTE AND VENT SYSTEMS TESTING



ROUGH-IN AND FINISHED PLUMBING INSTALLATIONS OF DRAIN, WASTE AND VENT SYSTEMS SHALL BE TESTED IN ACCORDANCE WITH SECTIONS P2503.5.1 AND P2503.5.2/P2503.5.

DRILLING AND NOTCHING:
 WOOD-FRAMED STRUCTURAL MEMBERS SHALL NOT BE DRILLED, NOTCHED OR ALTERED IN ANY MANNER EXCEPT AS PROVIDED IN SECTIONS R502.8, R602.6, R802.7 AND R802.7.1.


DWV TESTING:
 DWV SYSTEMS SHALL BE TESTED ON COMPLETION OF THE ROUGH PIPING INSTALLATION BY WATER OR, FOR PIPING SYSTEMS OTHER THAN PLASTIC, BY AIR, WITHOUT EVIDENCE OF LEAKAGE. EITHER TEST SHALL BE APPLIED TO THE DRAINAGE SYSTEM IN ITS ENTIRETY OR IN SECTIONS AFTER ROUGH-IN PIPING HAS BEEN INSTALLED, AS FOLLOWS:

1. WATER TEST:
 EACH SECTION SHALL BE FILLED WITH WATER TO A POINT NOT LESS THAN 5'-0" ABOVE THE HIGHEST FITTING CONNECTION IN THAT SECTION, OR TO THE HIGHEST POINT IN THE COMPLETED SYSTEM. WATER SHALL BE HELD IN THE SECTION UNDER TEST FOR A PERIOD OF 15 MINUTES. THE SYSTEM SHALL PROVE LEAK FREE BY VISUAL INSPECTION.


2. AIR TEST:
 THE PORTION UNDER TEST SHALL BE MAINTAINED AT A GAUGE PRESSURE OF 5 POUNDS PER SQUARE INCH (PSI) OR 10' OF MERCURY COLUMN. THIS PRESSURE SHALL BE HELD WITHOUT INTRODUCTION OF ADDITIONAL AIR FOR A PERIOD OF 15 MINUTES.

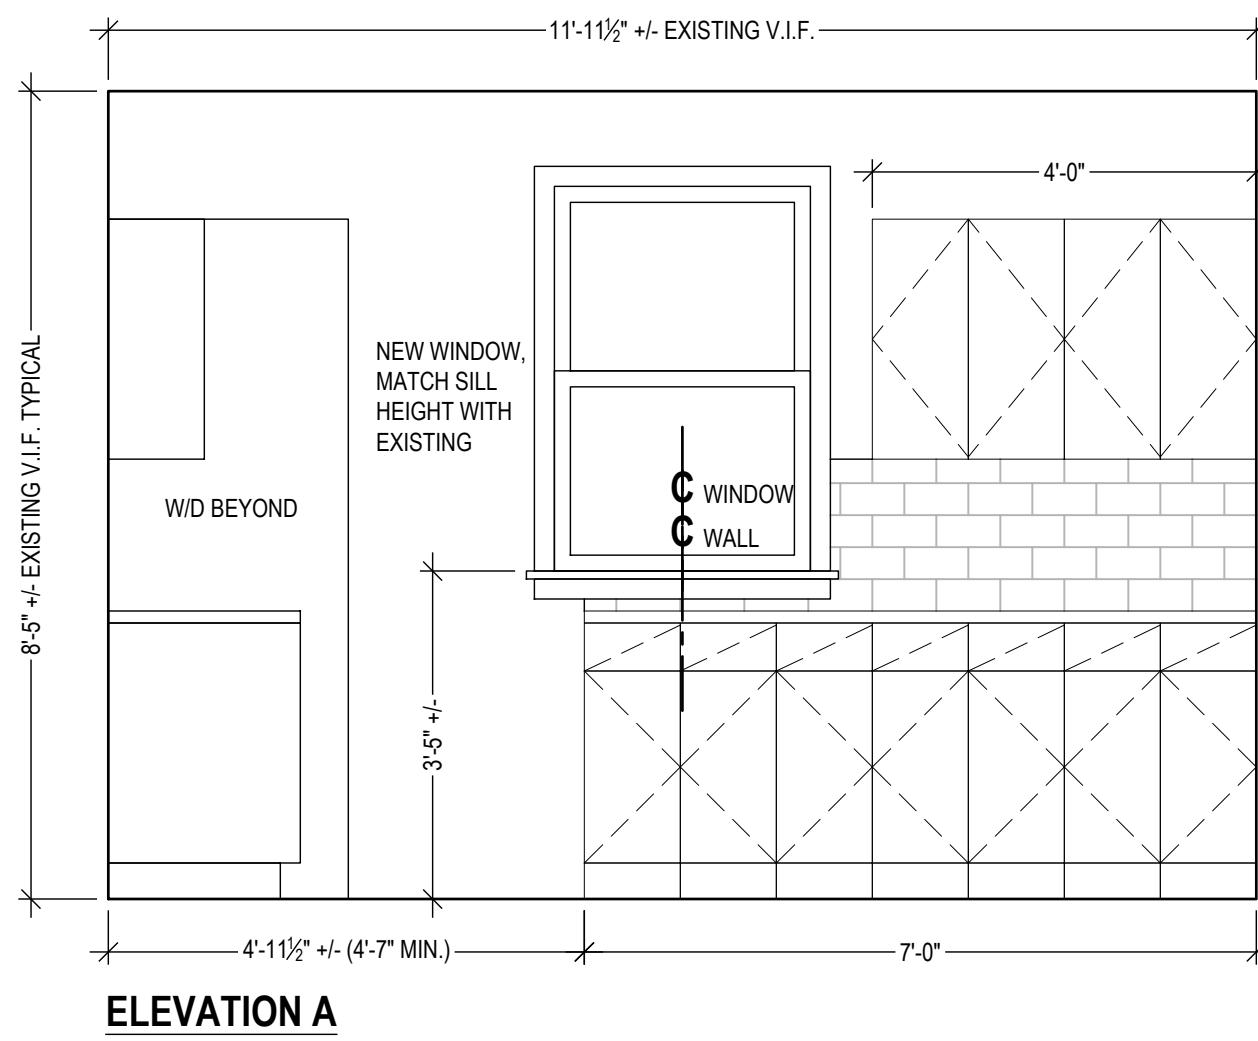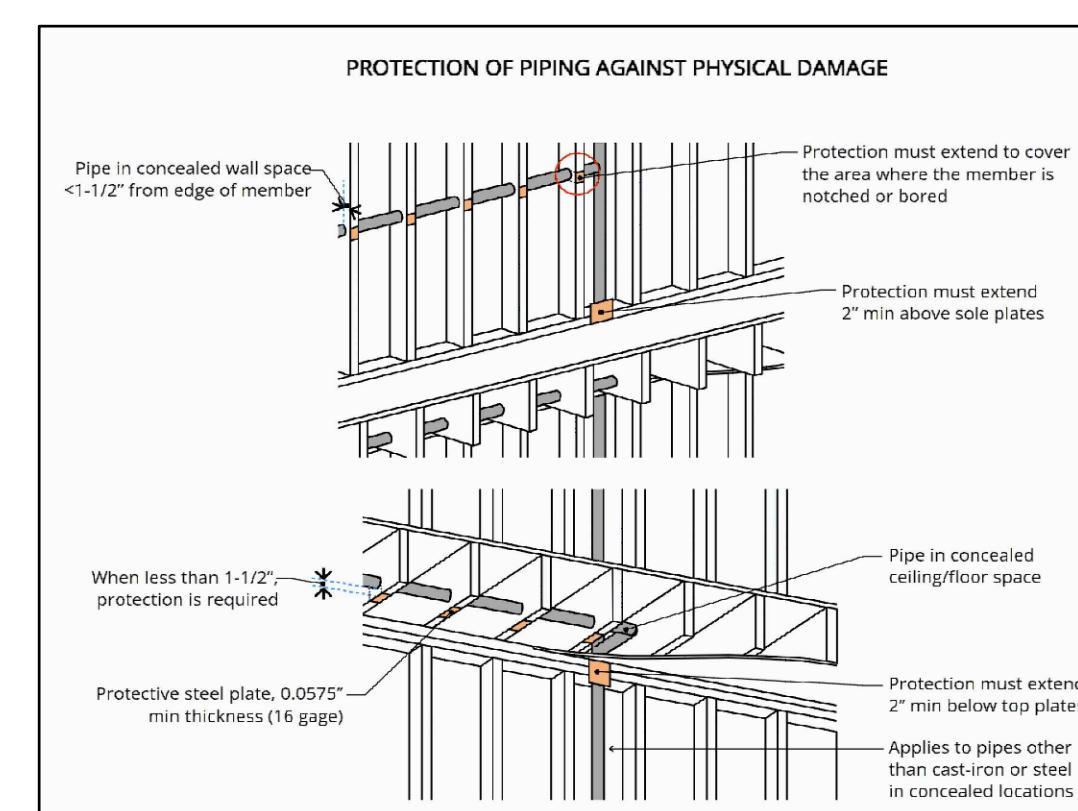


ELEVATION A
 $1/2'' = 1'-0''$

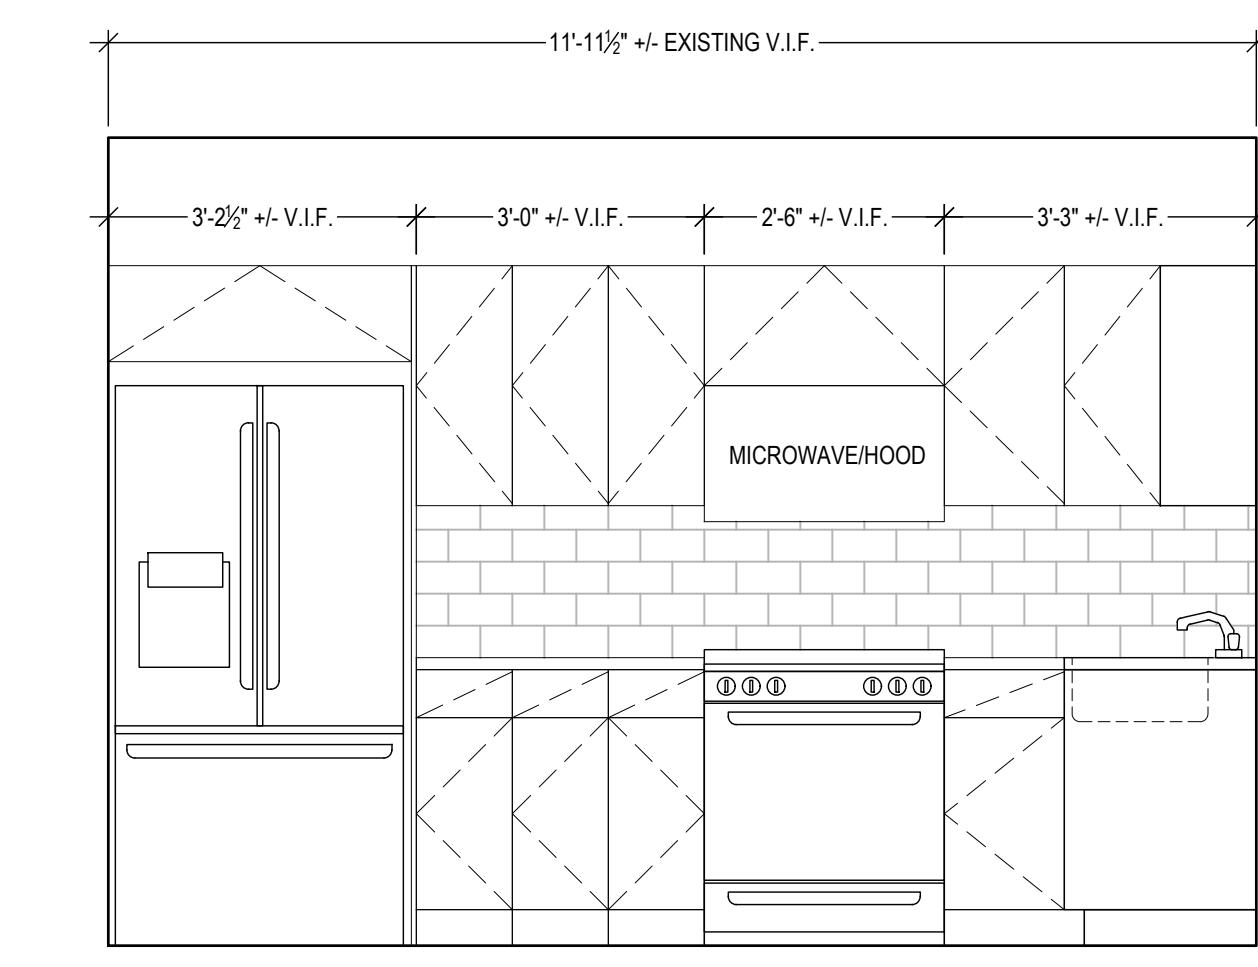

ELEVATION C
 $1/2'' = 1'-0''$

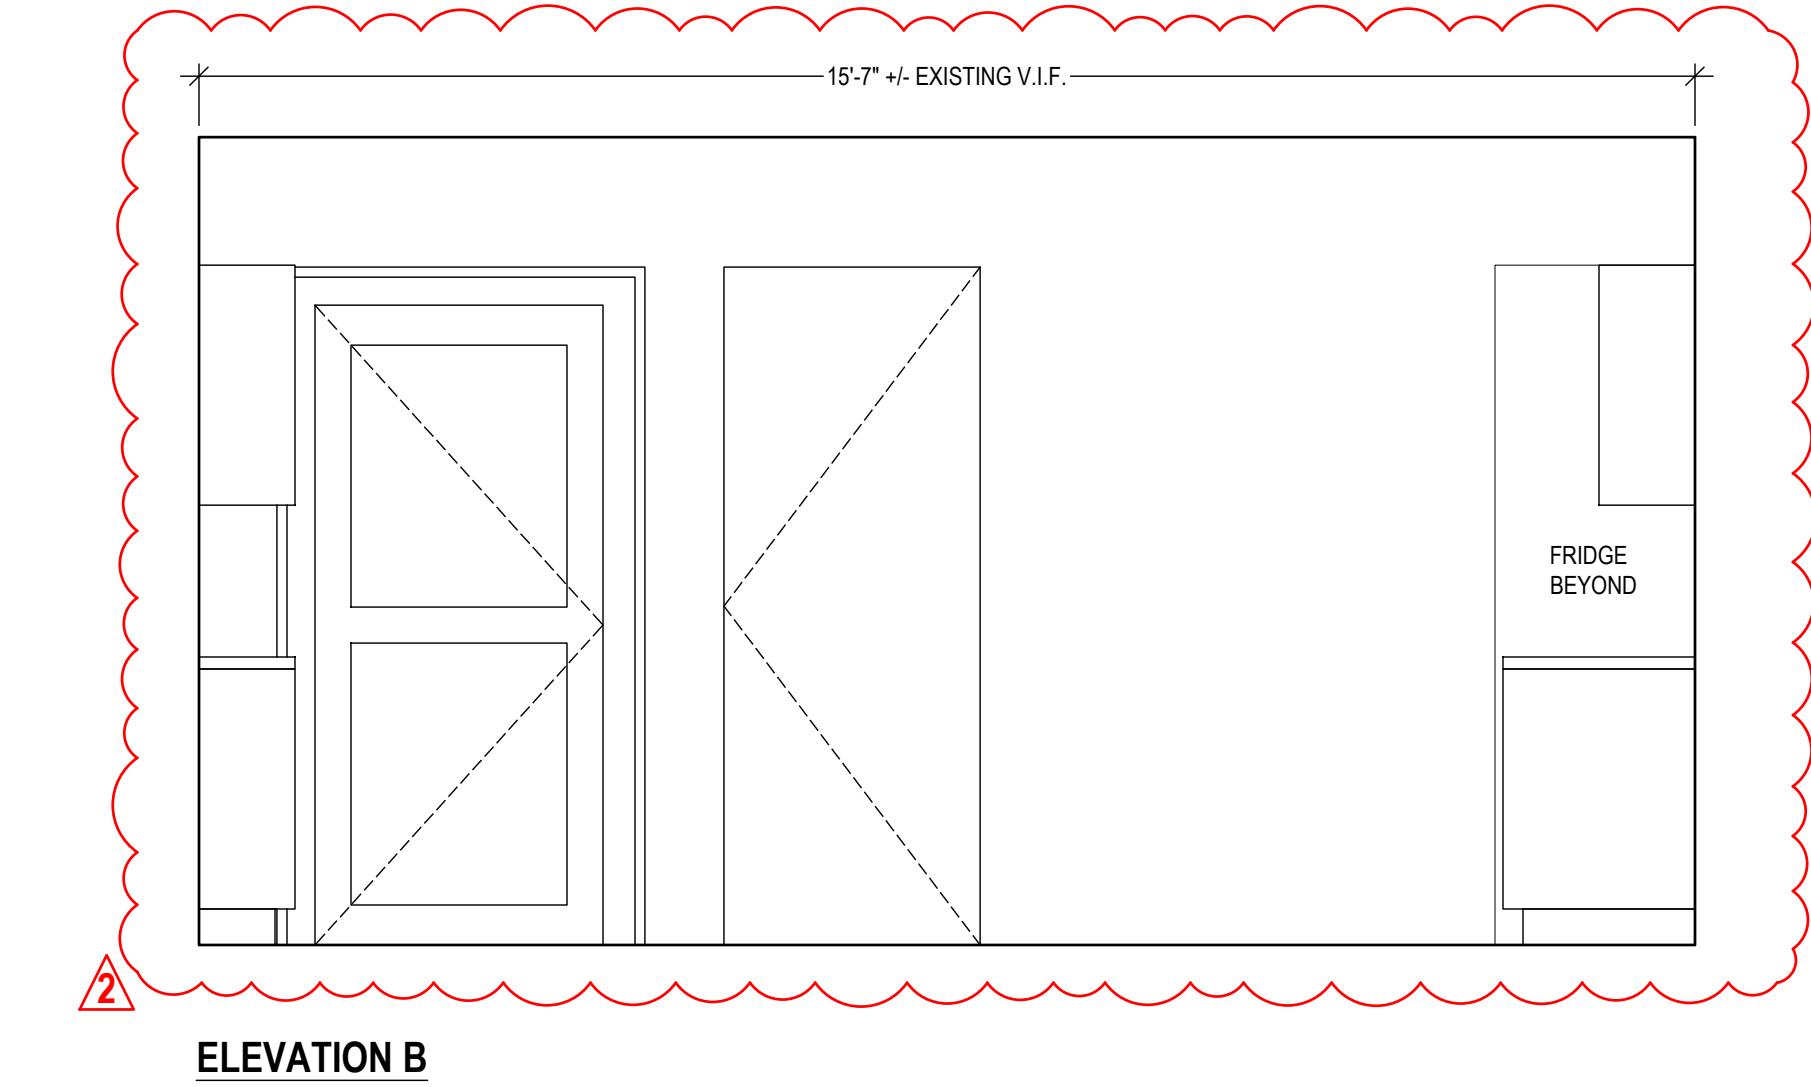

ELEVATION B
 $1/2'' = 1'-0''$

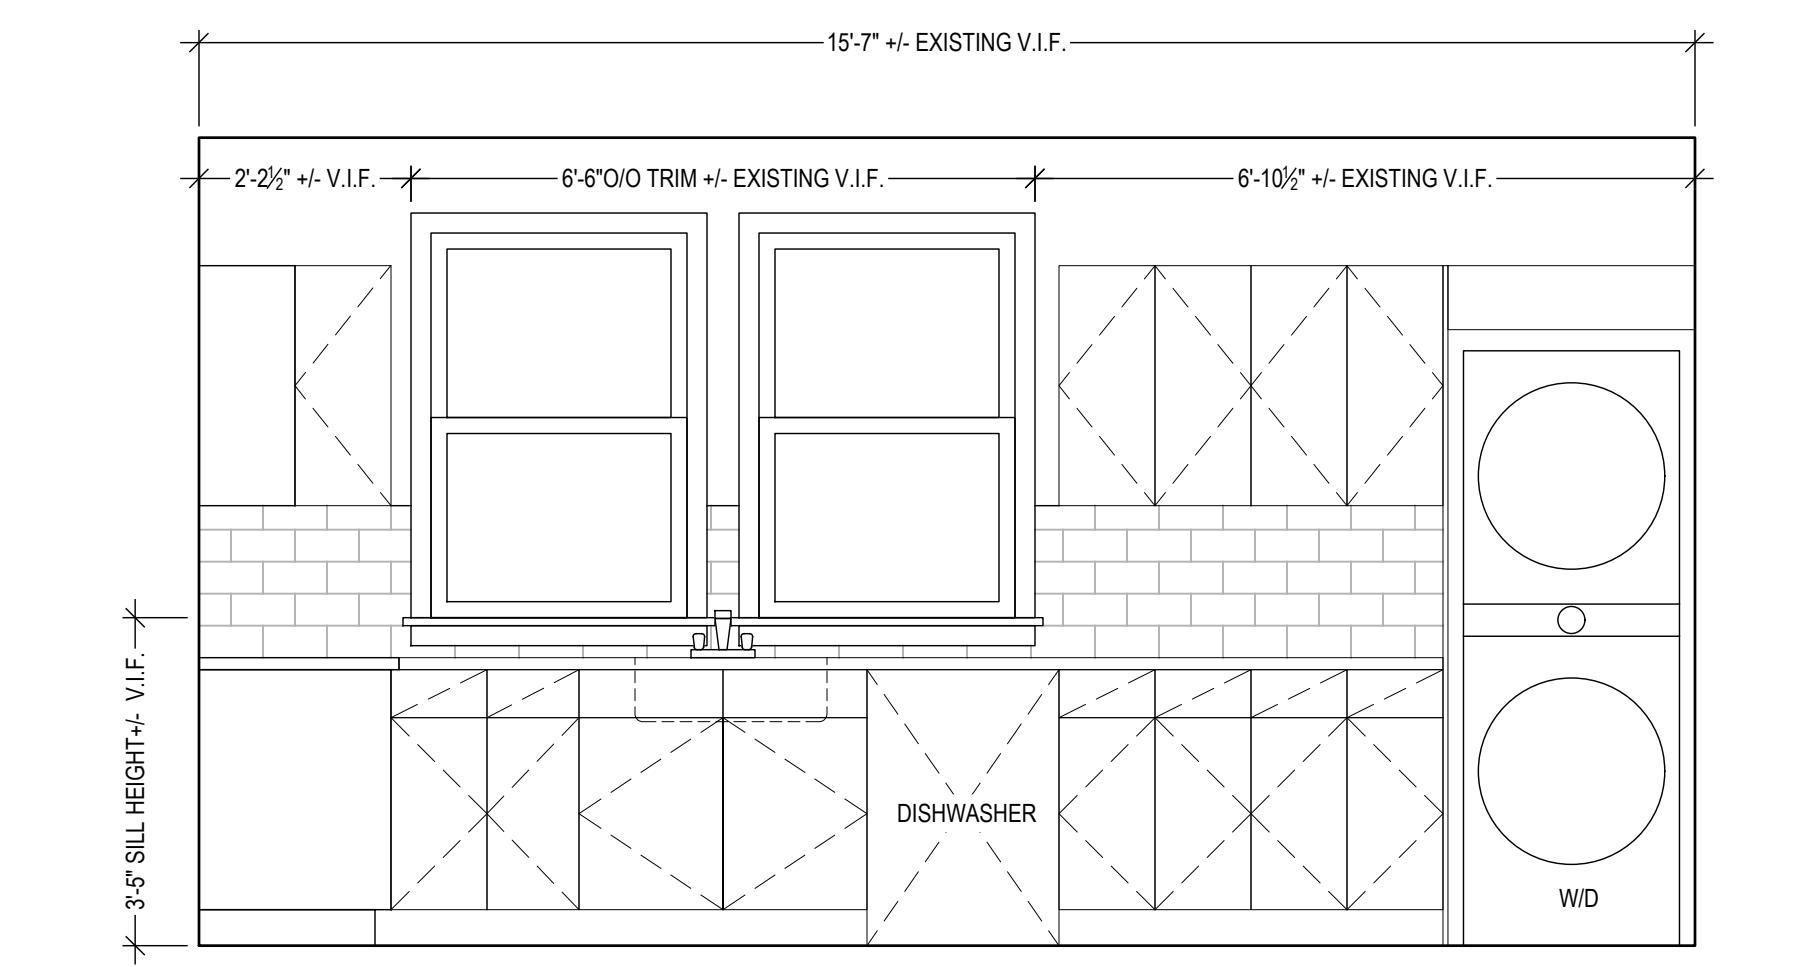


ELEVATION D
 $1/2'' = 1'-0''$

M1503.6.1 LOCATION
 KITCHEN EXHAUST MAKEUP AIR SHALL BE DISCHARGED INTO THE SAME ROOM IN WHICH THE EXHAUST SYSTEM IS LOCATED OR INTO ROOMS OR DUCT SYSTEMS THAT COMMUNICATE THROUGH ONE OR MORE PERMANENT OPENINGS WITH THE ROOM IN WHICH SUCH EXHAUST SYSTEM IS LOCATED. SUCH PERMANENT OPENINGS SHALL HAVE A NET CROSS-SECTIONAL AREA NOT LESS THAN THE REQUIRED AREA OF THE MAKEUP AIR SUPPLY OPENINGS.

M1503.6.2 MAKEUP AIR DAMPERS
 WHERE MAKEUP AIR IS REQUIRED BY SECTION M1503.6, MAKEUP AIR DAMPERS SHALL COMPLY WITH THIS SECTION. EACH DAMPER SHALL BE A GRAVITY DAMPER OR AN ELECTRICALLY OPERATED DAMPER THAT AUTOMATICALLY OPENS WHEN THE EXHAUST SYSTEM OPERATES. DAMPERS SHALL BE LOCATED TO ALLOW ACCESS FOR INSPECTION, SERVICE, REPAIR AND REPLACEMENT WITHOUT REMOVING PERMANENT CONSTRUCTION OR ANY OTHER DUCTS NOT CONNECTED TO THE DAMPER BEING INSPECTED, SERVICED, REPAIRED OR REPLACED. GRAVITY OR BAROMETRIC DAMPERS SHALL NOT BE USED IN PASSIVE MAKEUP AIR SYSTEMS EXCEPT WHERE THE DAMPERS ARE RATED TO PROVIDE THE DESIGN MAKEUP AIRFLOW AT A PRESSURE DIFFERENTIAL OF 0.01 IN. W.C. (3 PA) OR LESS.

M1504.3 EXHAUST OPENINGS
 AIR EXHAUST OPENINGS SHALL TERMINATE AS FOLLOWS:
 NOT LESS THAN 3 FEET (914 MM) FROM PROPERTY LINES;
 NOT LESS THAN 3 FEET (914 MM) FROM GRAVITY AIR INTAKE OPENINGS, EXHAUST OPENINGS AND OPERABLE OPENINGS;
 NOT LESS THAN 10 FEET (3048 MM) FROM MECHANICAL AIR INTAKE OPENINGS, EXCEPT WHERE THE EXHAUST OPENING IS LOCATED NOT LESS THAN 3 FEET (14 MM) ABOVE THE AIR INTAKE OPENING. EXHAUST OPENINGS SHALL COMPLY WITH SECTION P35.2 A, E, F, G, H, I, J, K, L, M, N, O, P, Q, R, S, T, U, V, W, X, Y, Z.

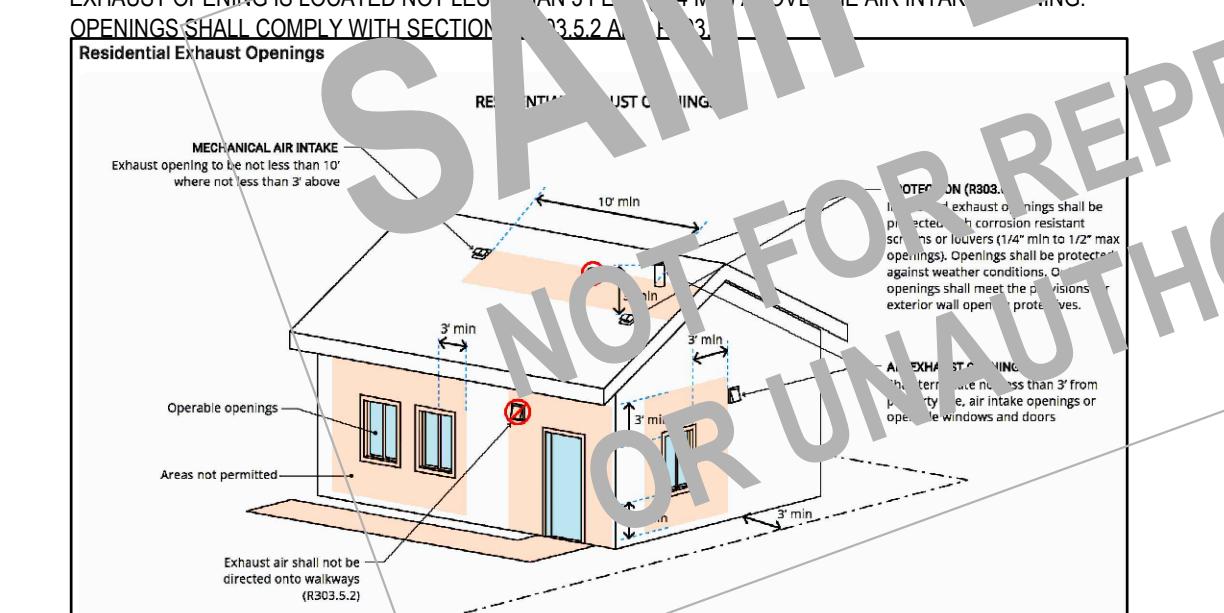

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PROJECT NAME:
 FLOOR PLAN ALTERATION

DRAWING NAME:
 KITCHEN

DRAWING NUMBER:
 A-04.1.2

DATE: 05.15.2025
SCALE: AS NOTED




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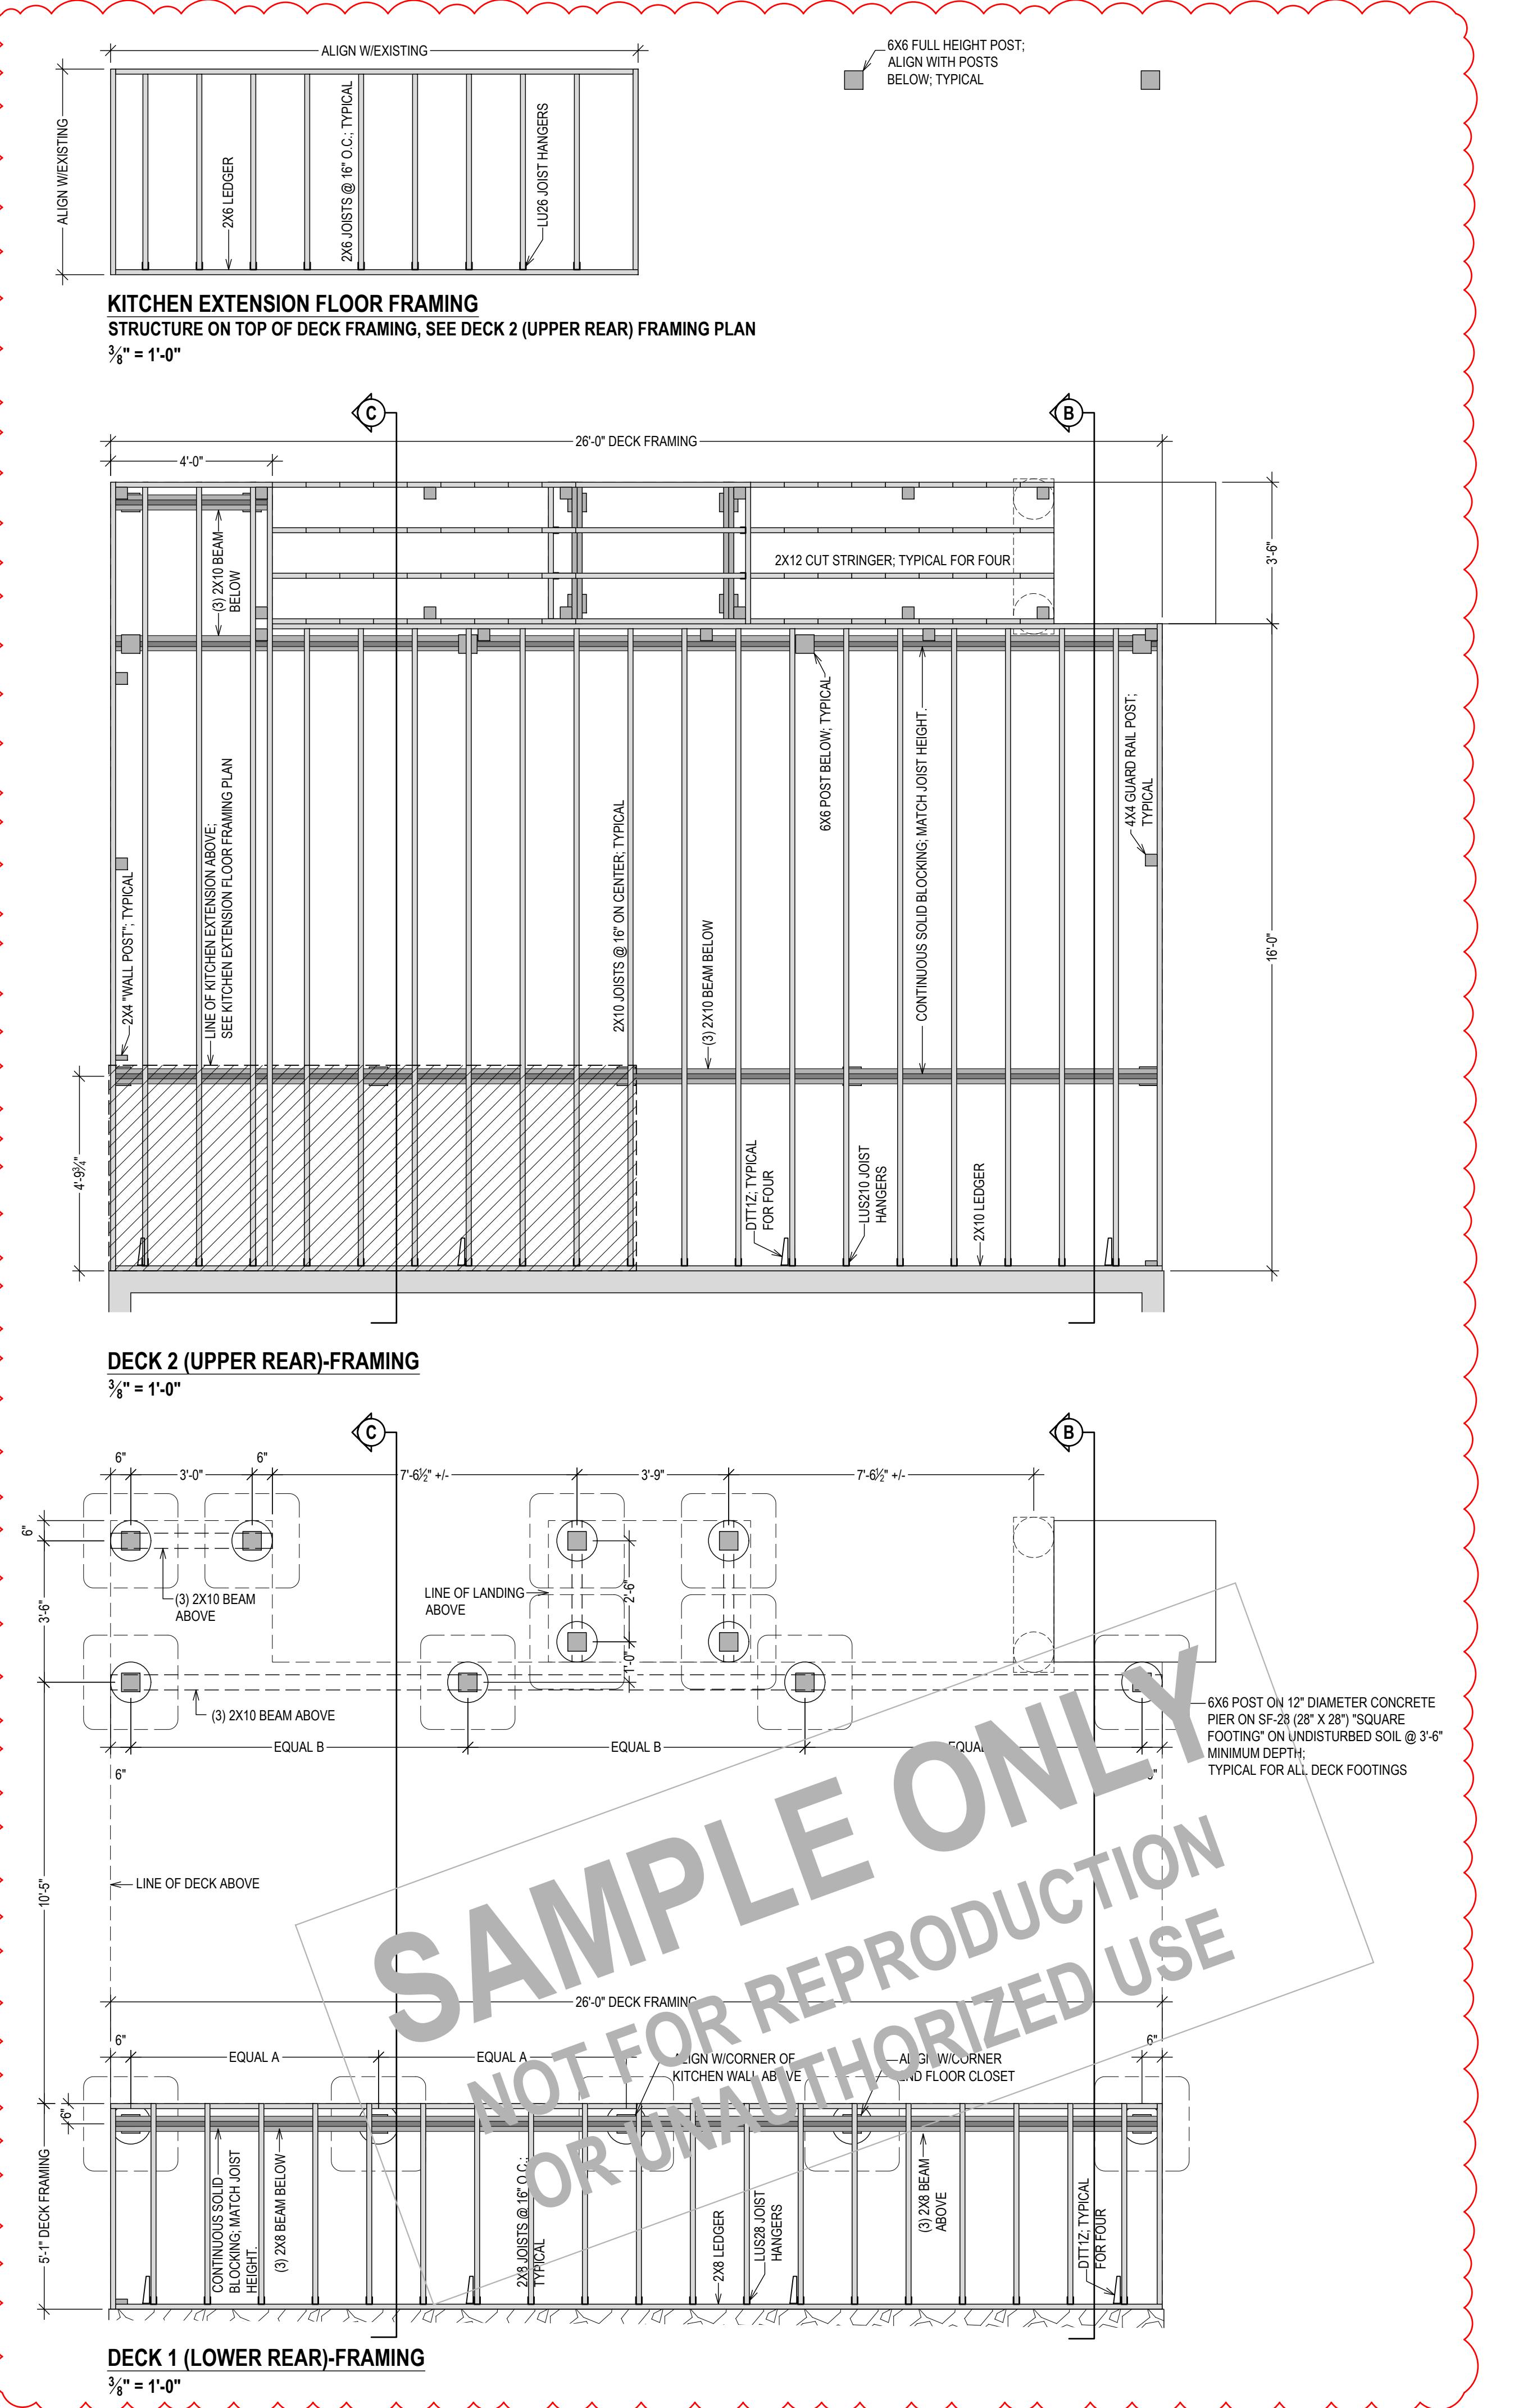
DECKING:
 $\frac{5}{4}$ " X 6" PRESSURE TREATED










POSTS: PRESSURE TREATED 4X4; 6'-0" CENTER TO CENTER
RAILS: WOOD AND ALUMINUM RAIL KIT




VERIFY ALL DIMENSIONS FOR ALIGNMENT OF FOOTINGS, PIERS AND POSTS

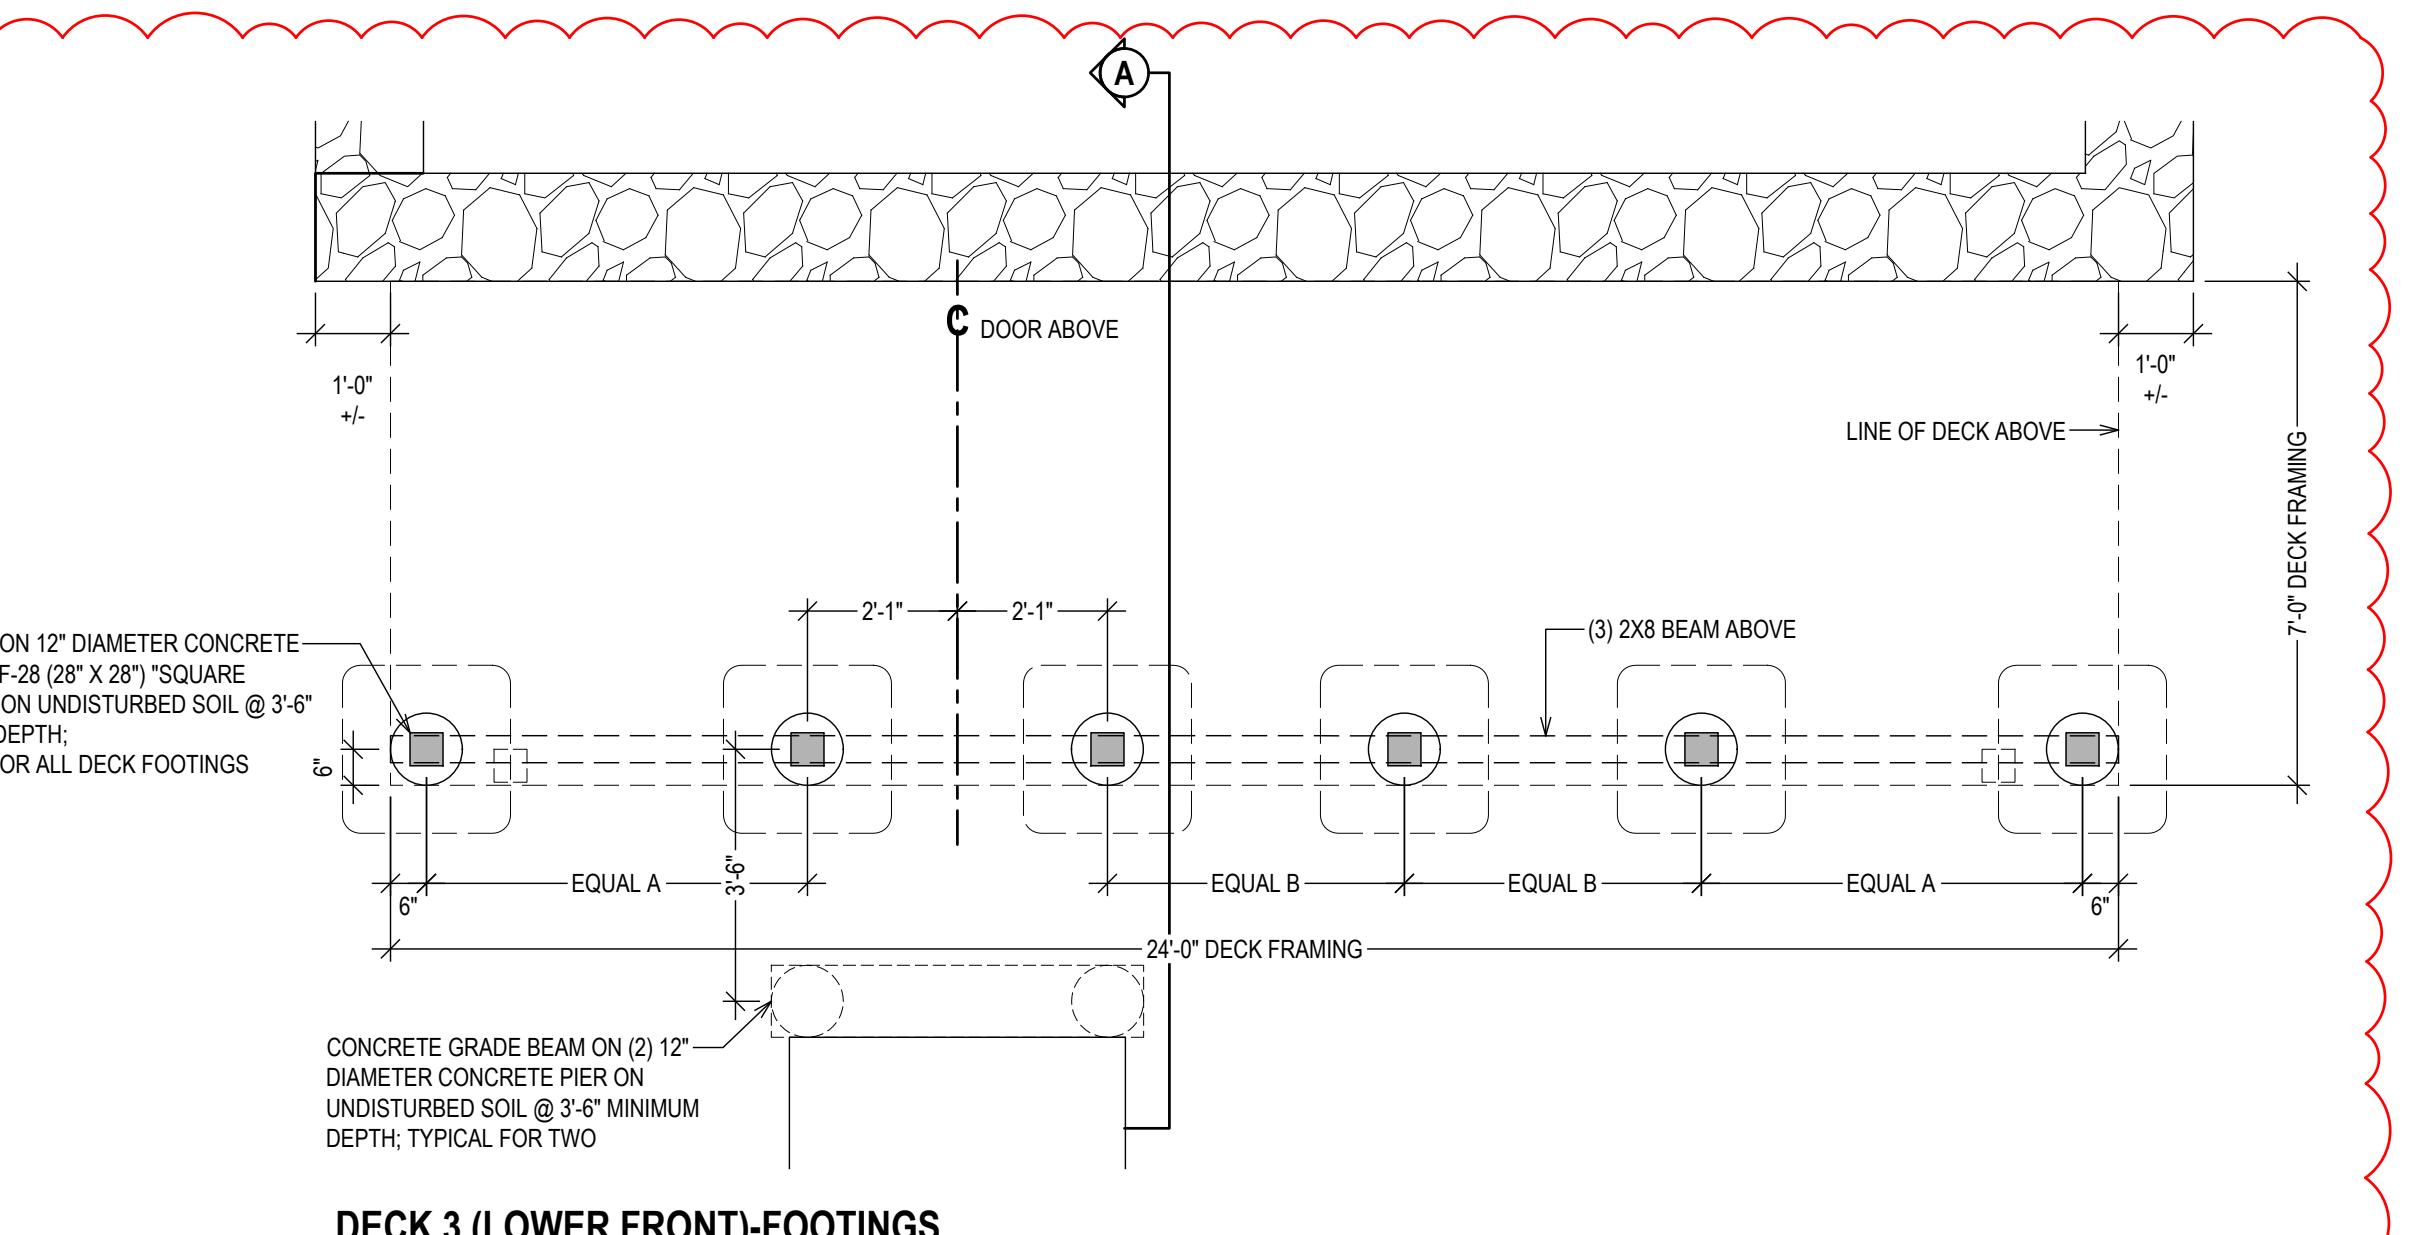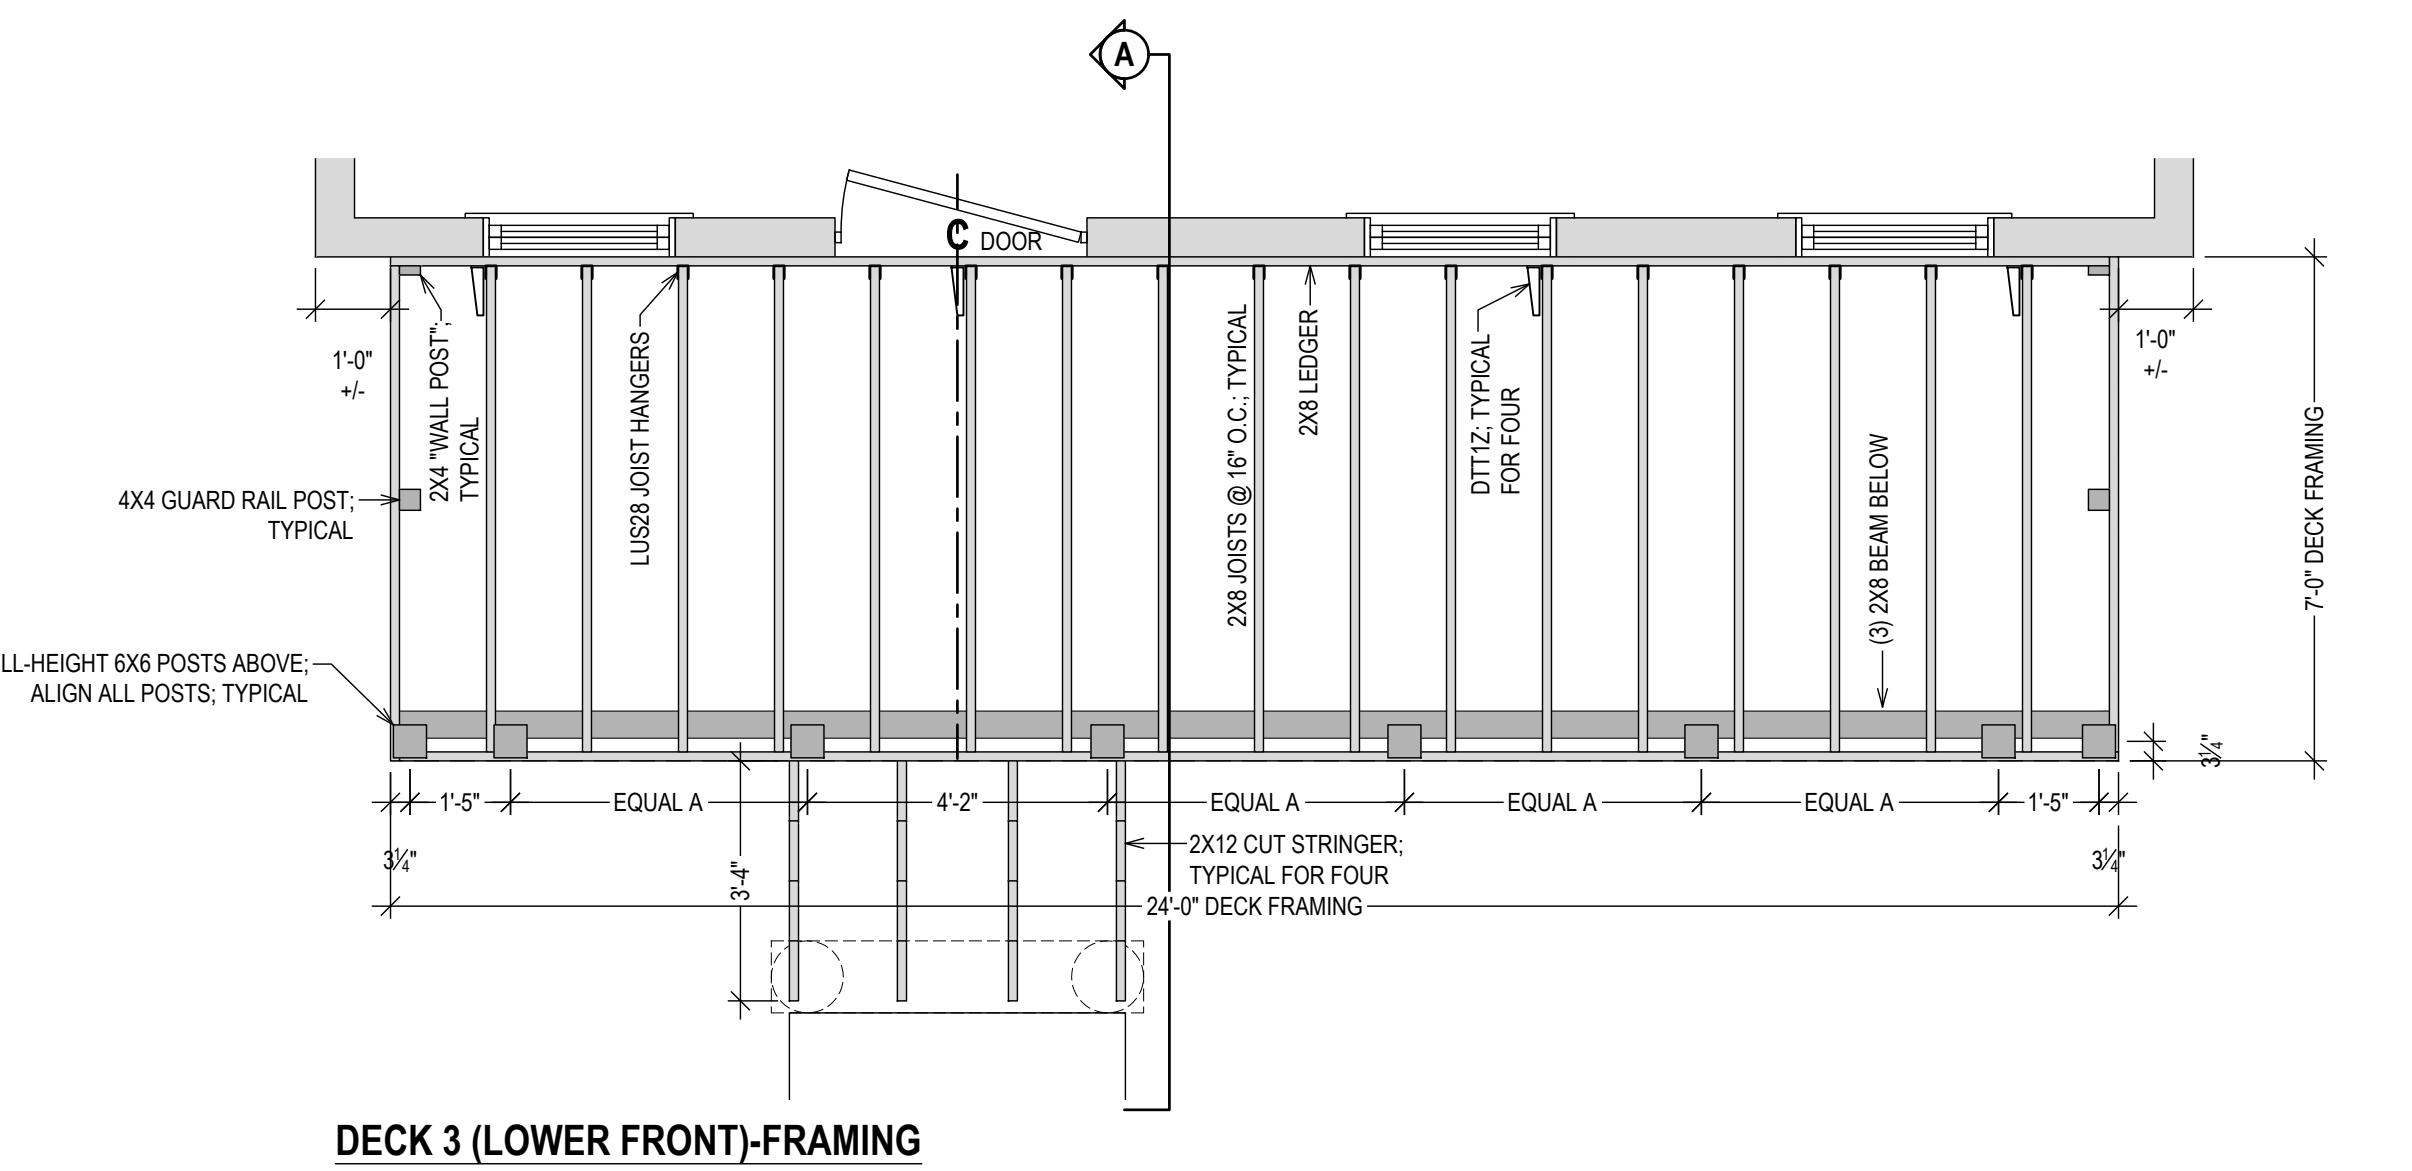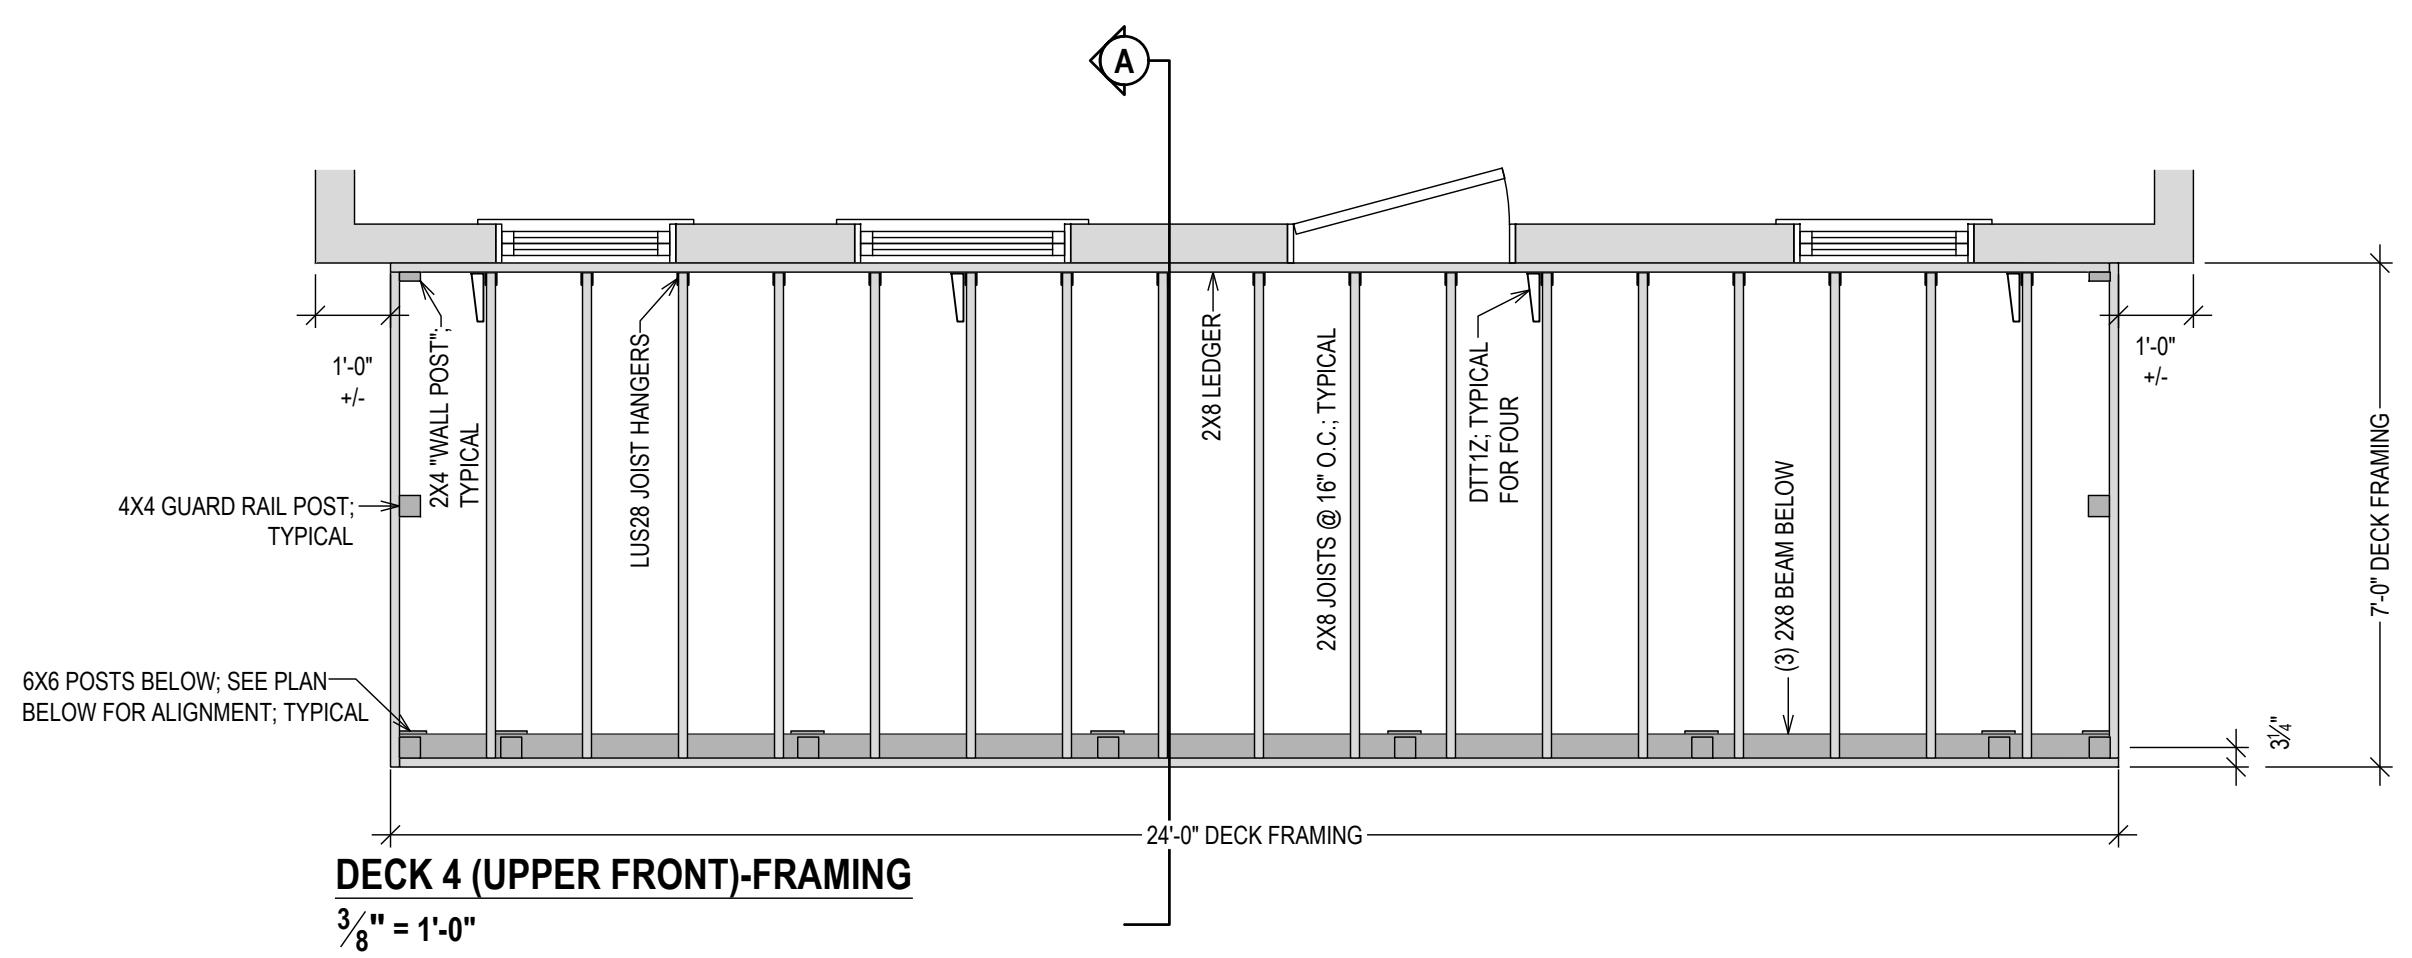

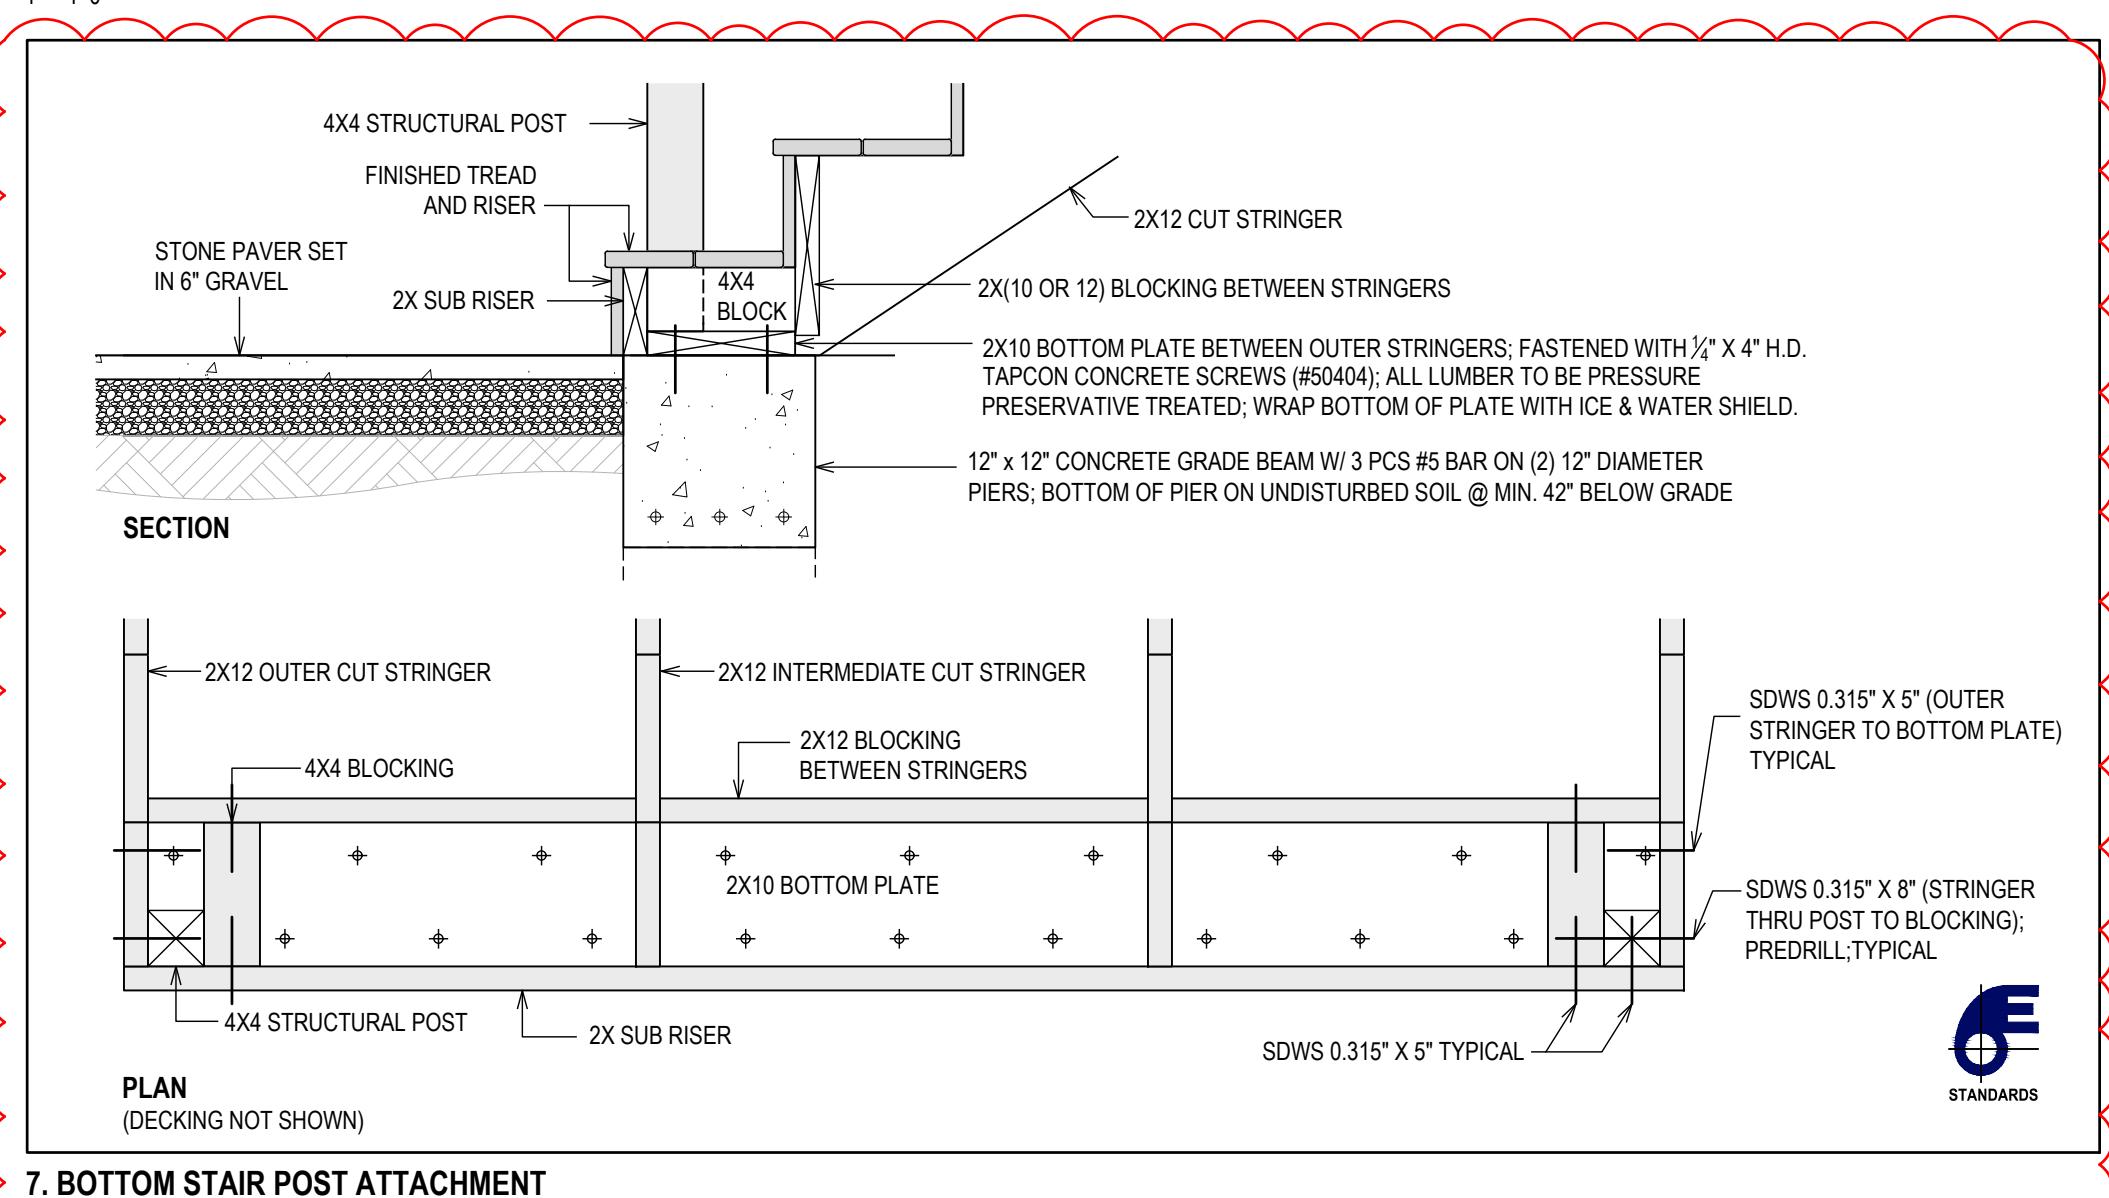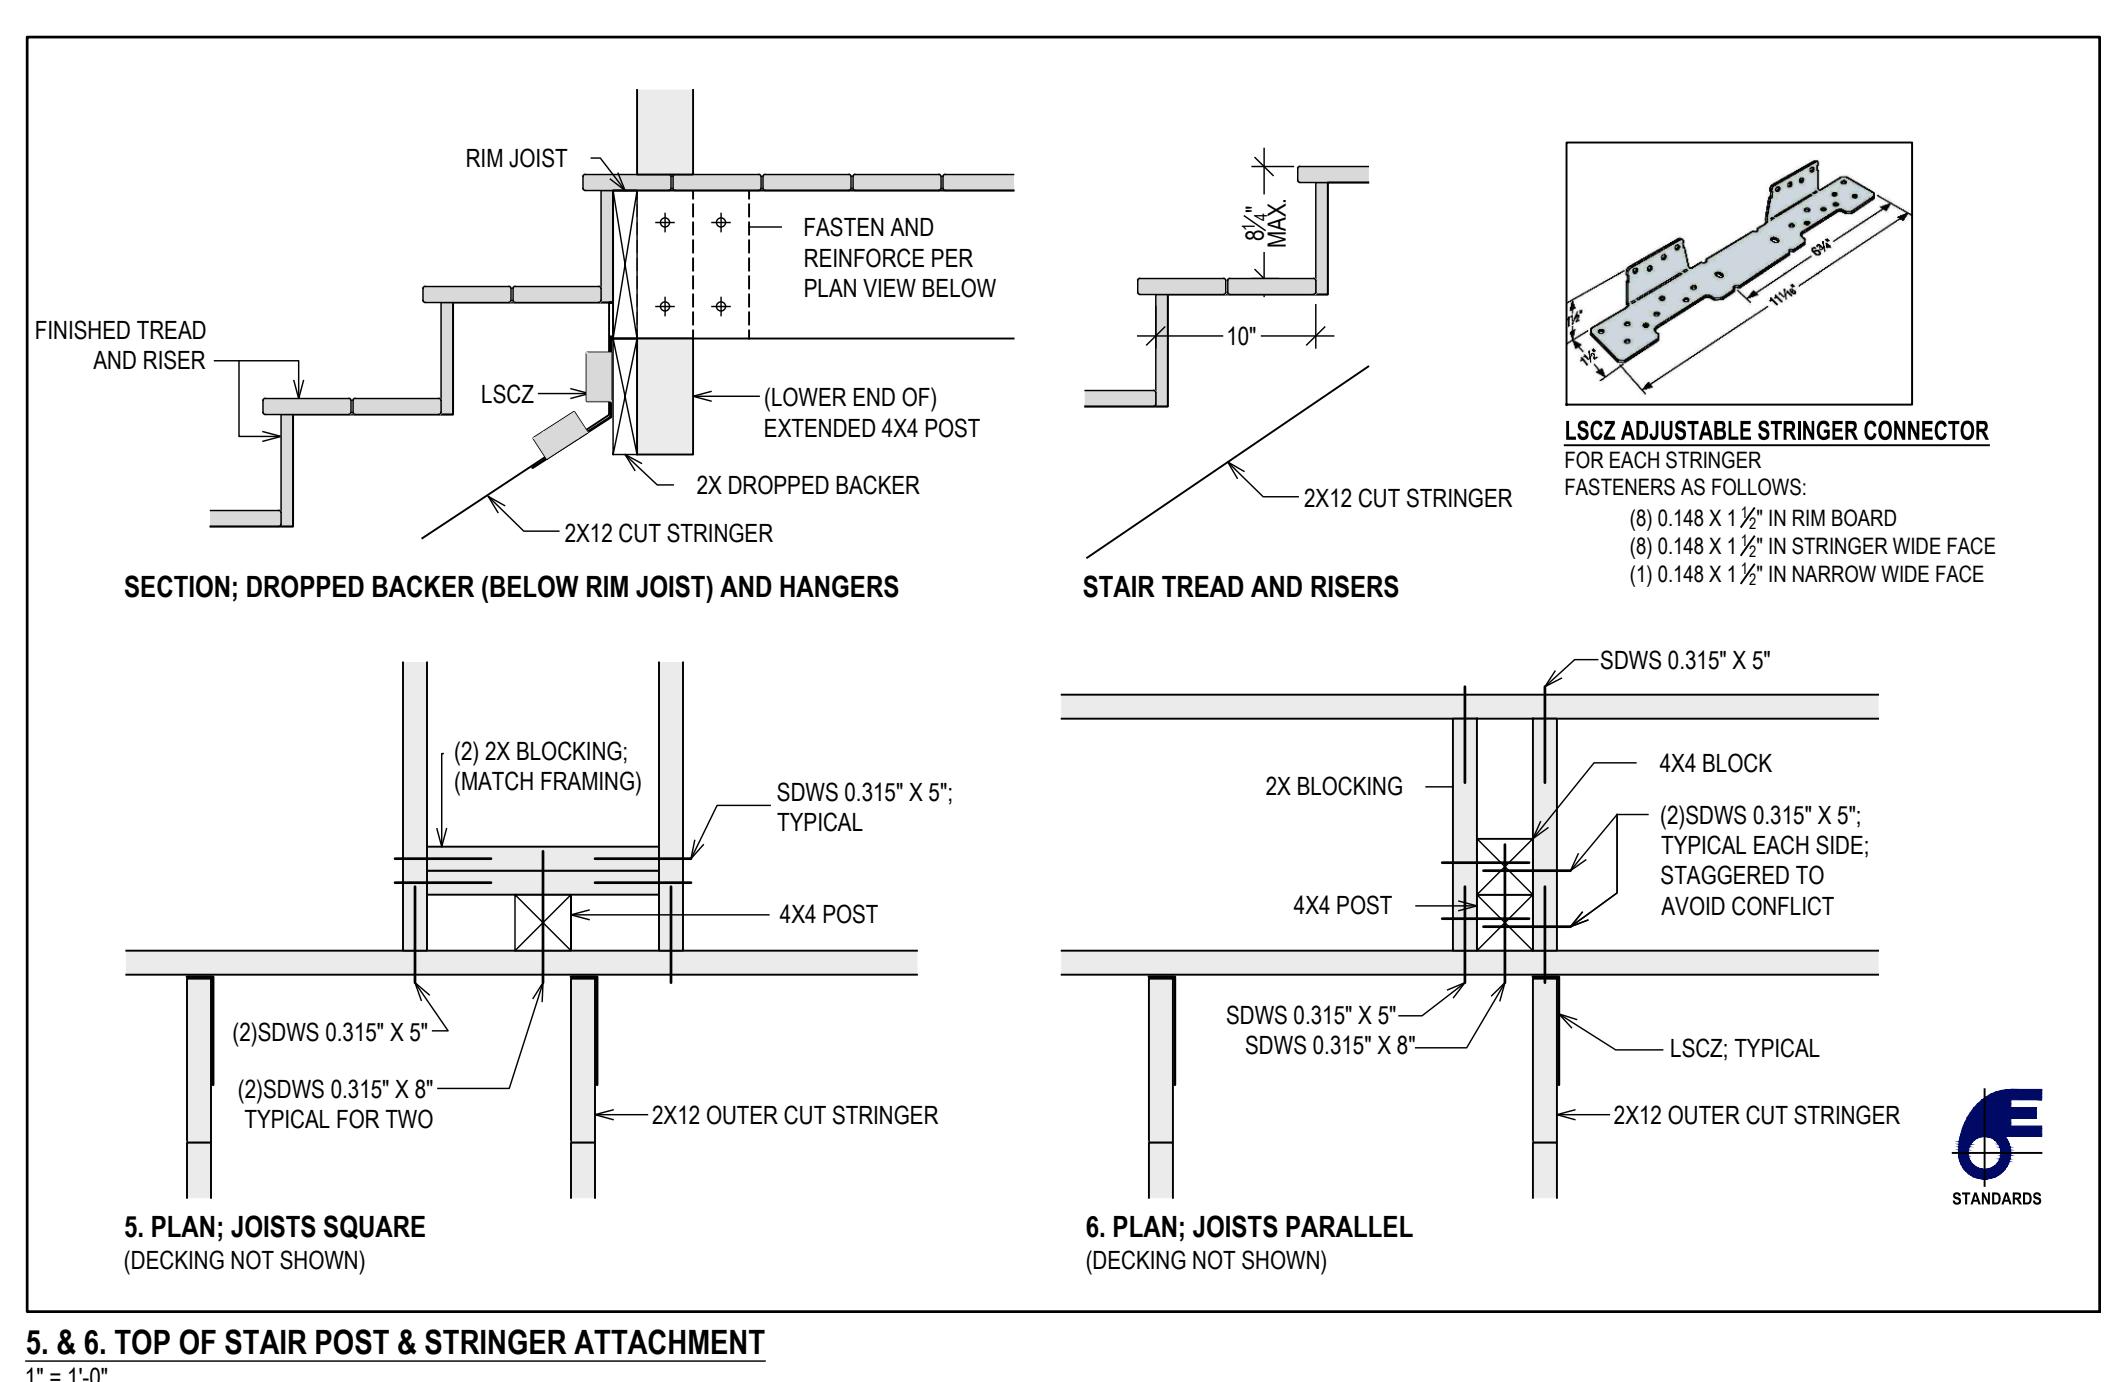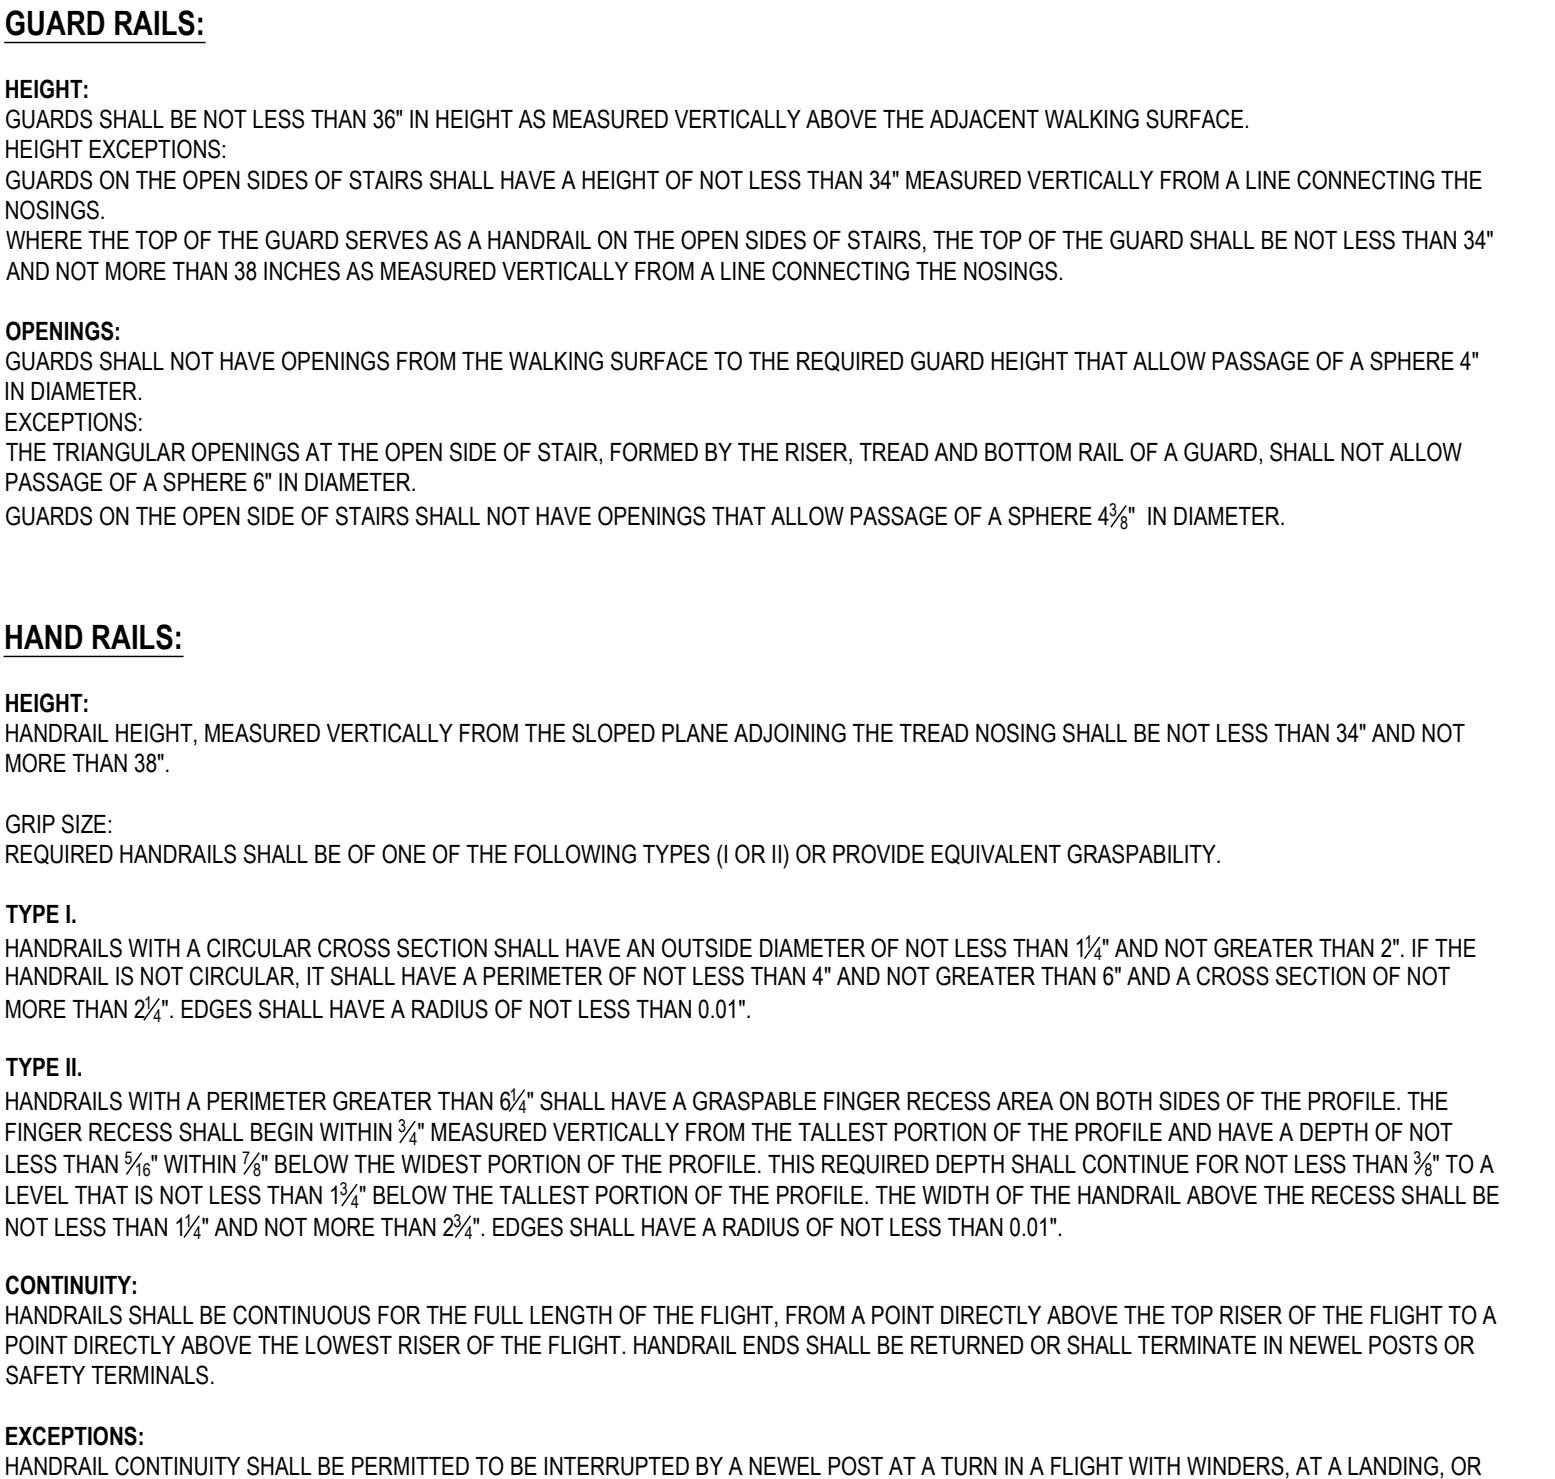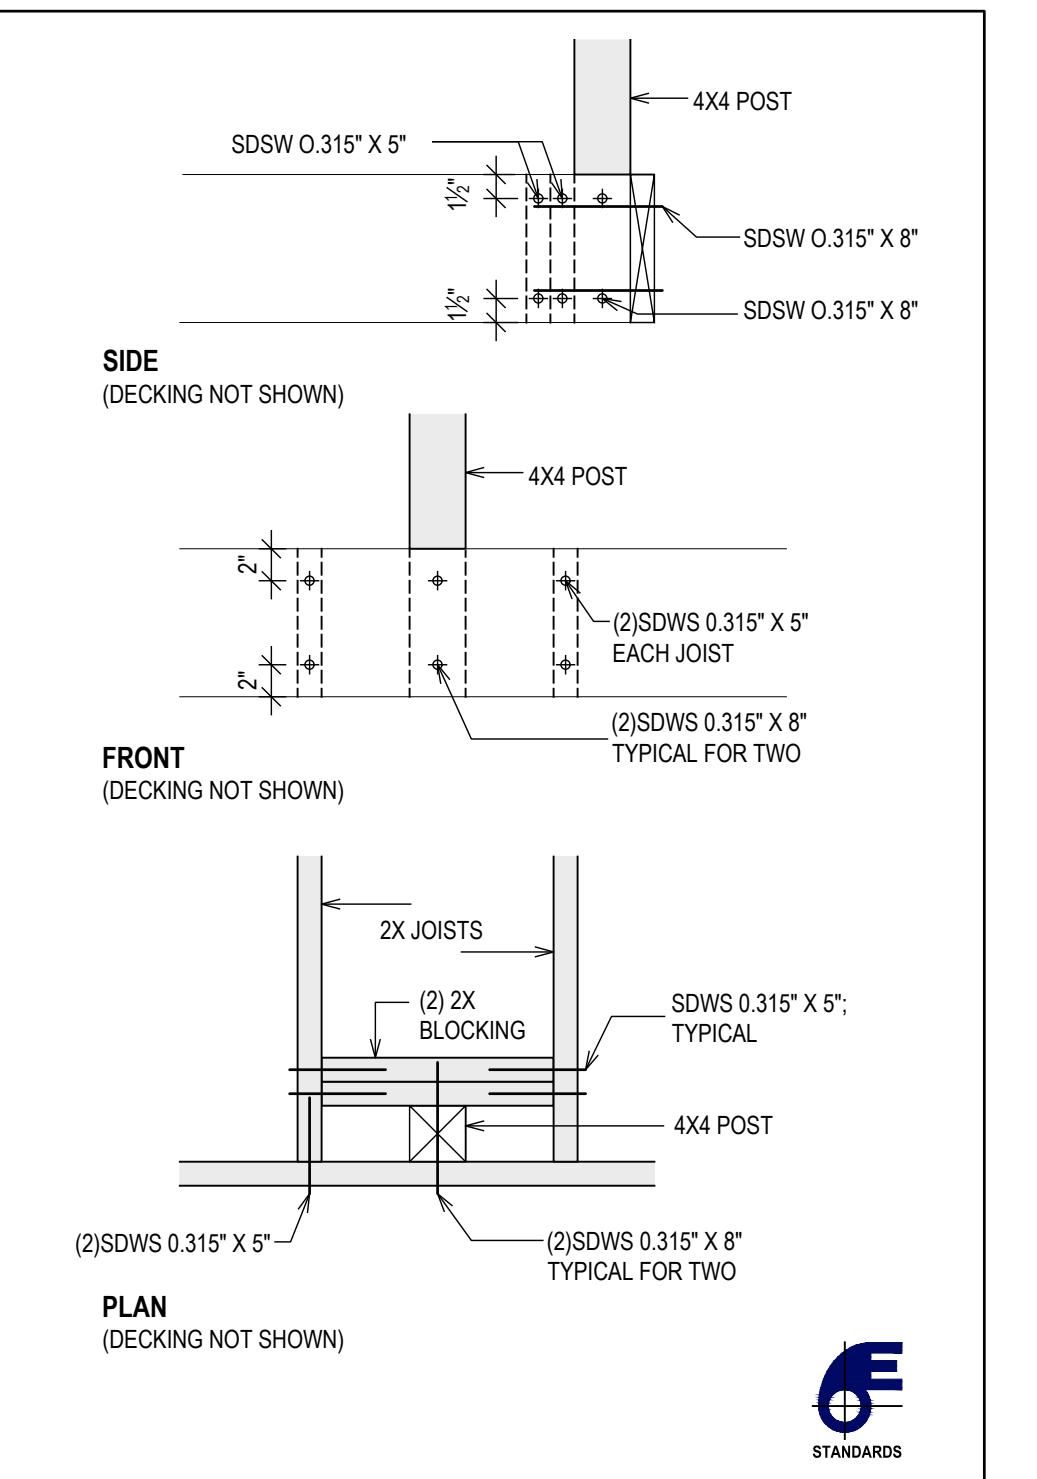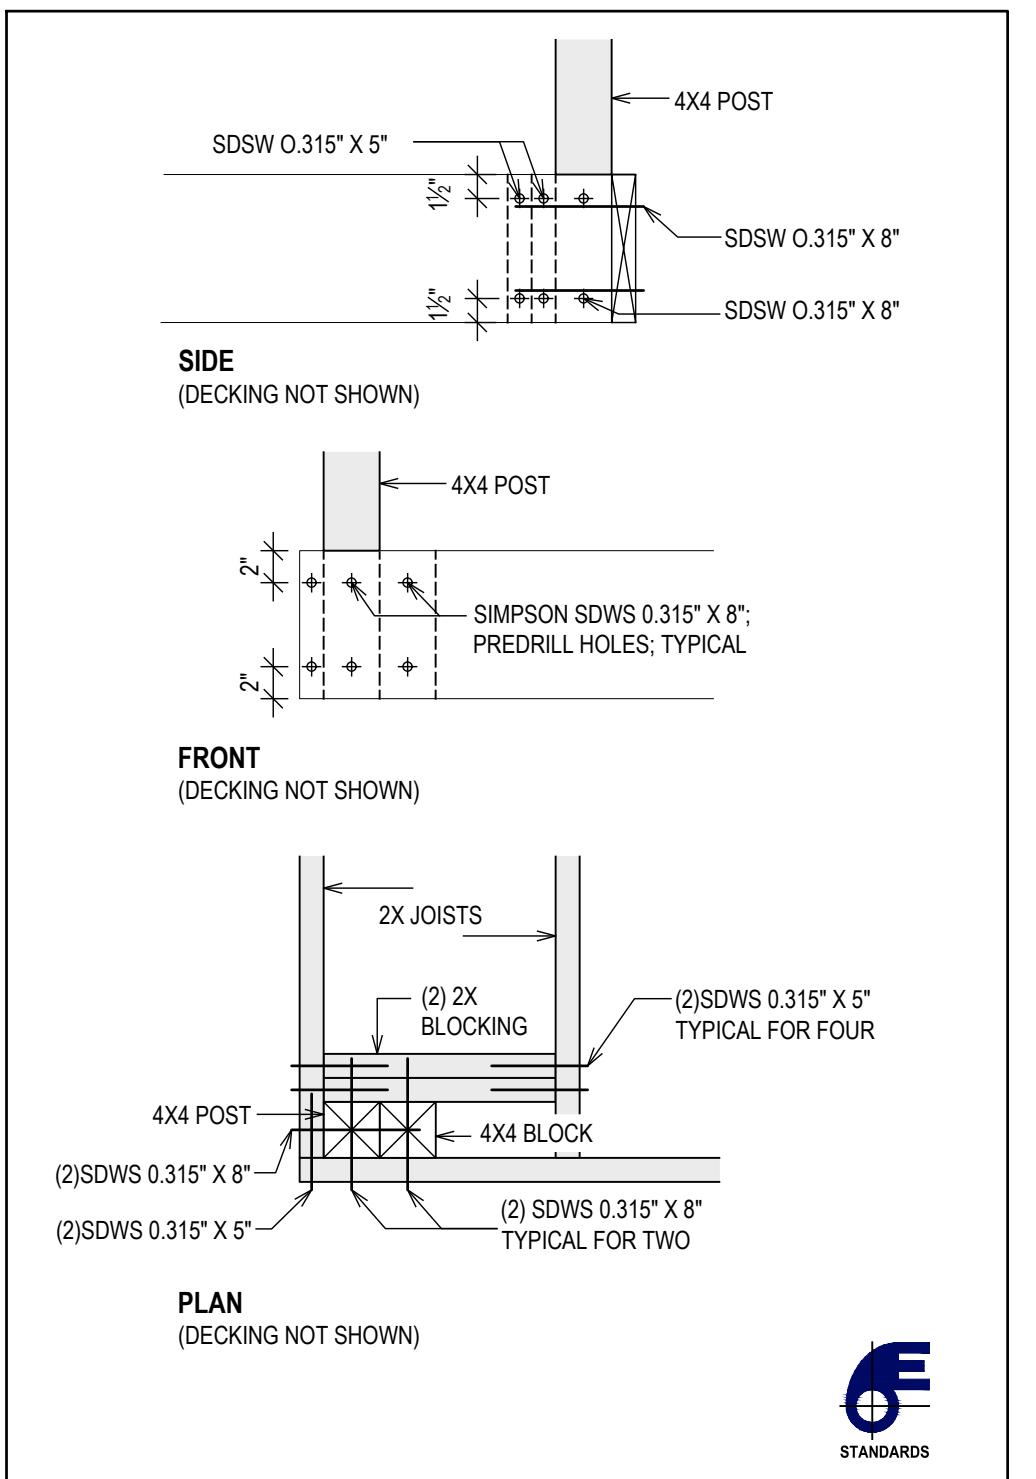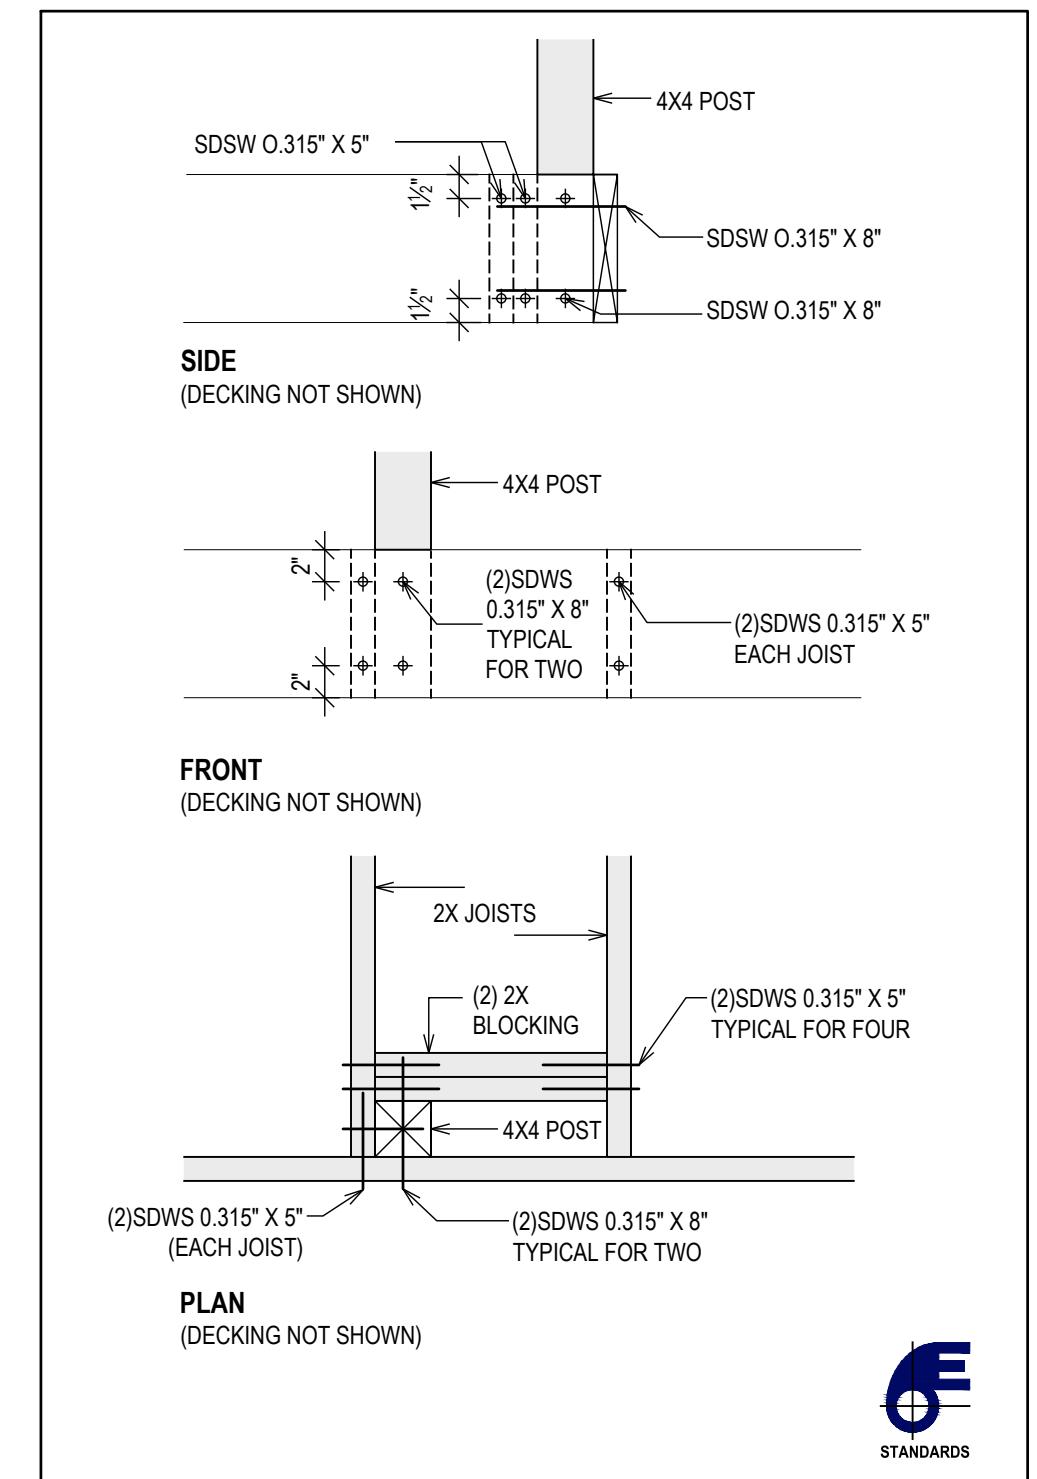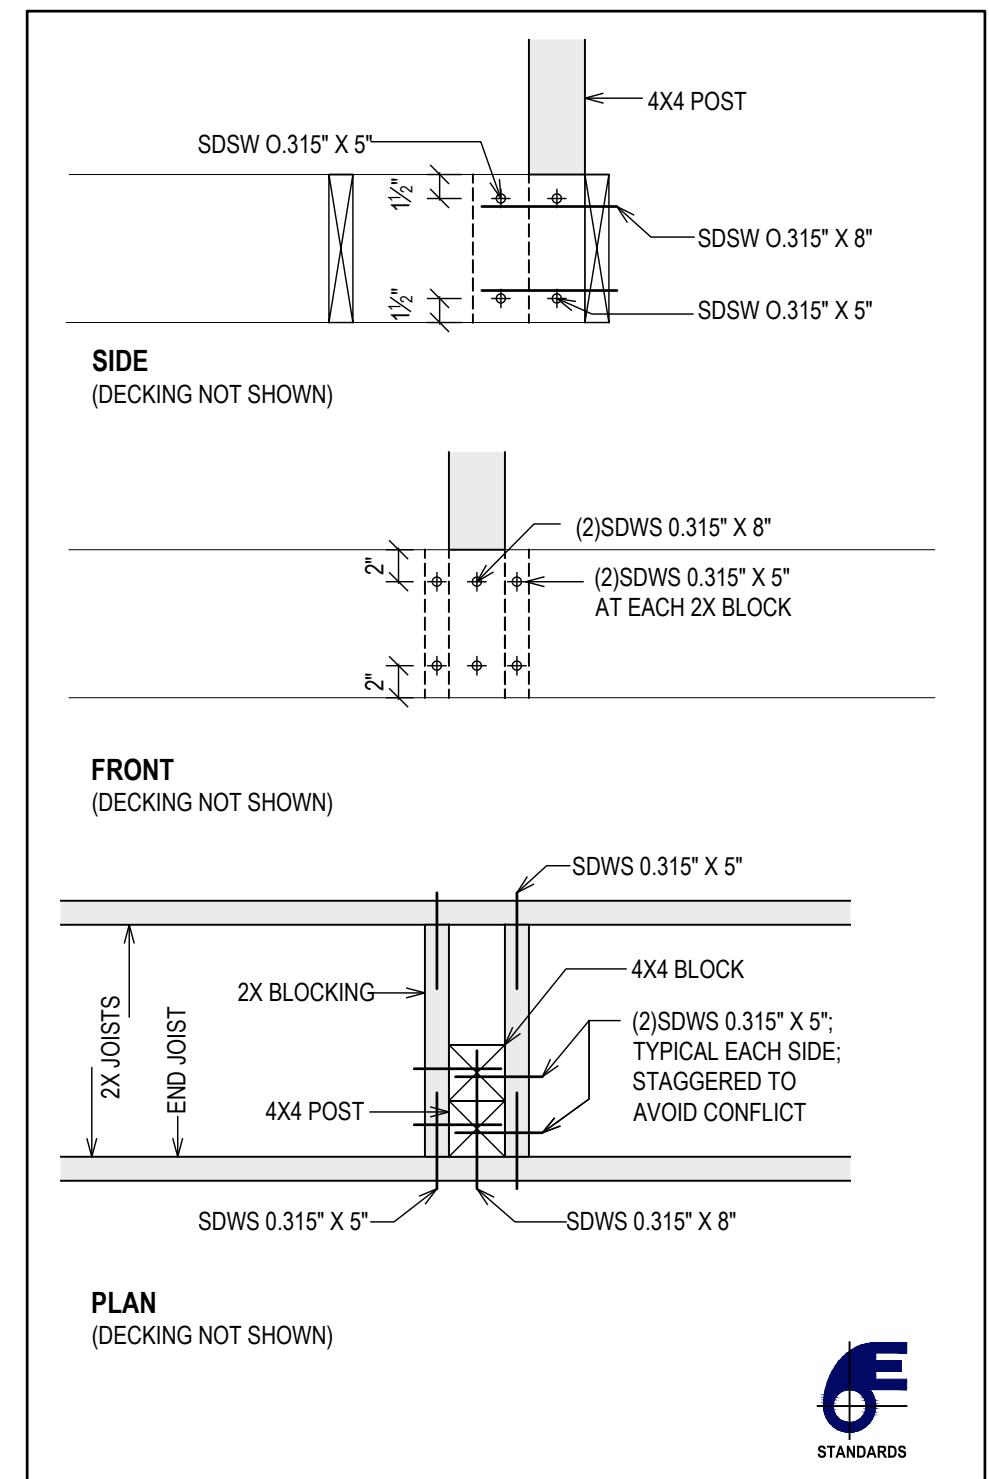


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TYPICAL POST LOCATION CONNECTION DETAILS
 (SEE DETAILS 1. THRU 7.)

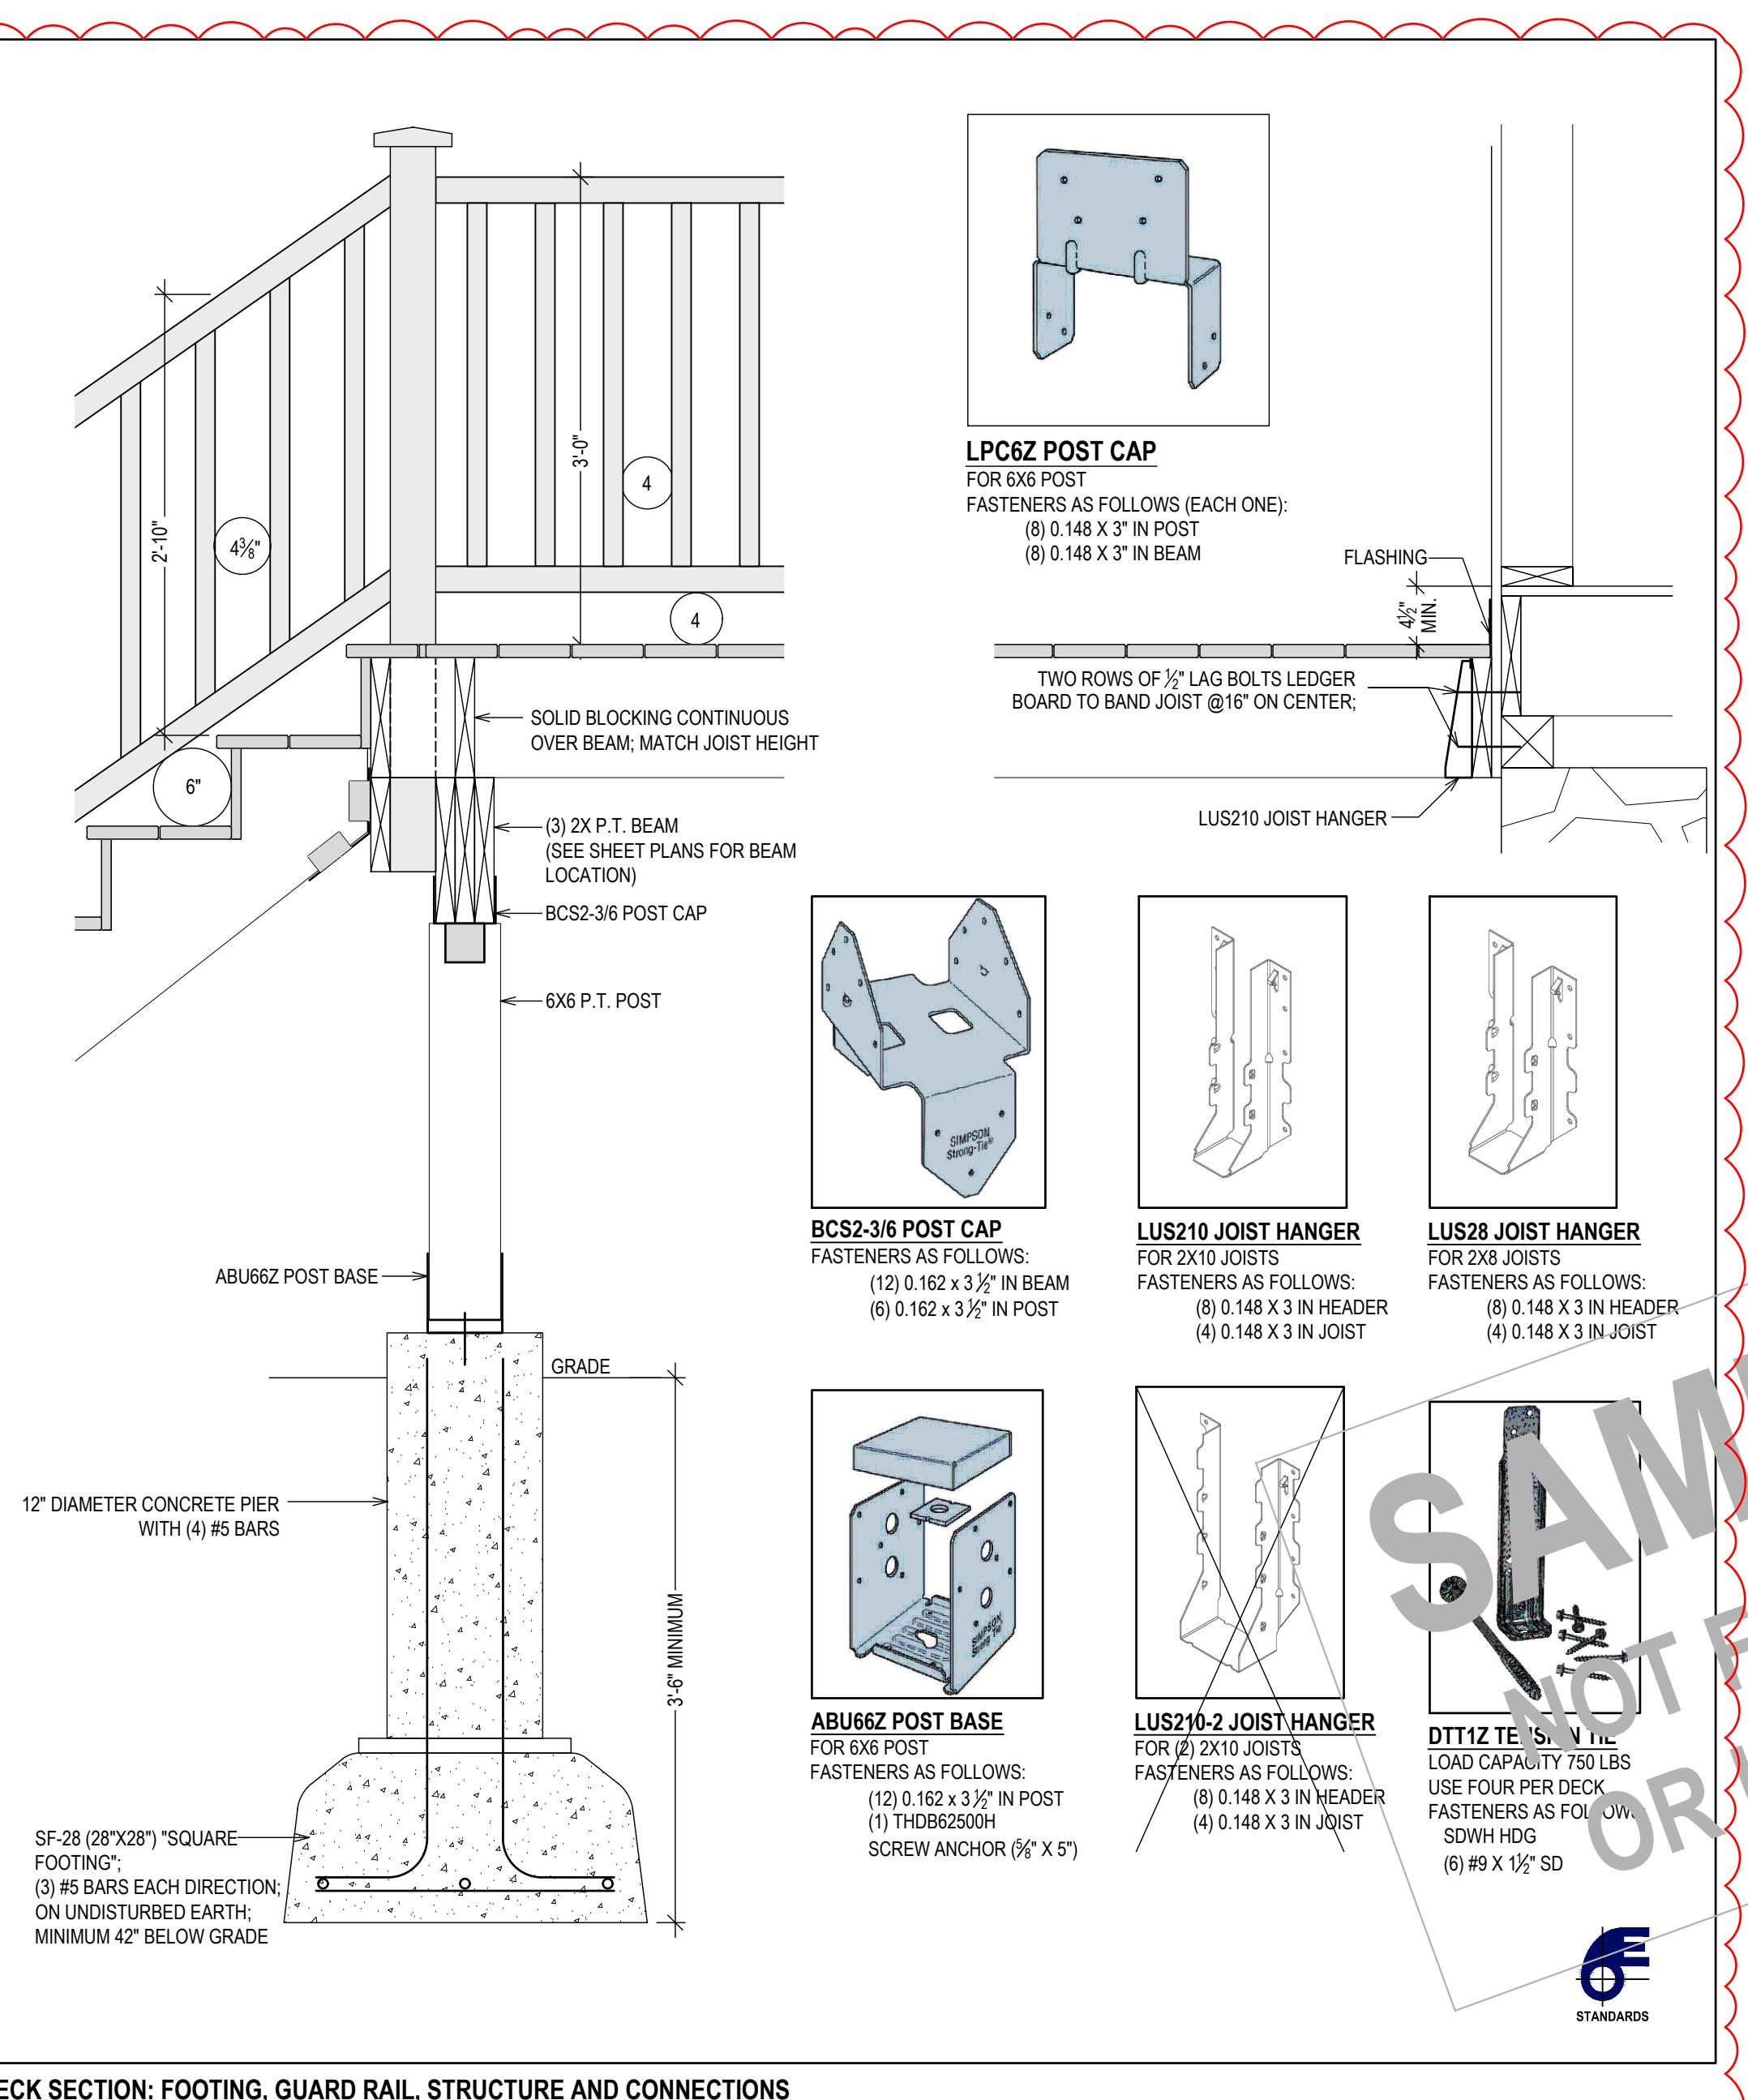BATHROOM

1. BATHTUB & SHOWER SPACES:




BATHTUB AND SHOWER FLOORS AND WALLS ABOVE BATHTUBS WITH INSTALLED SHOWER HEADS AND IN SHOWER COMPARTMENTS SHALL BE FINISHED WITH A NONABSORBENT SURFACE. SUCH WALL SURFACES SHALL EXTEND TO A HEIGHT OF NOT LESS THAN 6 FEET ABOVE THE FLOOR.

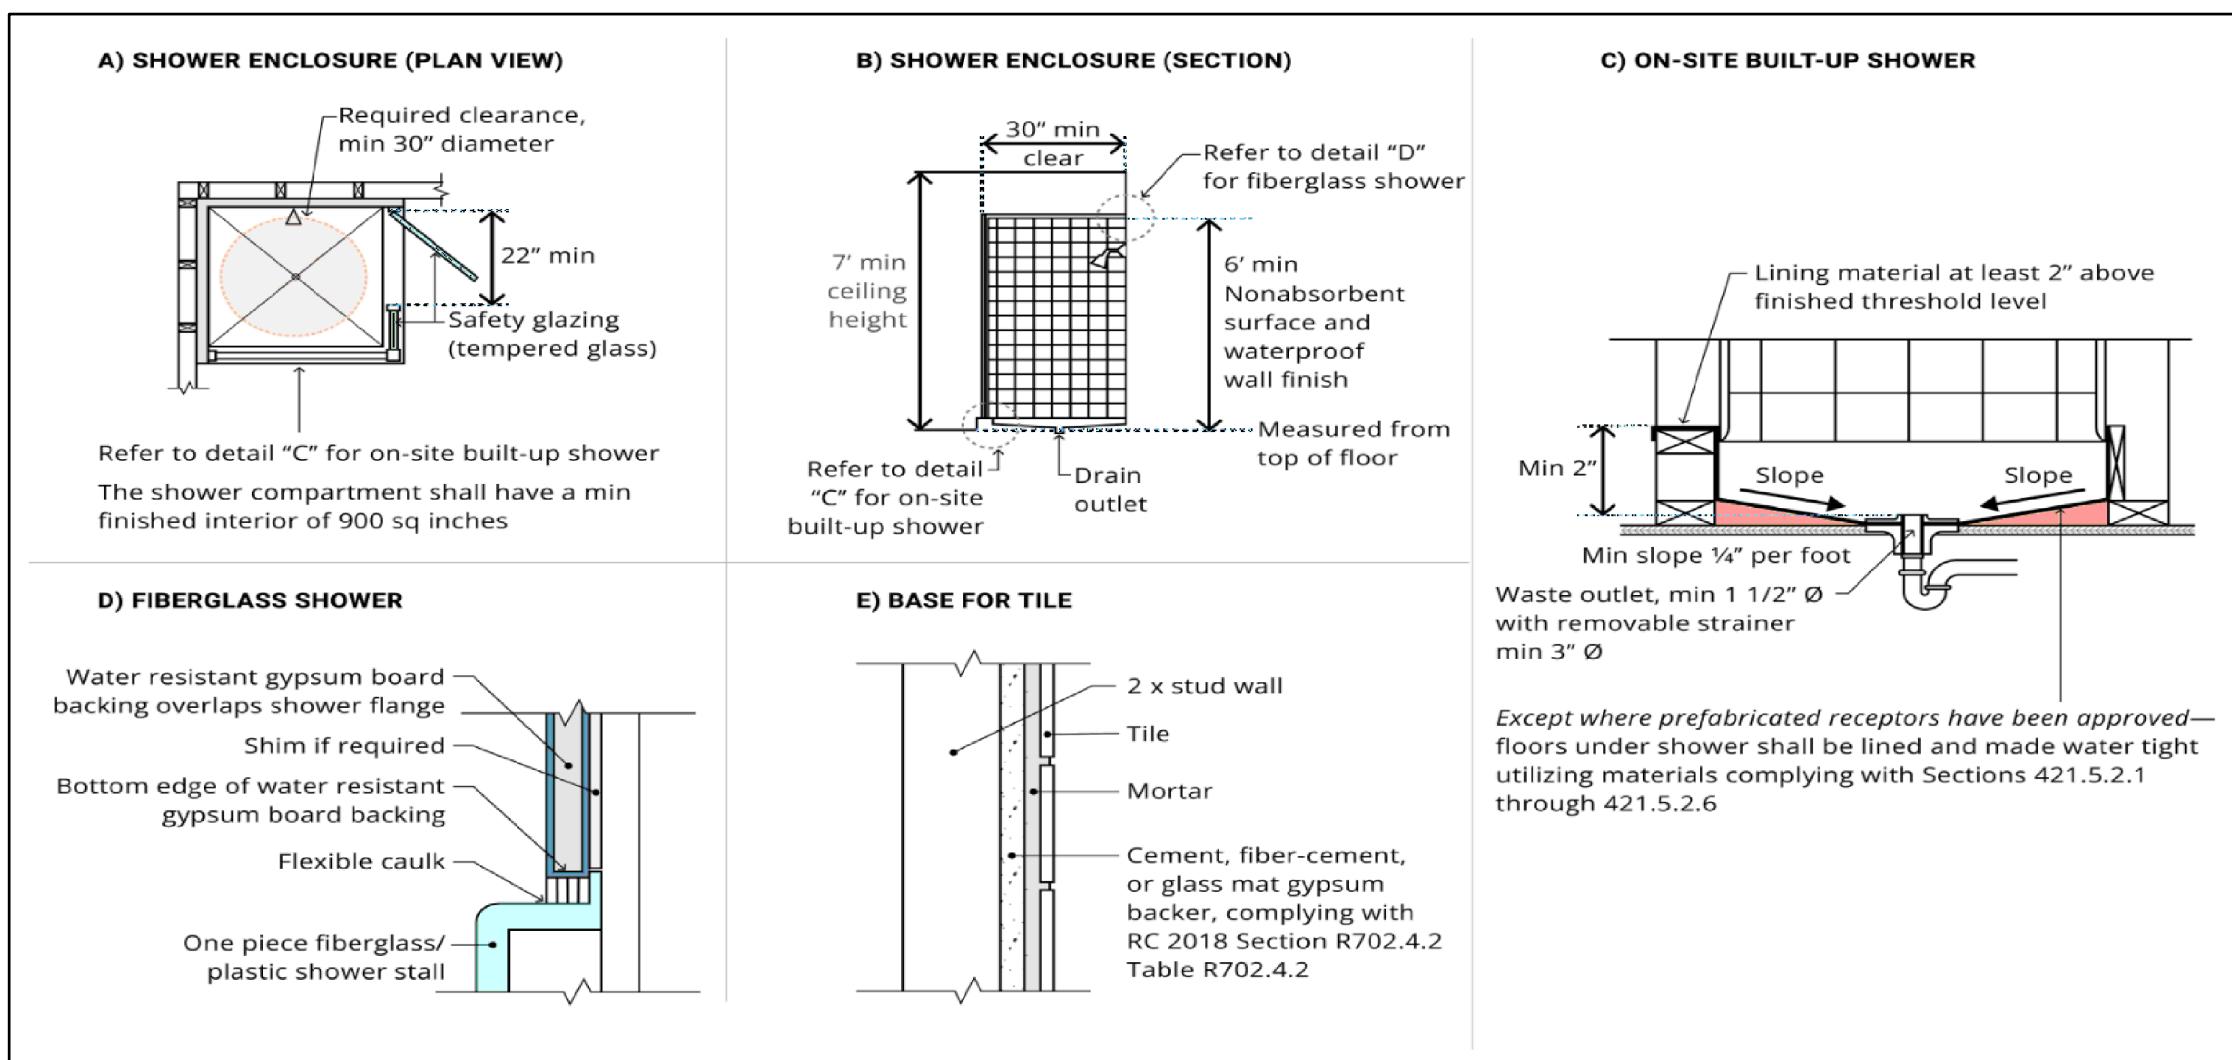TYPICAL BATHROOM DETAILS


ALL CONFIGURATIONS MAY NOT APPLY

2. PLUMBING FIXTURE CLEARANCES:

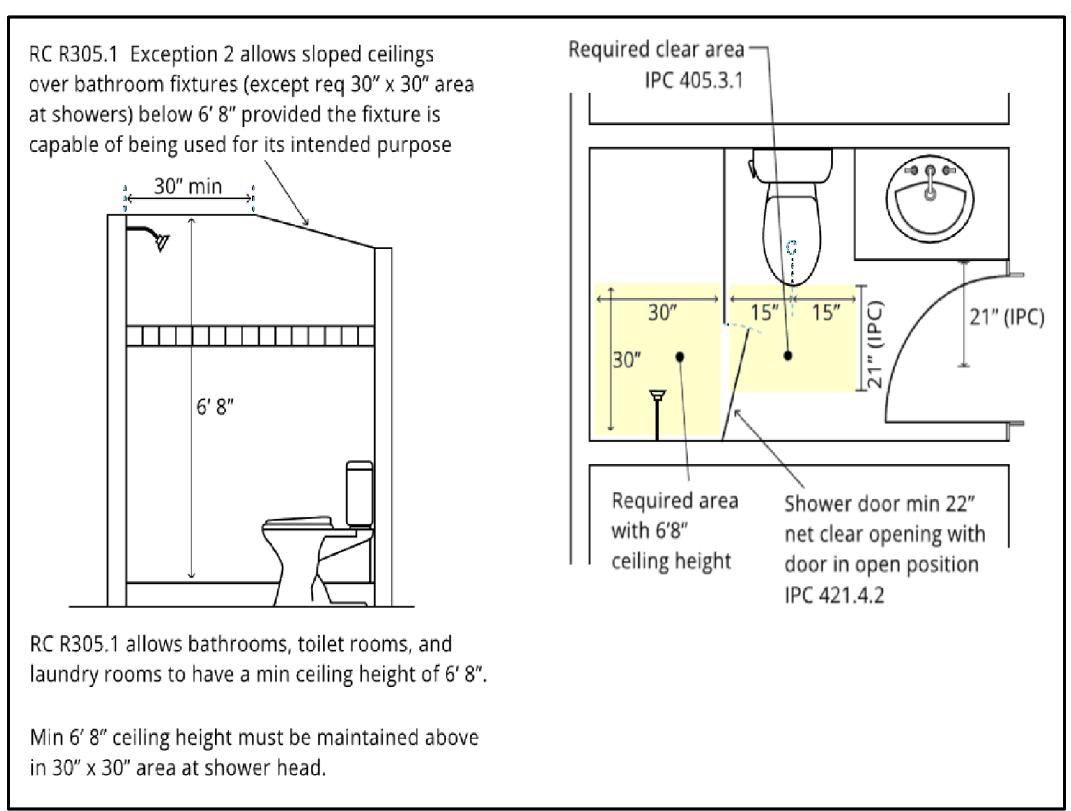



Fixture Clearances (Section 405 of the Plumbing Code):
 Fixture clearances shown apply to non-accessible / ADA conditions.
 Verify with multifamily housing or accessible fixture clearance requirements when fixtures are required to be accessible.

WATER CLOSETS, URINALS, LAVATORIES AND BIDETS:
 A water closet, urinal, lavatory or bidet shall not be set closer than 15 inches from its center to any side wall, partition, vanity or other obstruction.
 Where partitions or other obstructions do not separate adjacent water closets, urinals, or bidets, the fixtures shall not be set closer than 30 inches center to center between adjacent fixtures or between water closets, urinals, or bidets.
 There shall be not less than a 1-inch clearance in front of a water closet, urinal, lavatory or bidet to any wall, fixture or door.
 Water closet compartments shall be not less than 30 inches in width and not less than 60 inches in depth for floor-mounted water closets and not less than 30 inches in width and 36 inches in depth for wall-hung water closets.

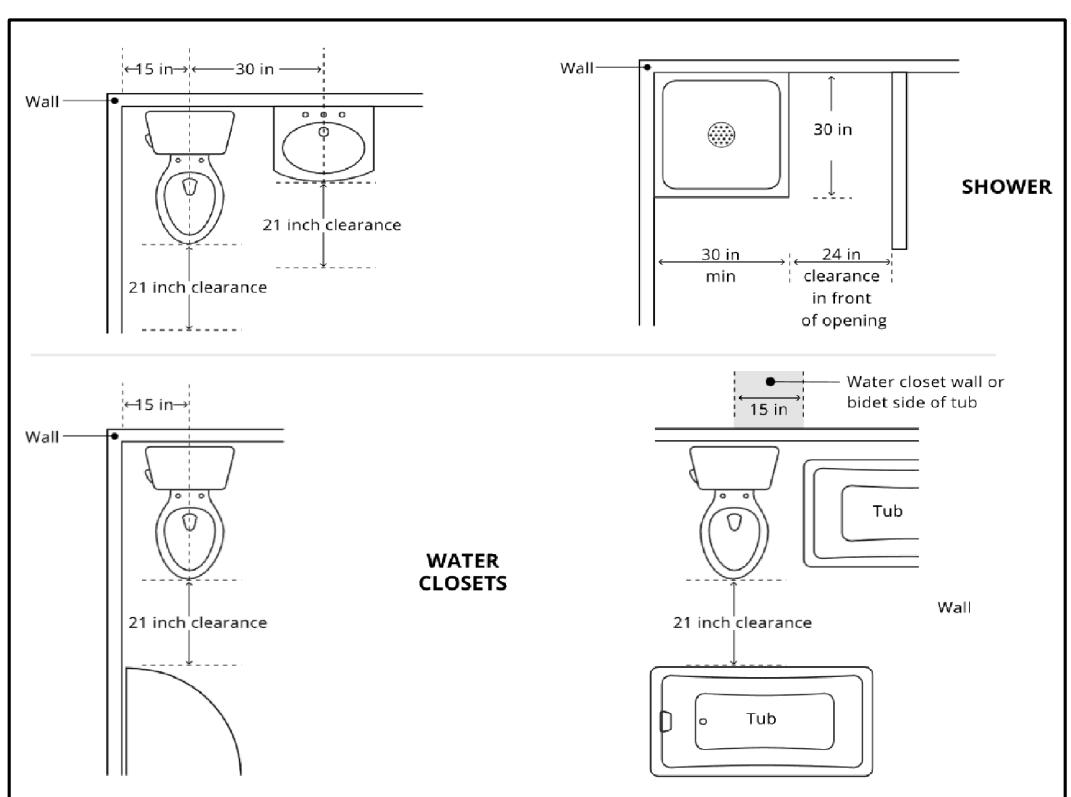

Plumbing Fixture Clearances:
 PLUMBING FIXTURES REQUIRE MINIMUM AREAS IN FRONT TO PROVIDE SAFE USABILITY AND MAINTENANCE OF THE FIXTURE. SOME JURISDICTIONS MAY REQUIRE COMPLIANCE WITH PLUMBING CODES, WHICH MAY BE MORE STRINGENT THAN SHOWN IN THIS DIAGRAM. THESE CLEARANCES SHOULD NOT BE CONFUSED WITH THE CLEARANCES REQUIRED FOR DISABLED ACCESS.

Fixture Installation:
 FLOOR-OUTLET OR FLOOR-MOUNTED FIXTURES SHALL BE SECURED TO THE DRAINAGE CONNECTION AND TO THE FLOOR, WHERE SO DESIGNED, BY SCREWS, BOLTS, WASHERS, NUTS AND SIMILAR FASTENERS OF COPPER, COPPER ALLOY OR OTHER CORROSION RESISTANT MATERIAL.
 WALL-HUNG FIXTURES SHALL BE RIDGELY SUPPORTED SO THAT STRAIN IS NOT TRANSMITTED TO THE PLUMBING SYSTEM.
 WHERE FIXTURES COME IN CONTACT WITH WALLS AND FLOORS, THE CONTACT AREA SHALL BE WATERTIGHT.

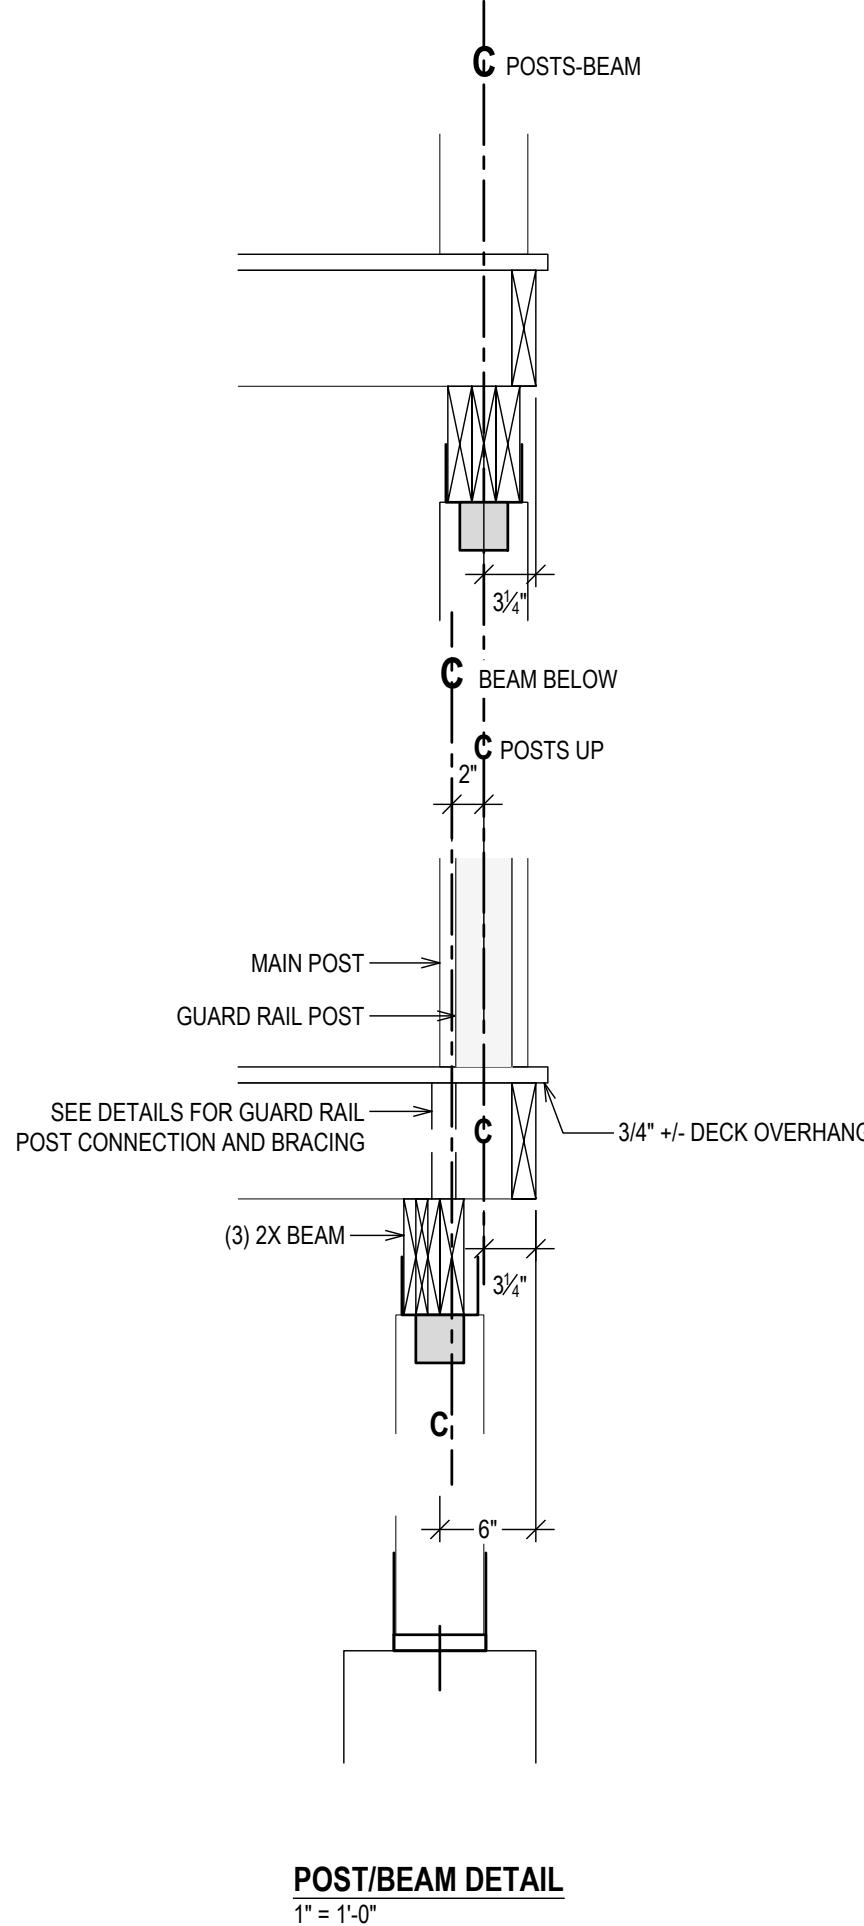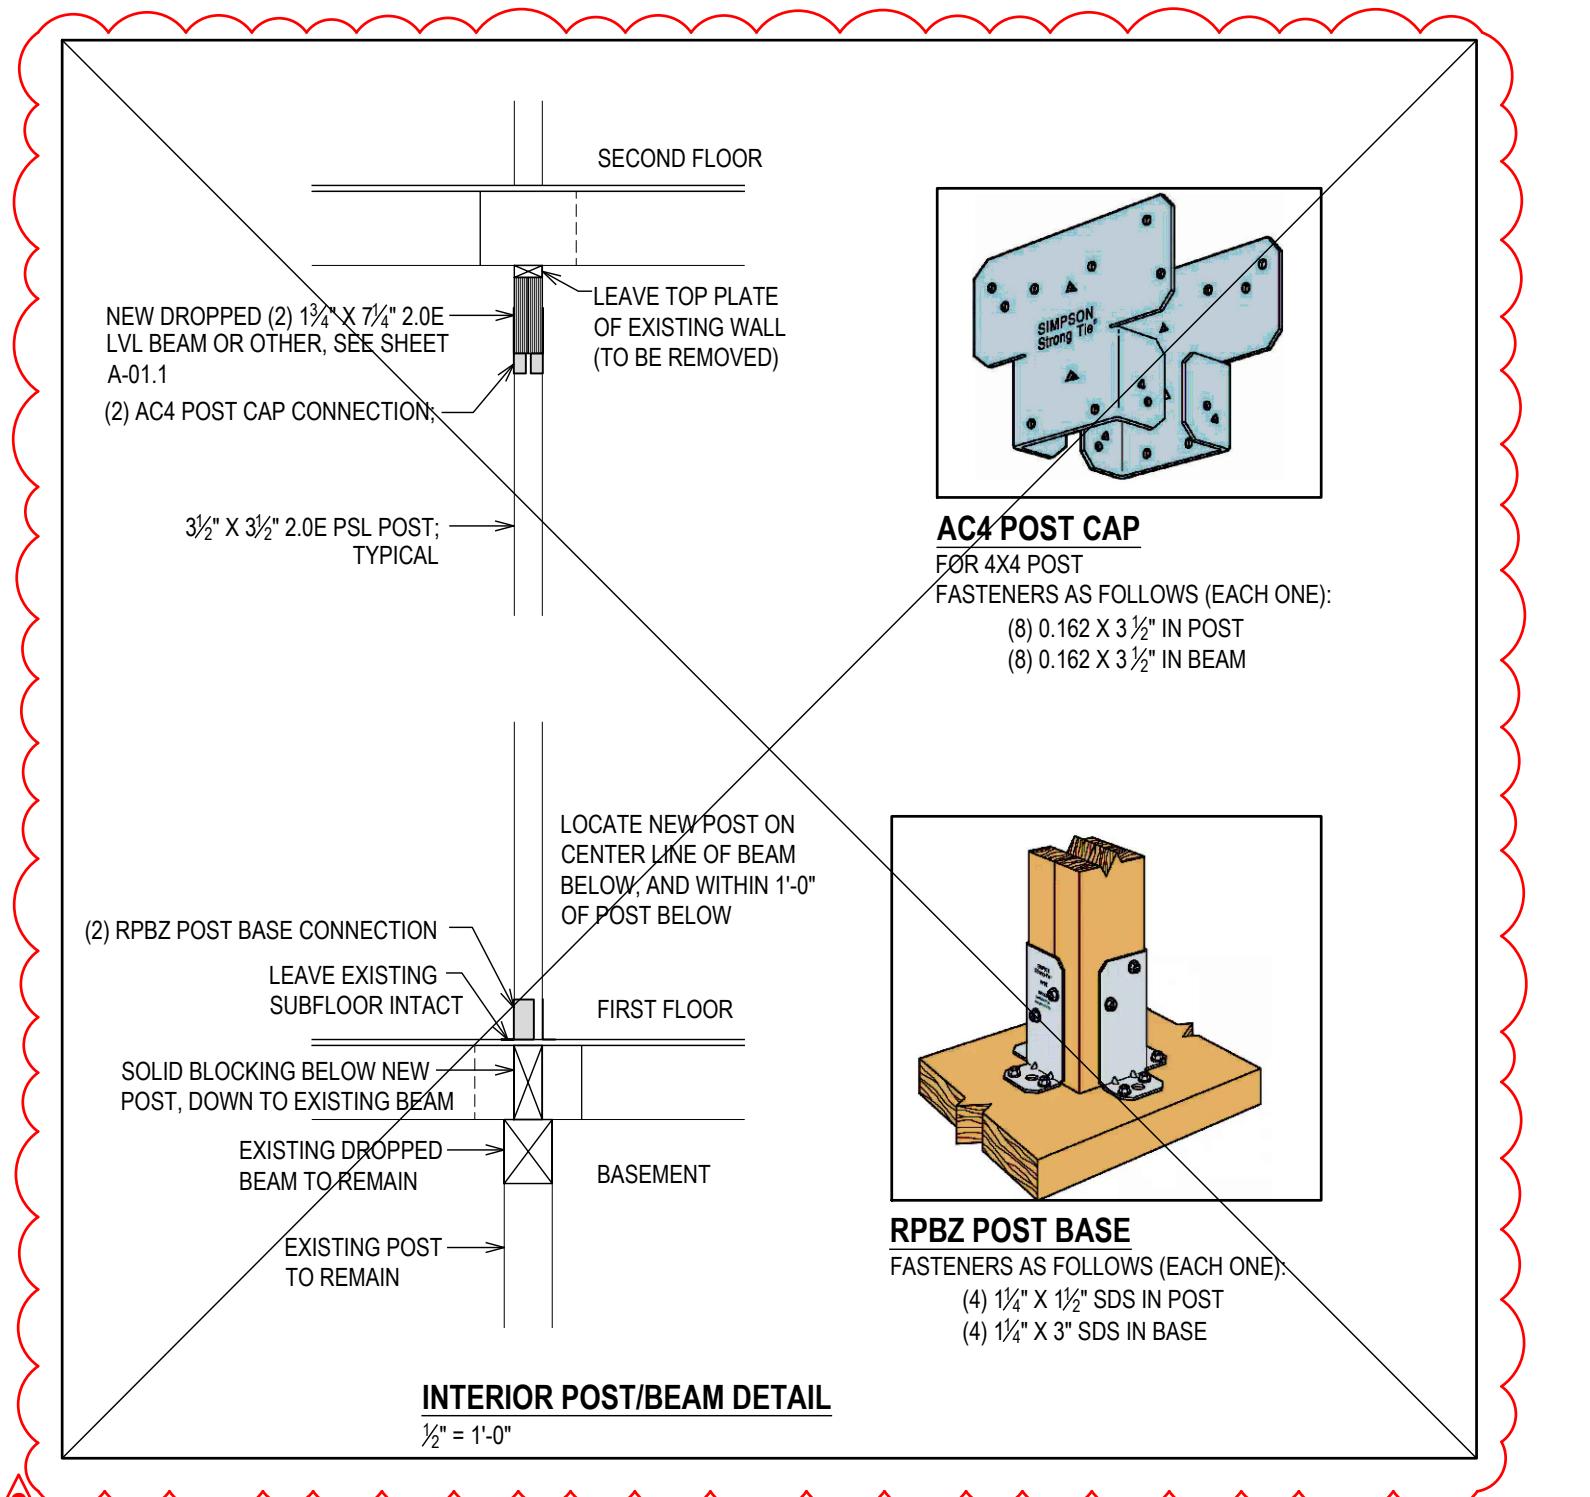

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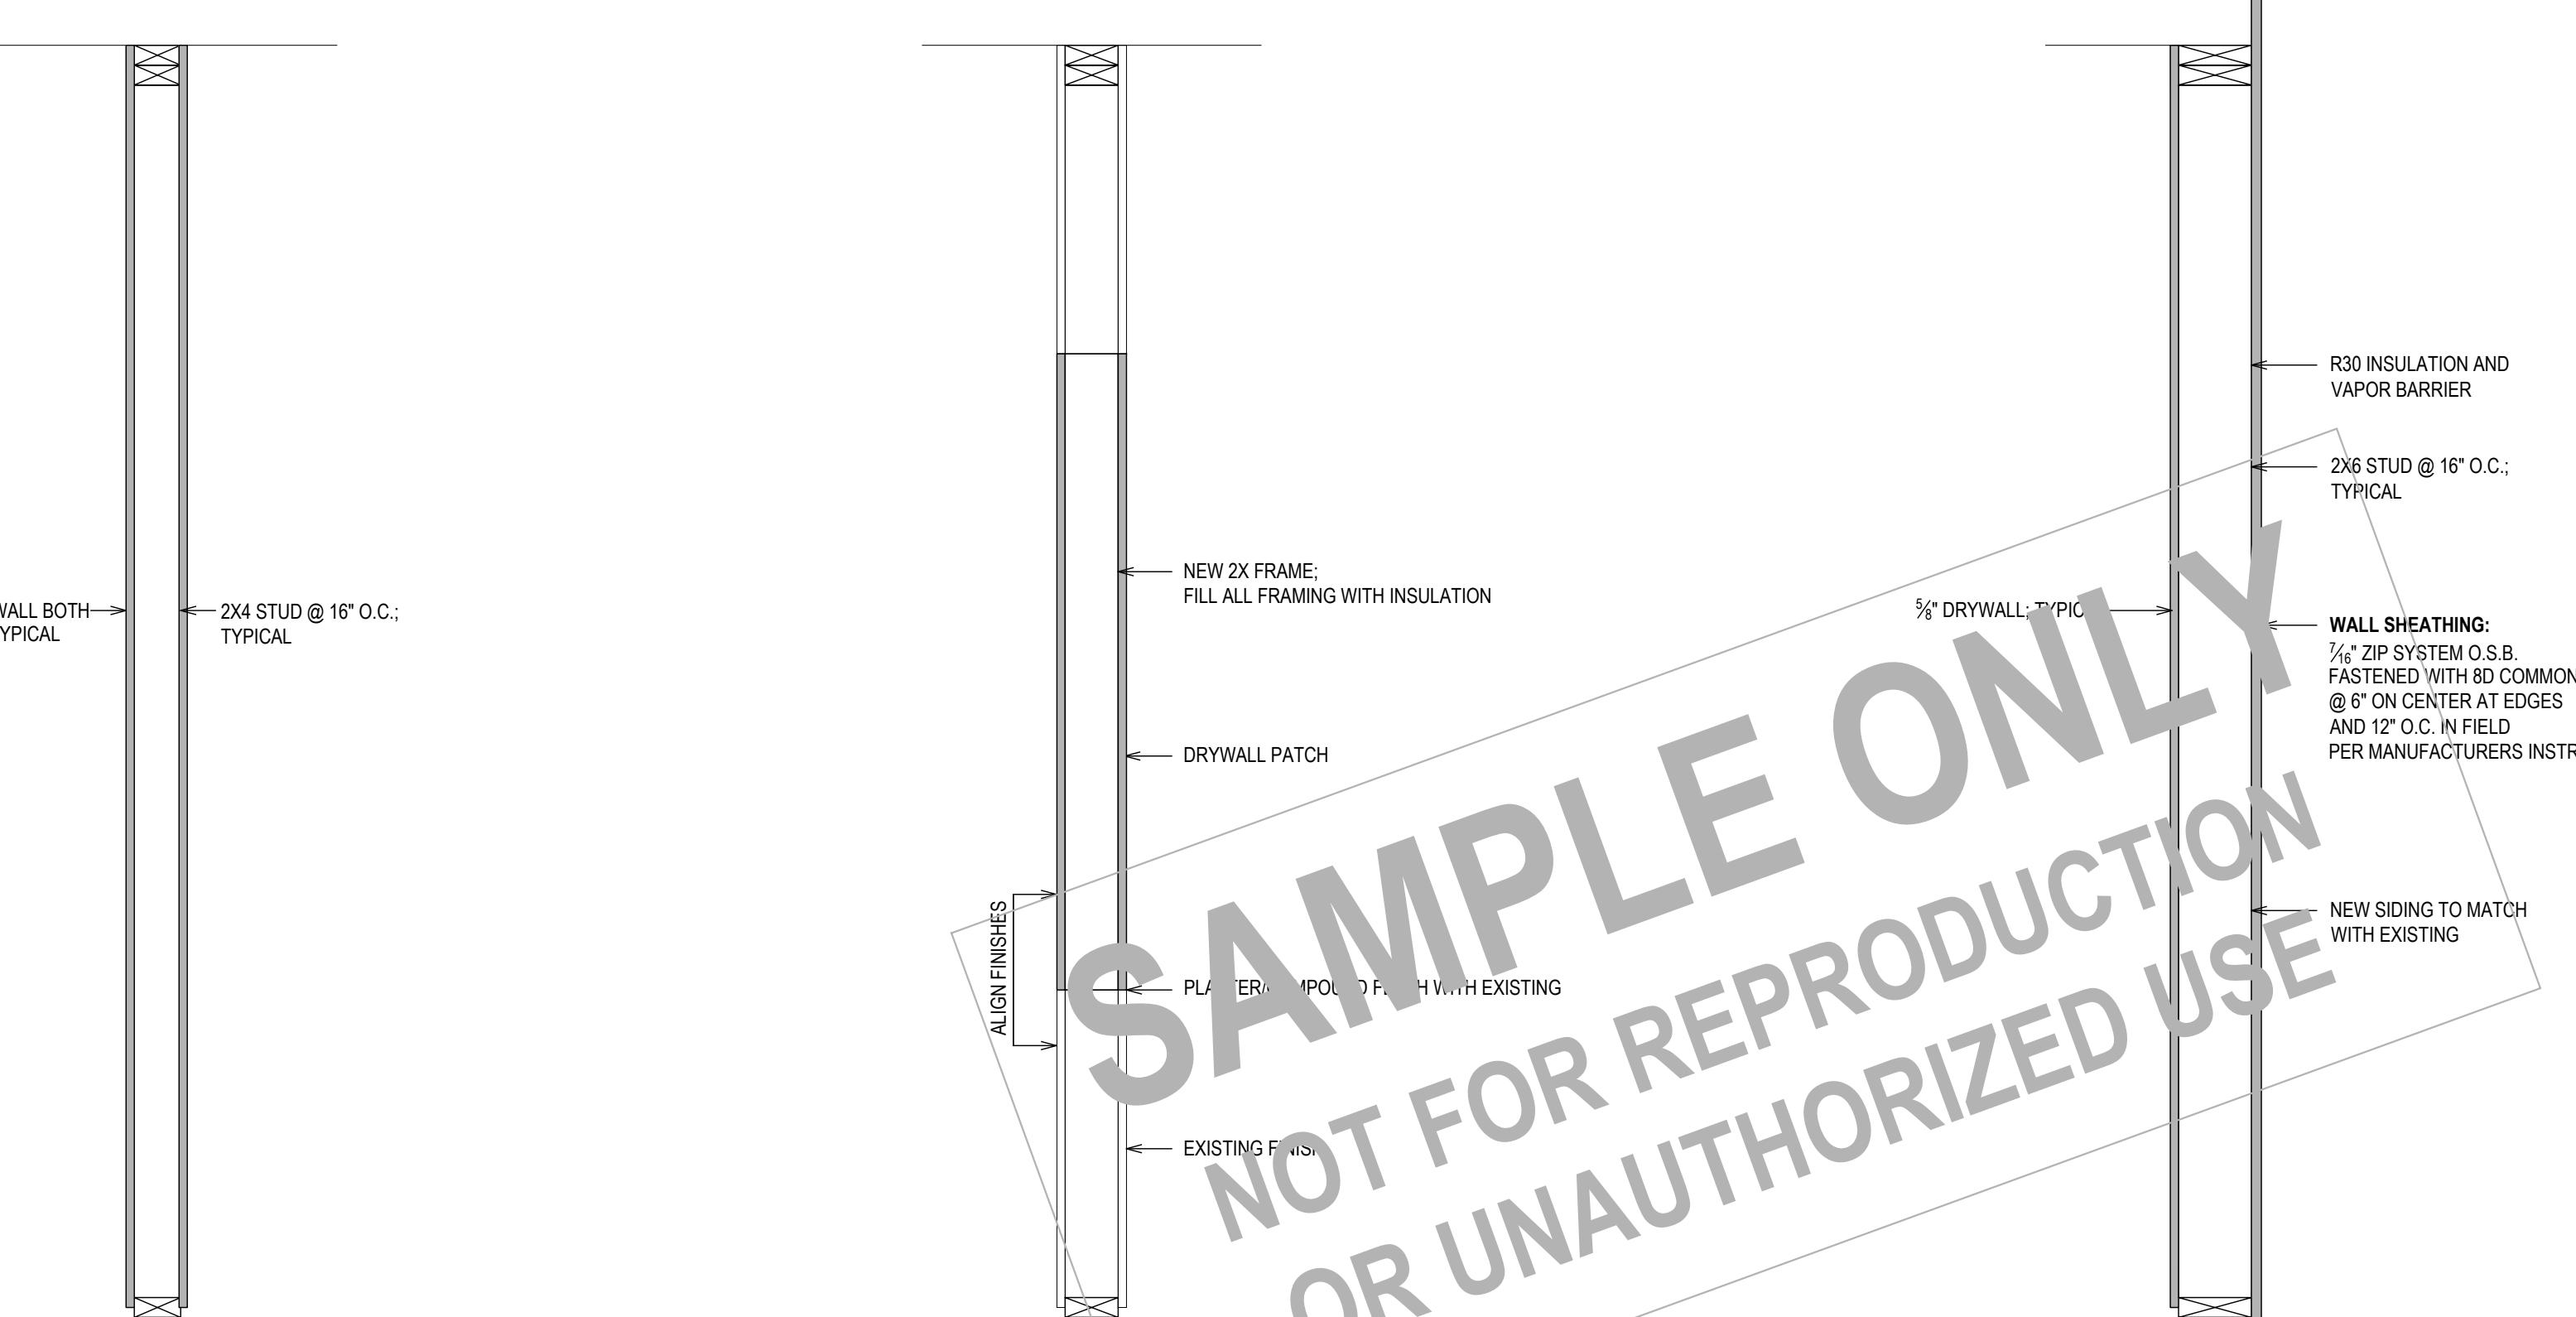
PROJECT NAME:
FLOOR PLAN ALTERATION

DRAWING NAME:
Typical Details

DRAWING NUMBER:
A-06.1

DATE: 05.15.2025
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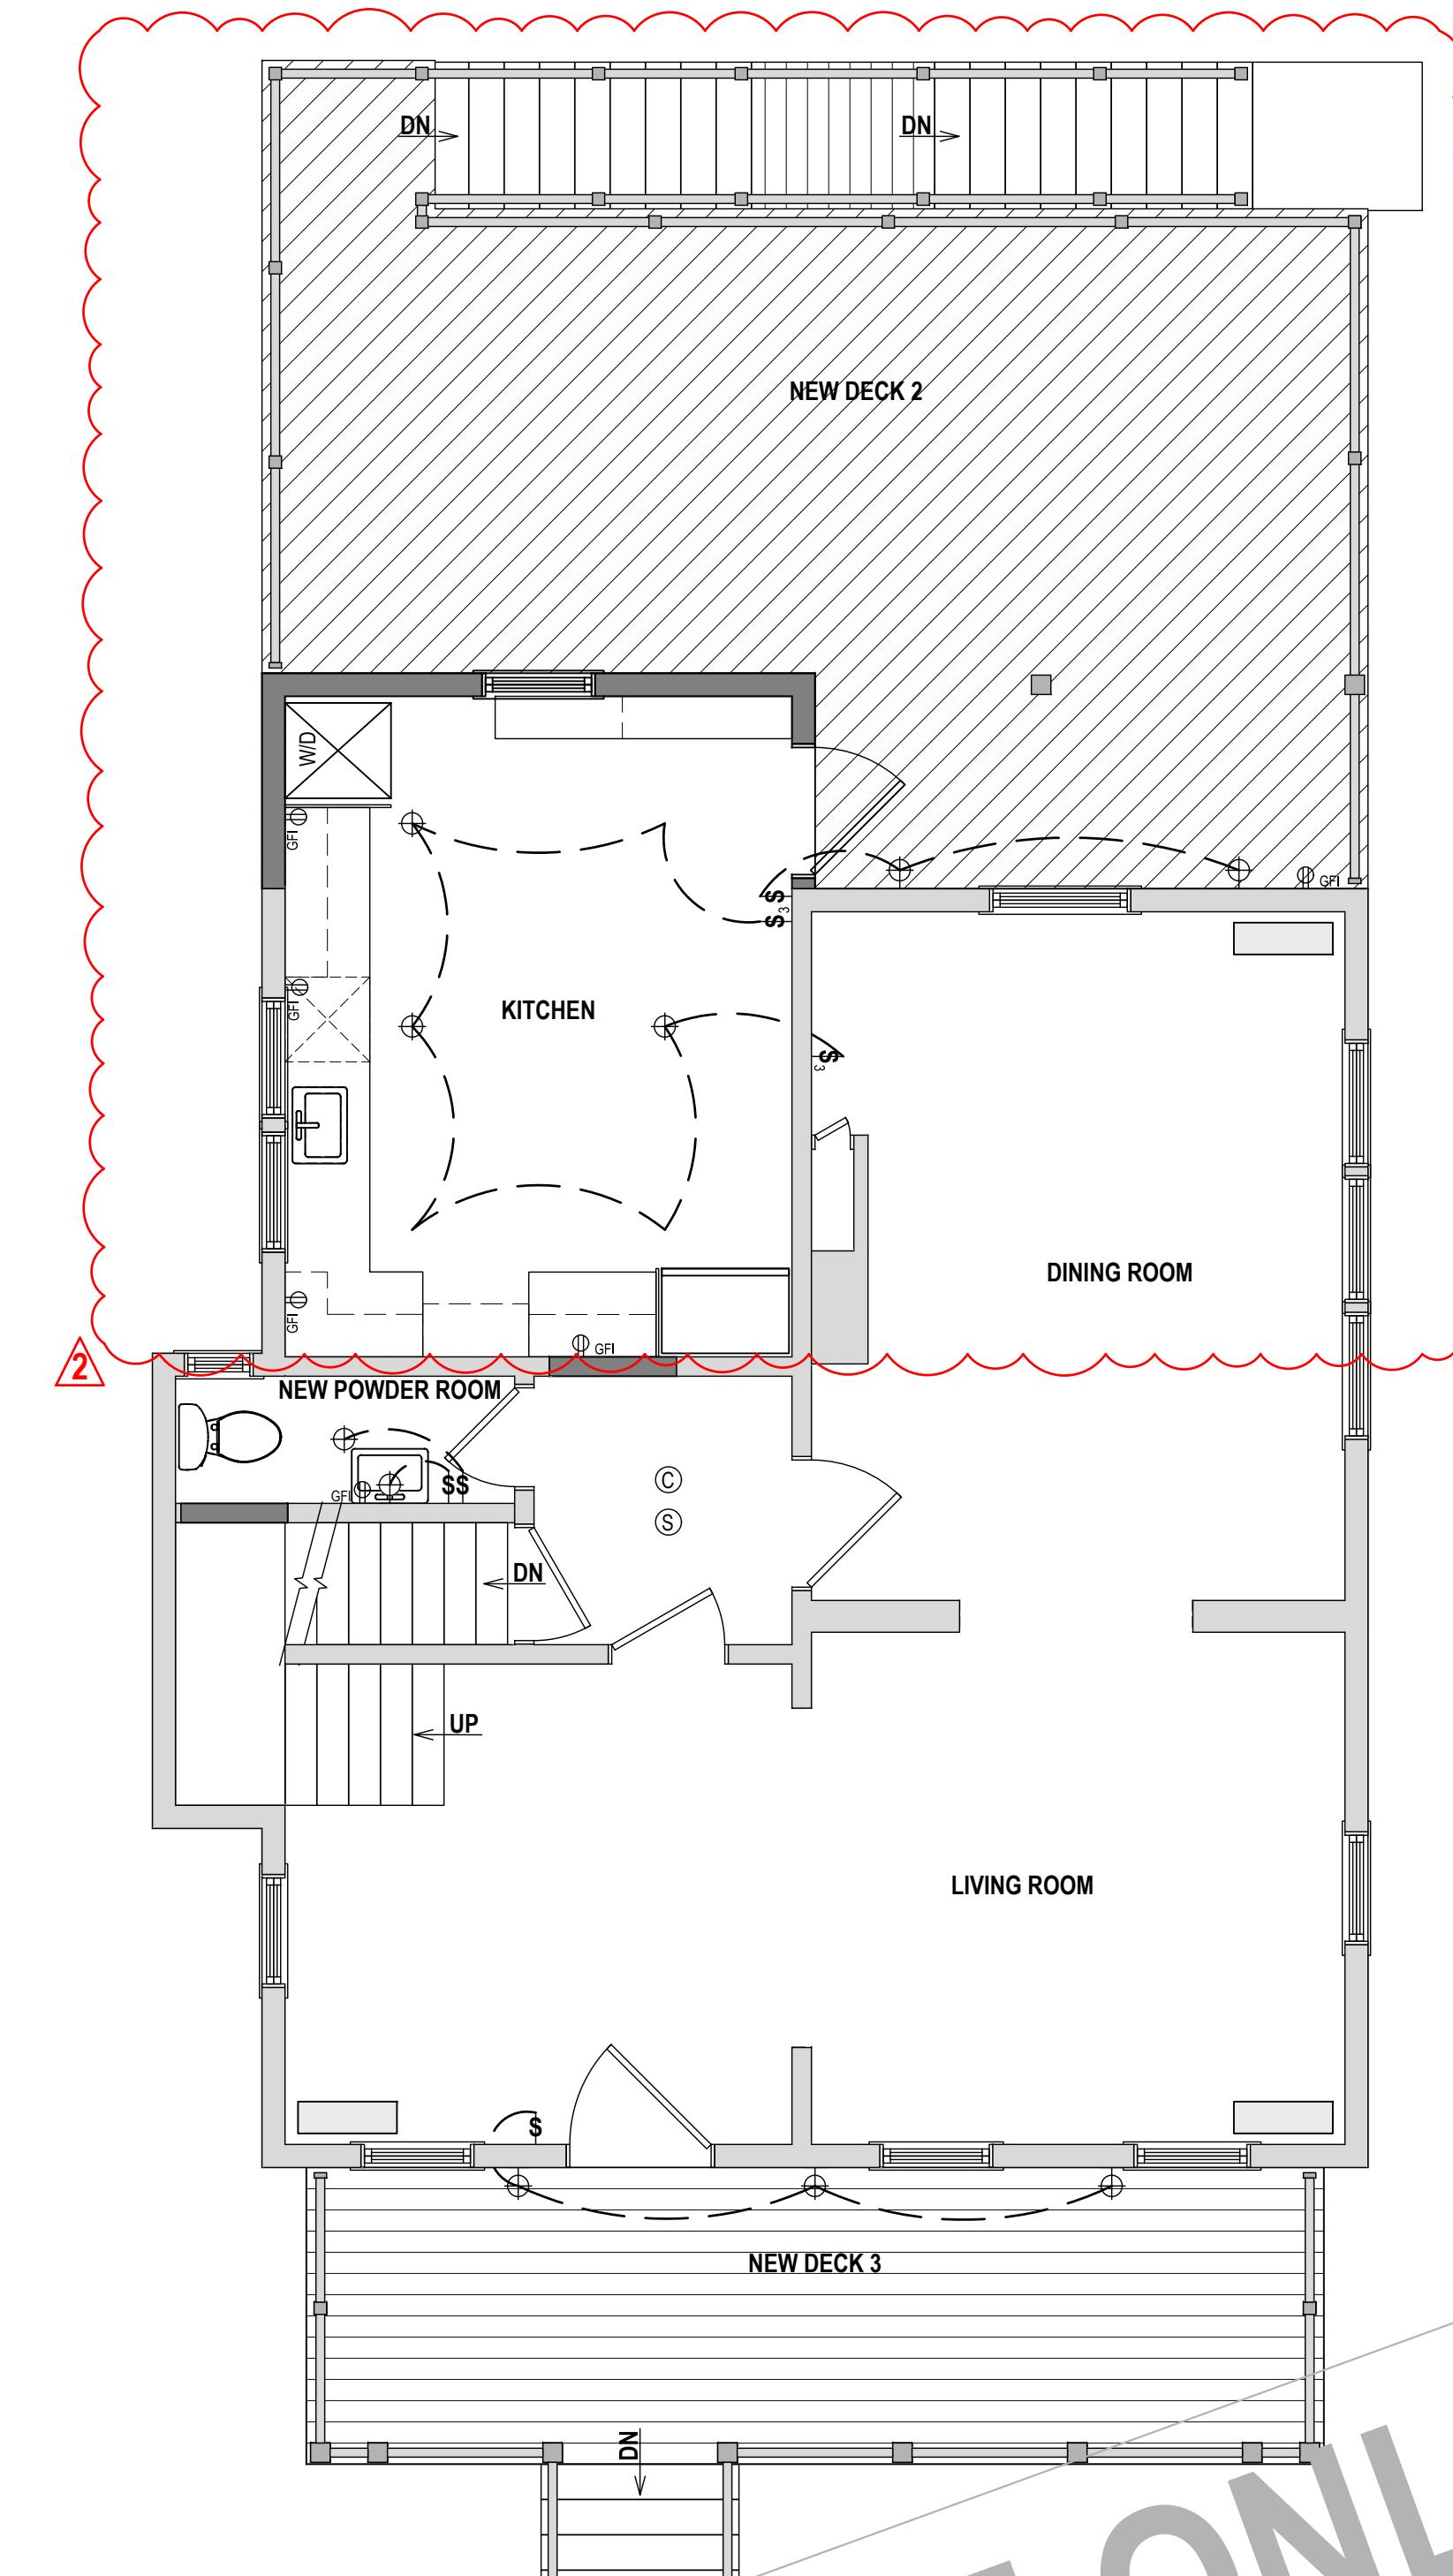
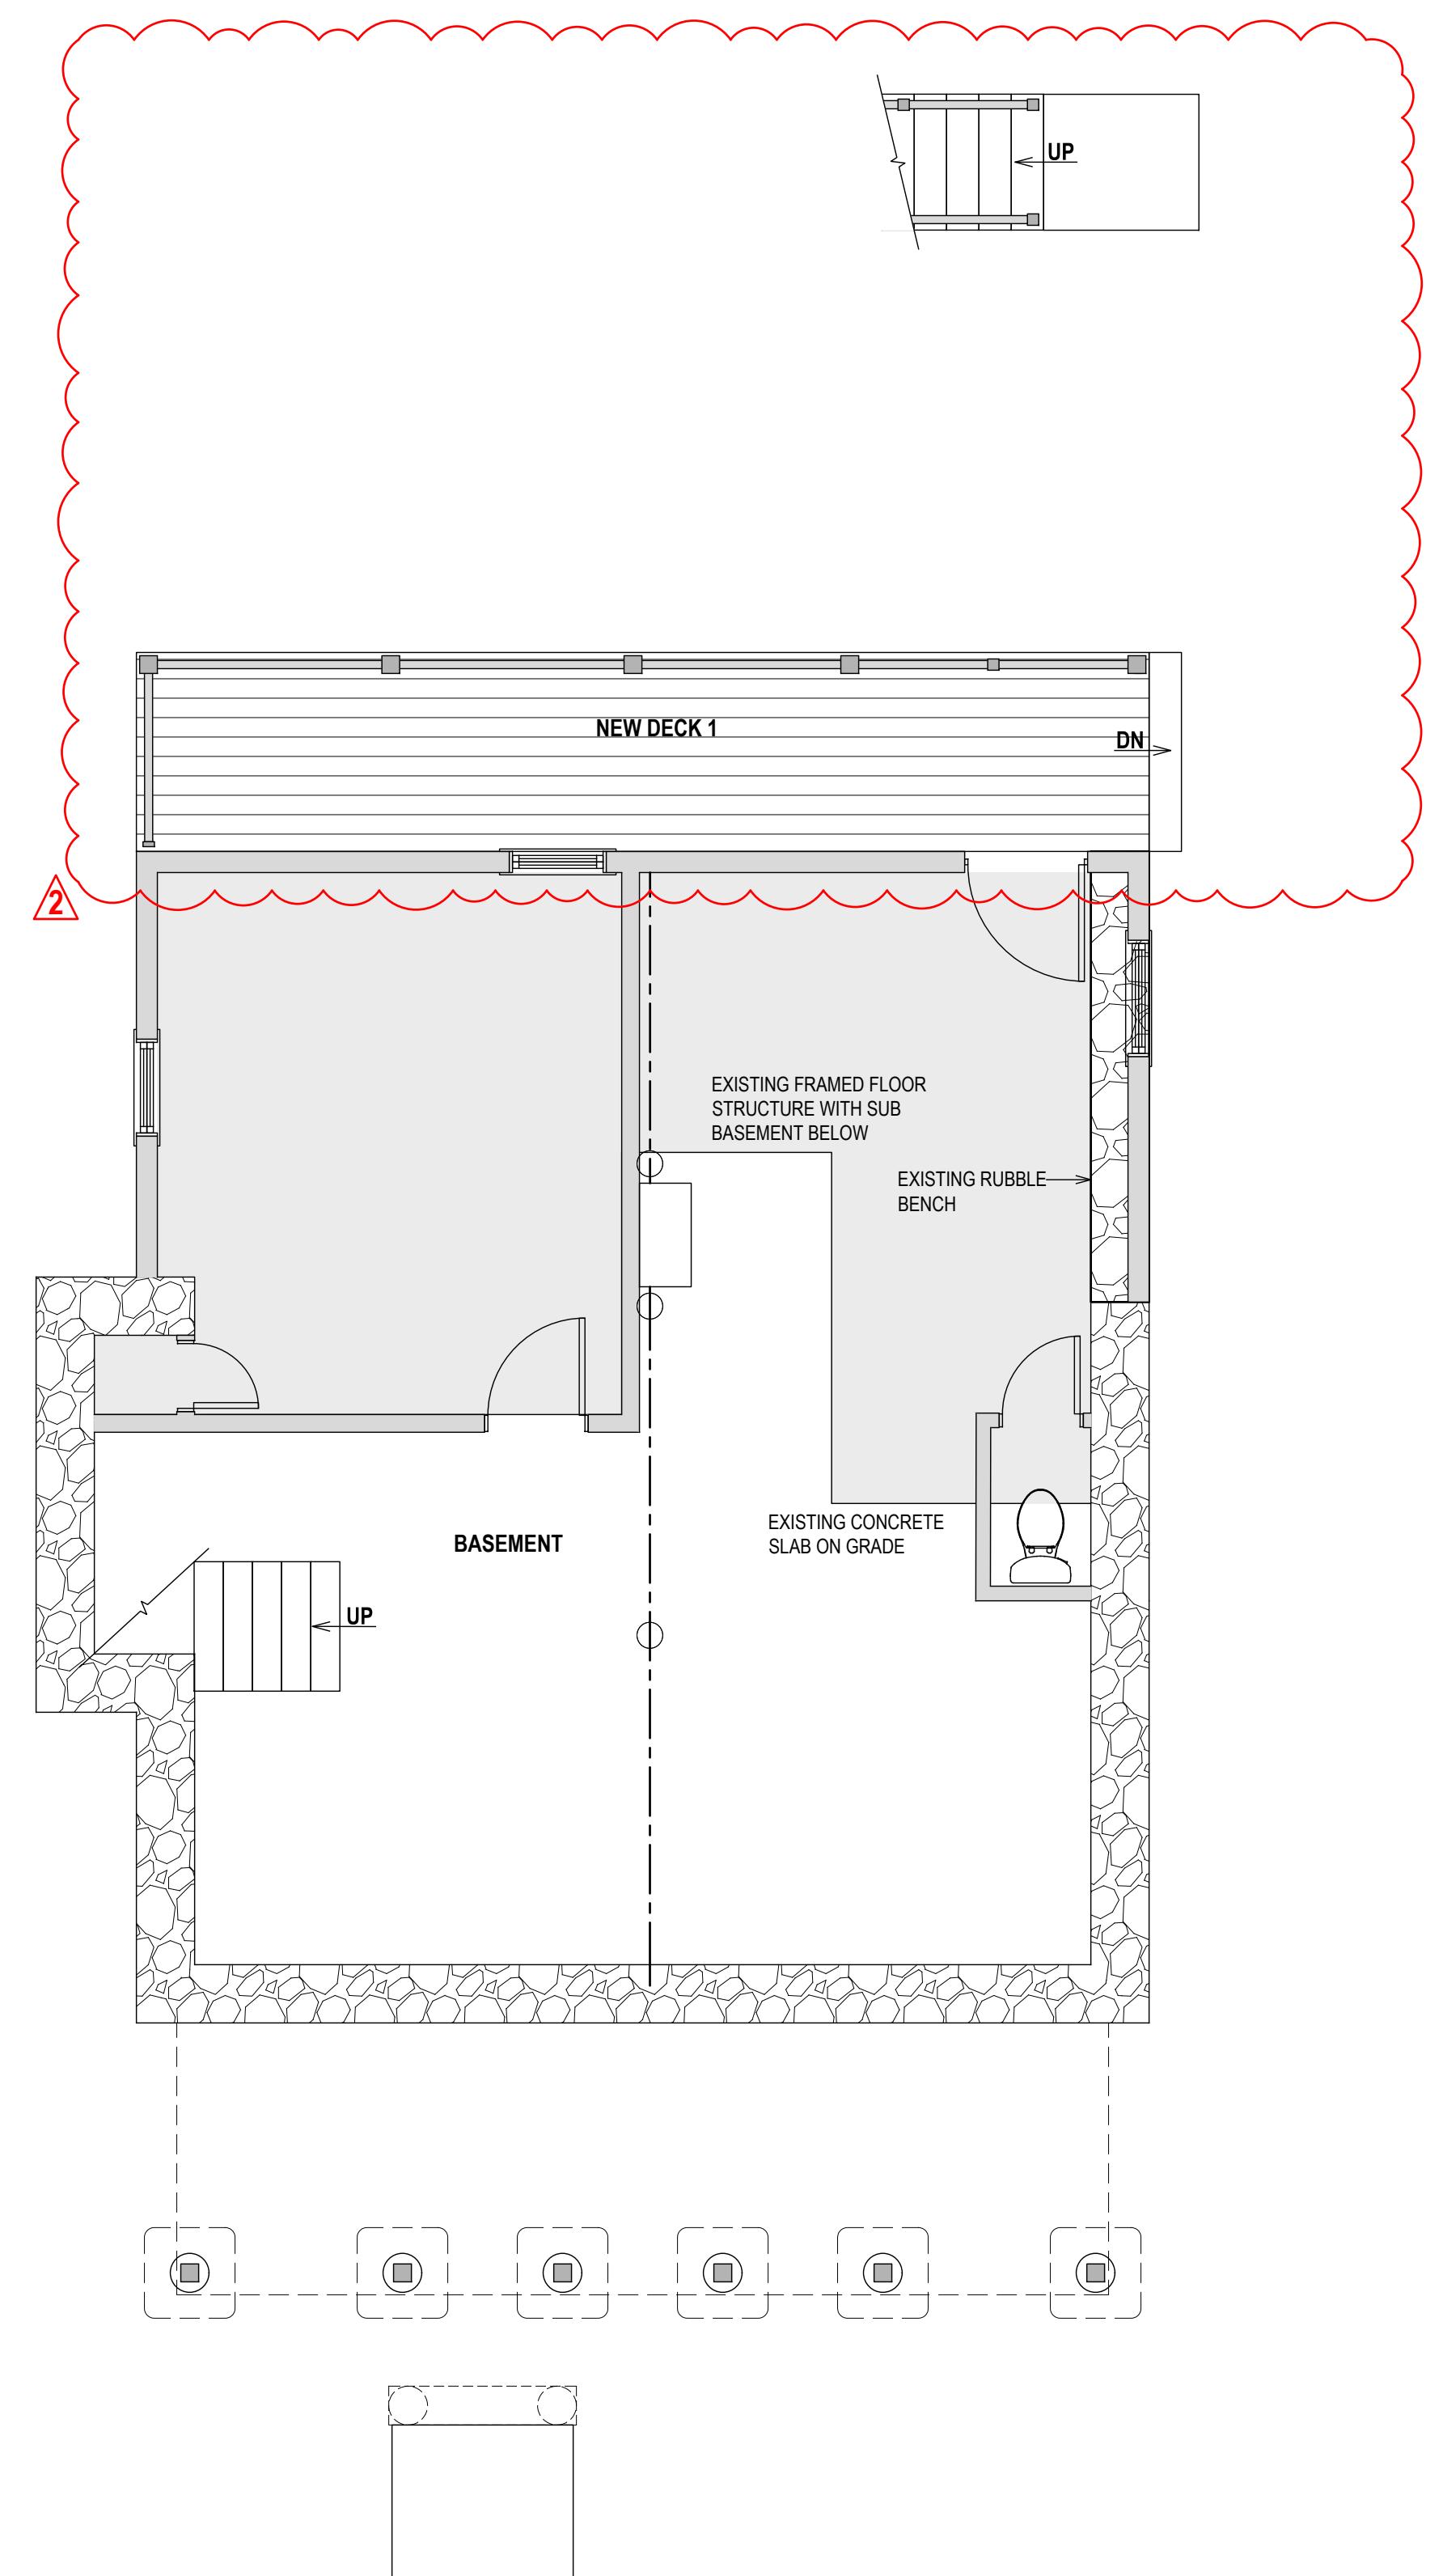


SECTION AT NEW INTERIOR WALL; TYPICAL
 1" = 1'-0"

SECTION AT EXTERIOR WALL; TYPICAL
 1" = 1'-0"

NEW EXTERIOR WALL; TYPICAL
 1" = 1'-0"

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FIRST FLOOR ELECTRICAL PLAN

1/4" = 1'-0"

PROPERTY ADDRESS:

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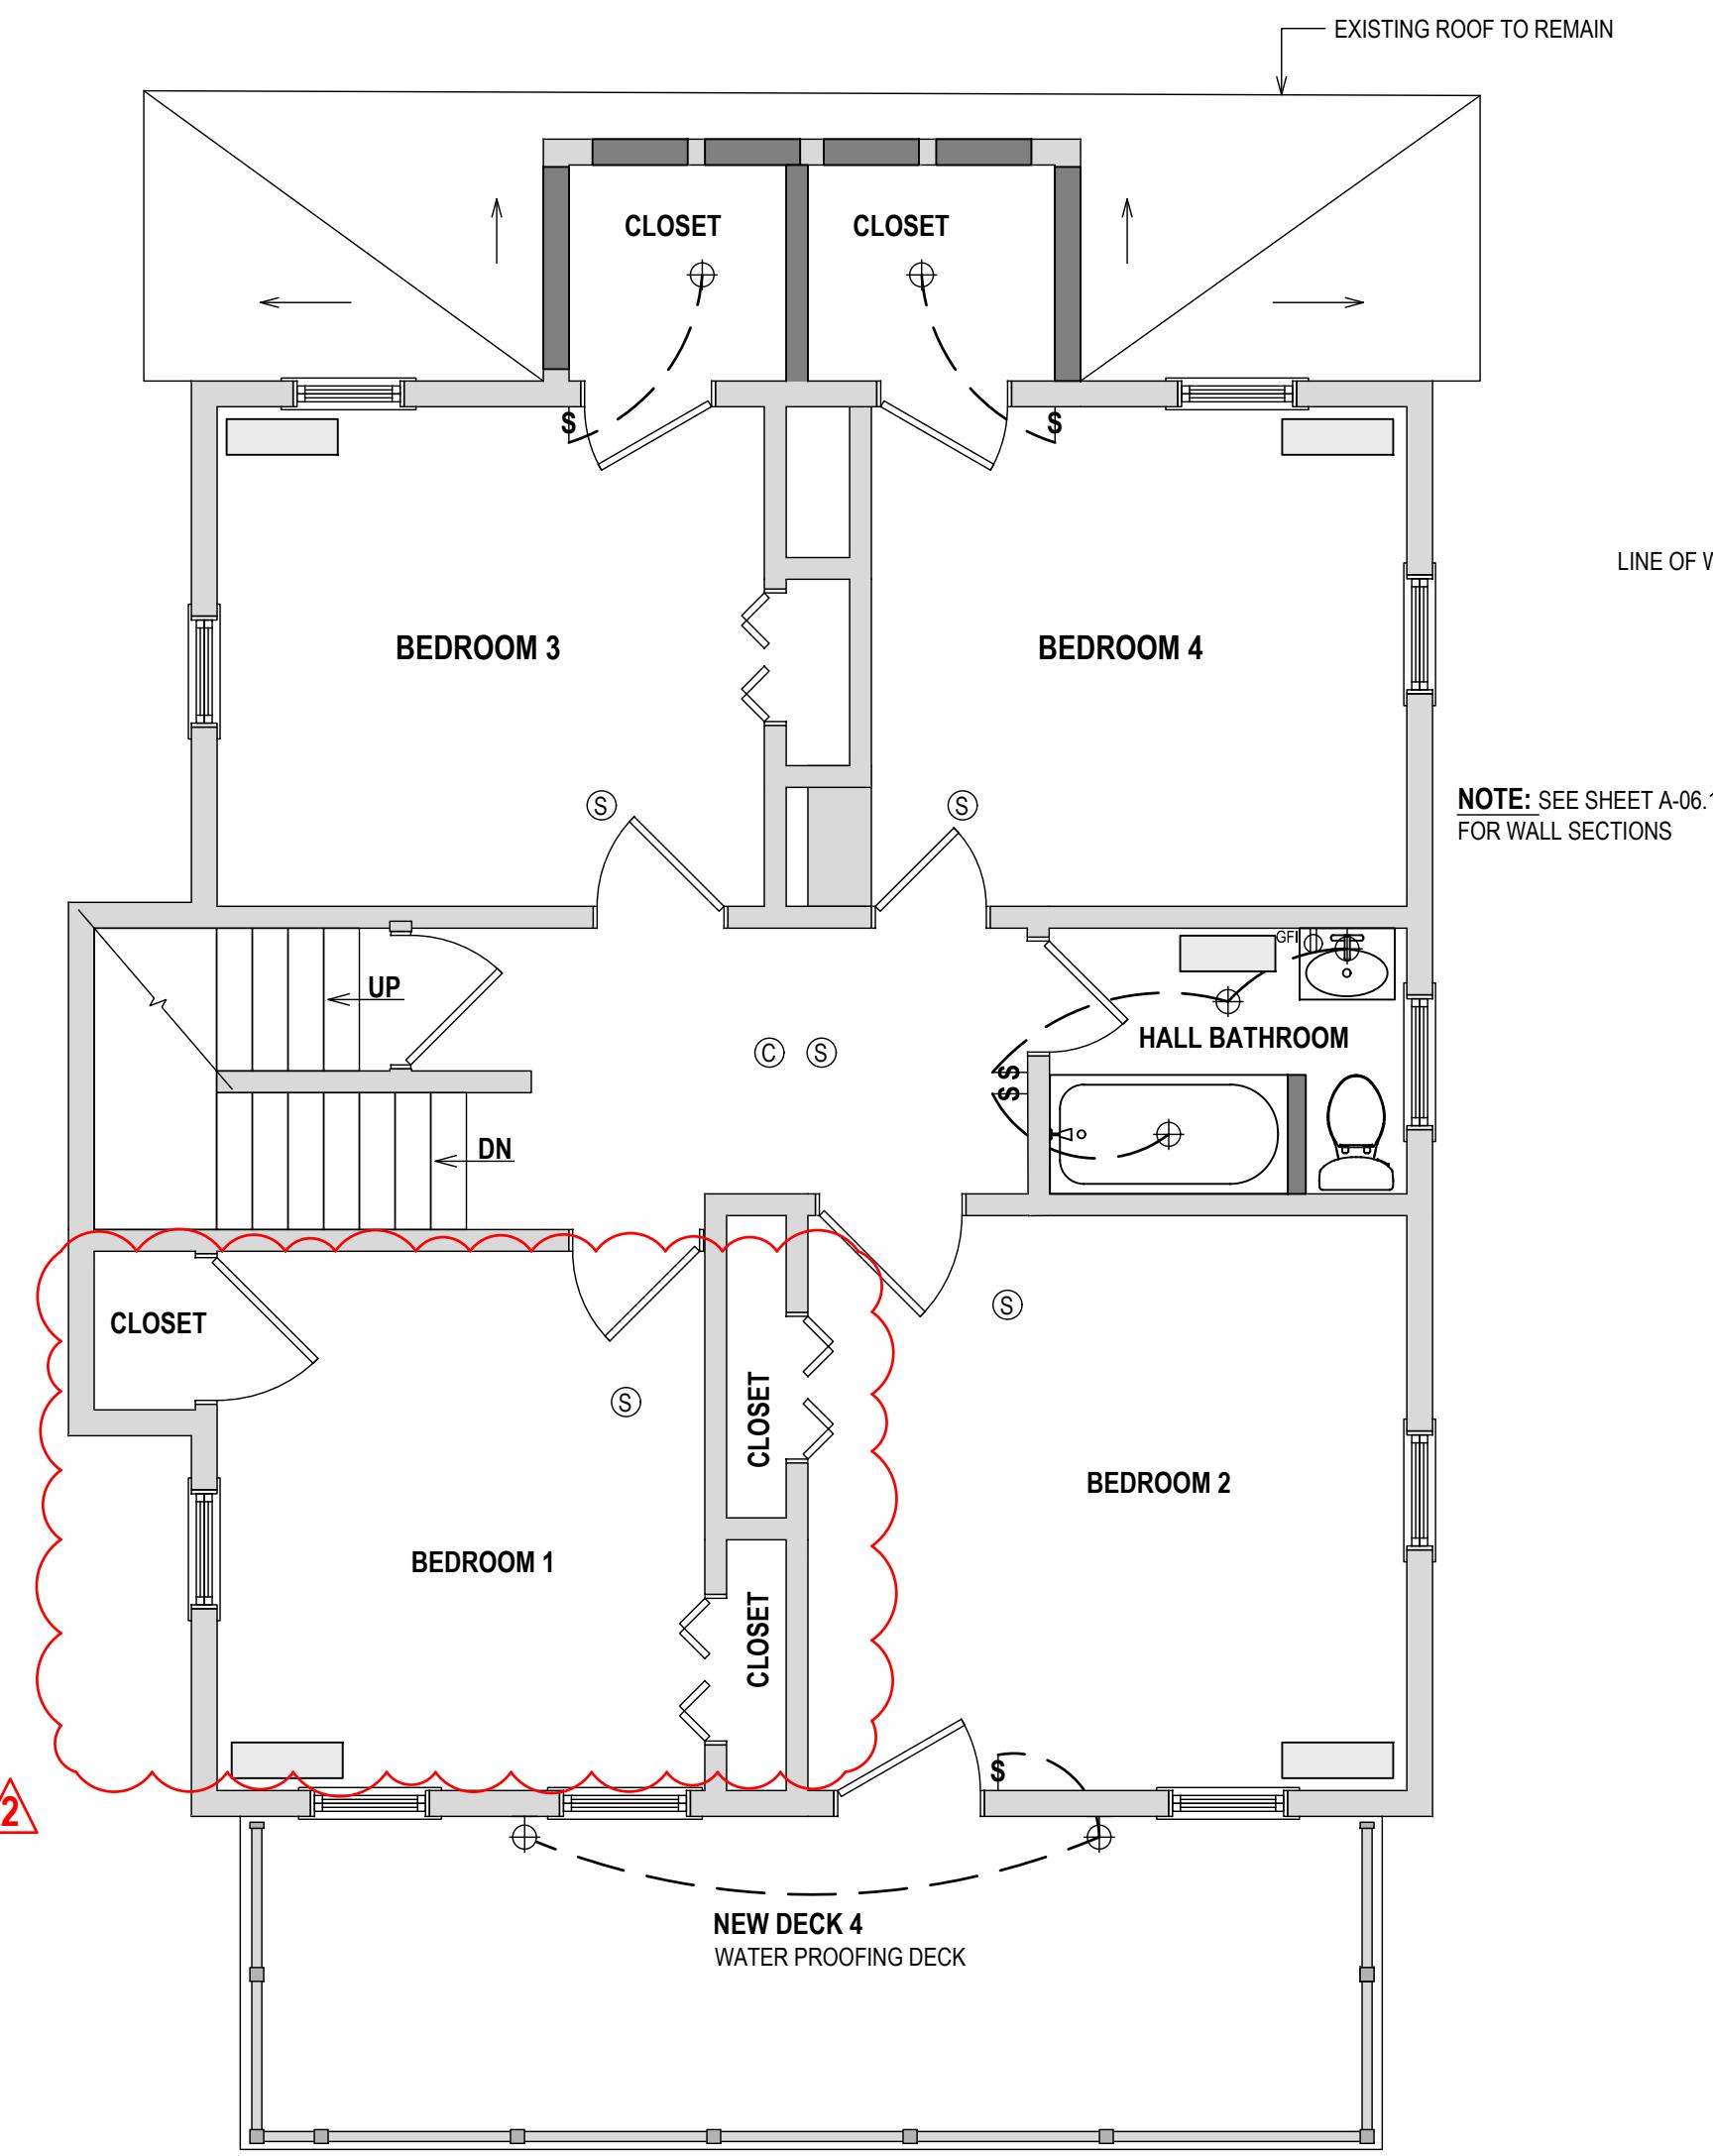
PROJECT NAME:
FLOOR PLAN ALTERATION

DRAWING NAME:
ELECTRICAL 01


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DATE:
05.15.2025
SCALE:
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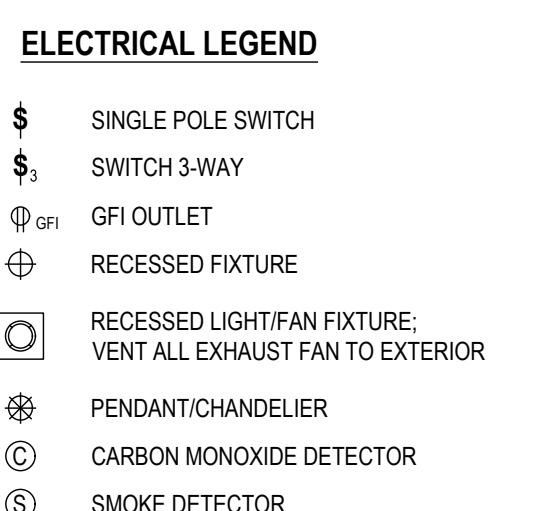
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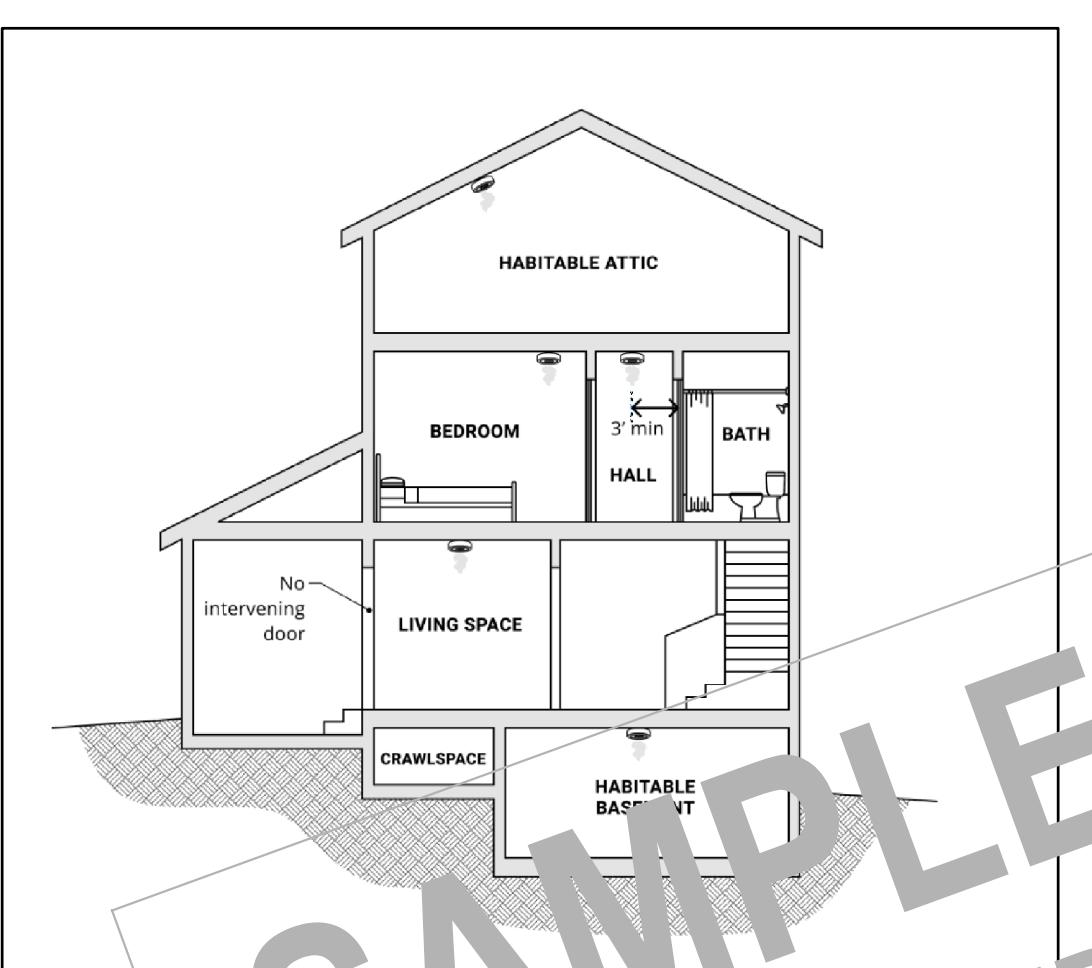
SECOND FLOOR ELECTRICAL PLAN
 $\frac{1}{4}'' = 1'-0''$



ATTIC ELECTRICAL PLAN
 $\frac{1}{4}'' = 1'-0''$



RESIDENTIAL SMOKE ALARMS ARE REQUIRED LOCATIONS
 2020 RESIDENTIAL CODE OF NEW YORK STATE (INTERNATIONAL RESIDENTIAL CODE 2018, VIT, AMENDMENTS)

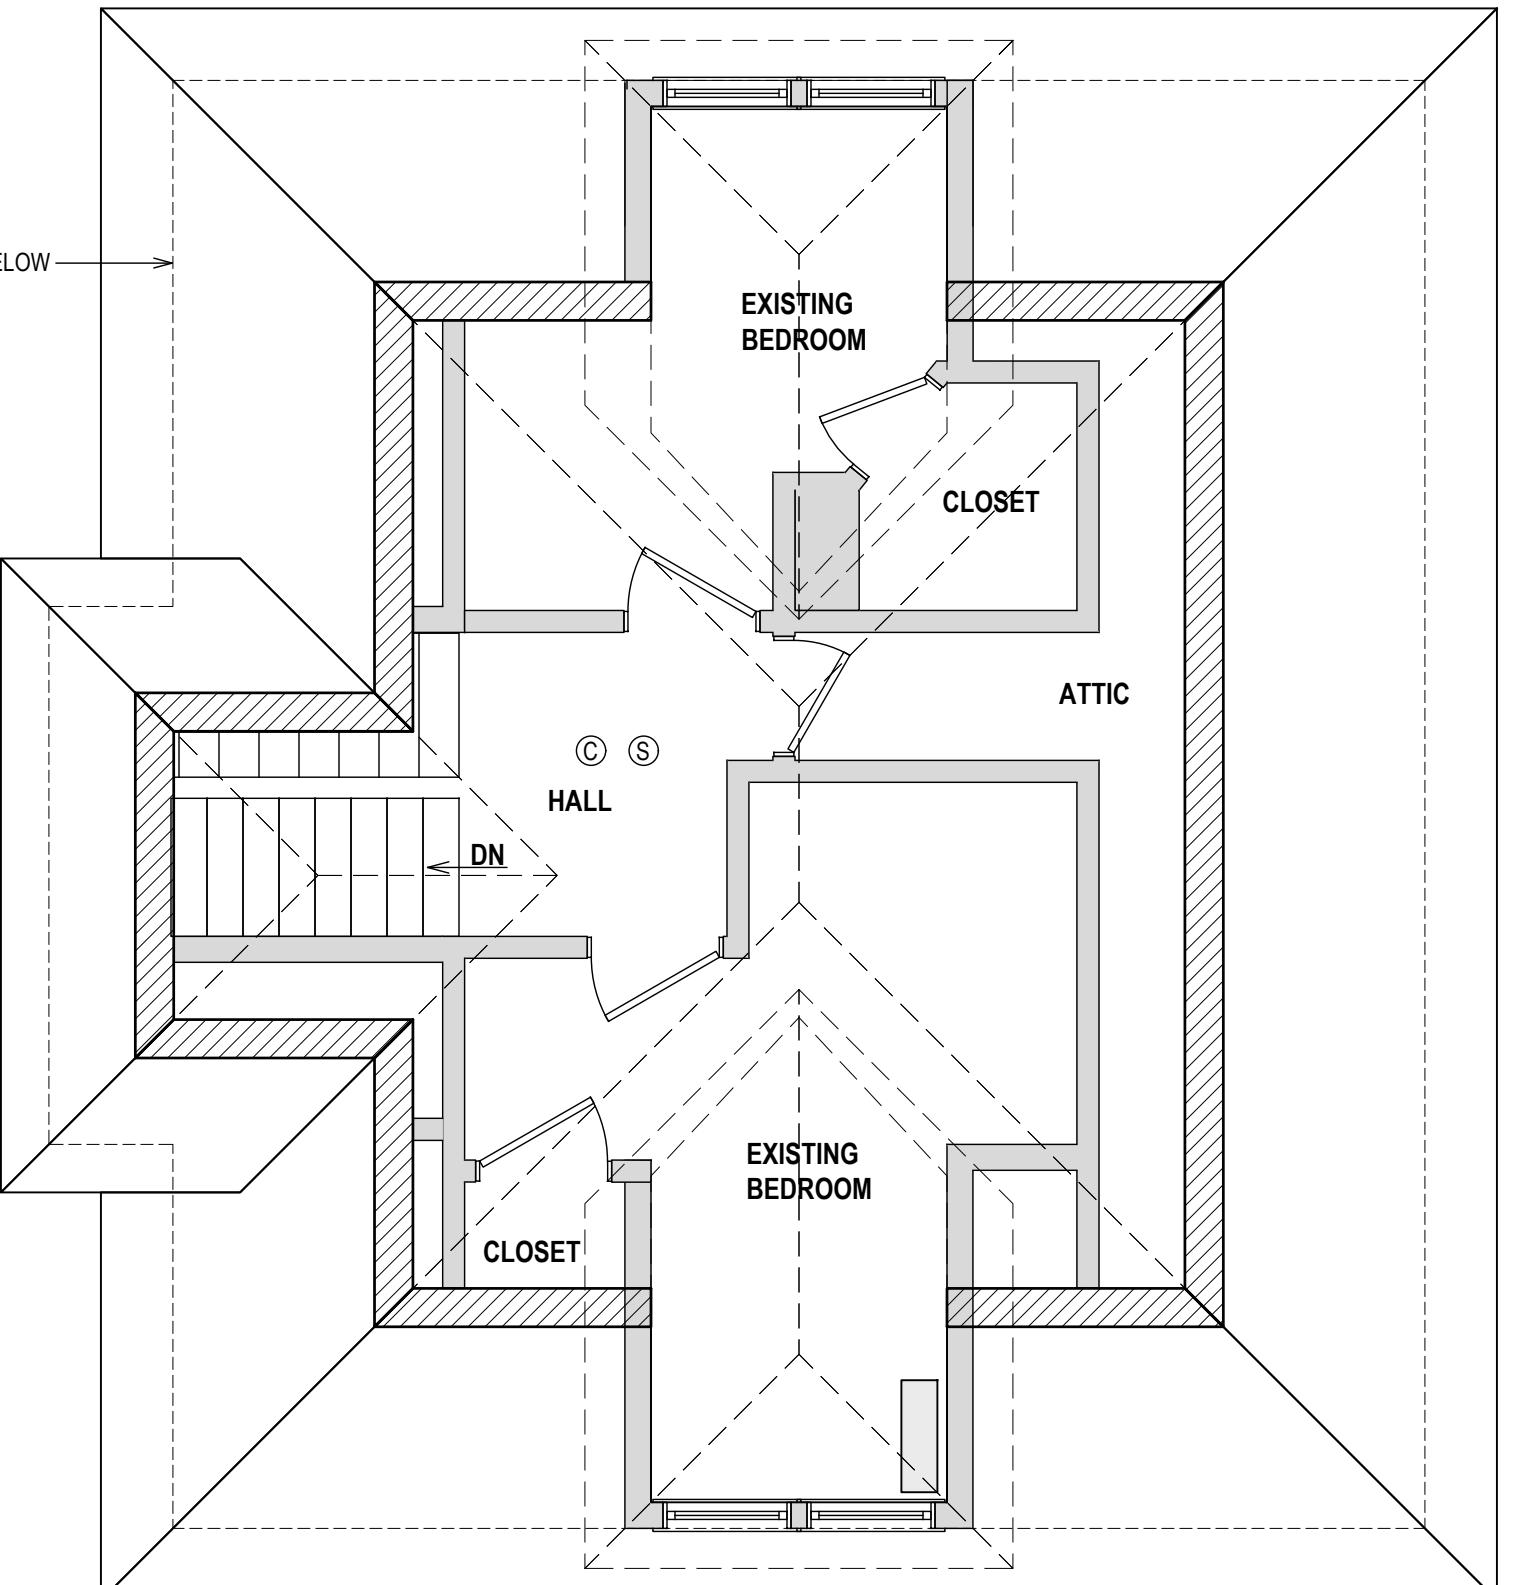

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CARBON MONOXIDE DETECTION:

PER SECTION 915 OF THE 2017 NATIONAL ELECTRICAL CODE (NFPA 70-2017), CARBON MONOXIDE DETECTION SHALL BE INSTALLED IN ALL ROOMS, OCCUPYLBE SPACE, DWELLING UNITS, SLEEPING AREAS, AND SLEEPING UNITS THAT CONTAIN A FUEL-BURNING APPLIANCE.

EXCEPTIONS:

1. IN SLEEPING AREAS AND SLEEPING UNITS WHERE A FUEL BURNING APPLIANCE IS LOCATED IN AN ATTACHED BATHROOM, UTILITY ROOM, CLOSET, OR SPACE, A CARBON MONOXIDE DETECTOR SHALL BE INSTALLED IN A CENTRAL OR OTHERWISE APPROVED LOCATION IN THE SLEEPING AREA OR SLEEPING UNIT.
2. IN DWELLING UNITS AND SLEEPING UNITS WHERE A FUEL BURNING APPLIANCE IS LOCATED IN A KITCHEN OR KITCHENETTE, A CARBON MONOXIDE DETECTOR SHALL BE INSTALLED OUTSIDE OF THE SLEEPING AREAS AND WITHIN 10 FEET OF THE ENTRANCE TO THE SLEEPING AREAS.

CARBON MONOXIDE DETECTION SHALL BE INSTALLED OUTSIDE OF SLEEPING AREAS AND WITHIN 10 FEET OF THE ENTRANCE TO THE SLEEPING AREAS IN DWELLING UNITS AND SLEEPING UNITS THAT CONTAIN A FUEL-BURNING APPLIANCE.

INTERCONNECTION OF CARBON MONOXIDE DETECTORS:

WHEN MORE THAN ONE CARBON MONOXIDE ALARM IS INSTALLED IN A DWELLING UNIT, SLEEPING UNIT, SLEEPING AREA, OCCUPYLBE SPACE, OR HVAC ZONE, ALL SUCH ALARMS SHALL BE INTERCONNECTED IN SUCH A MANNER THAT THE ACTIVATION OF ONE ALARM OR DETECTOR SHALL ACTIVATE ALL CARBON MONOXIDE NOTIFICATION APPLIANCES THROUGHOUT THE INDIVIDUAL DWELLING UNIT, SLEEPING UNIT, SLEEPING AREA, OCCUPYLBE SPACE, OR HVAC ZONE.

EXCEPTION:

CARBON MONOXIDE ALARMS POWERED BY A 10-YEAR BATTERY SHALL BE ALLOWED AND INTERCONNECTION OF ALARMS SHALL NOT BE REQUIRED IN WORK AREAS WHERE THE ALTERATION DOES NOT RESULT IN THE REMOVAL OR EXPOSURE OF INTERIOR WALL OR CEILING FINISHES THAT REVEAL THE STRUCTURE, UNLESS THERE IS AN ATTIC, CRAWL SPACE, BASEMENT, OR SIMILAR SPACE AVAILABLE THAT COULD PROVIDE ACCESS FOR POWER AND INTERCONNECTION WITHOUT THE REMOVAL OF SUCH INTERIOR FINISHES.

SMOKE ALARMS AND HEAT DETECTION:

WHEN INTERIOR ALTERATIONS OCCUR, THE INDIVIDUAL DWELLING UNIT SHALL BE PROVIDED WITH SMOKE ALARMS LOCATED AS REQUIRED FOR NEW DWELLINGS.

SMOKE ALARMS AND HEAT DETECTION SHALL COMPLY WITH NFPA 72 AND SECTION R314 OF THE 2020 RESIDENTIAL CODE OF NEW YORK STATE (INTERNATIONAL RESIDENTIAL CODE 2018 WITH AMENDMENTS).

SMOKE ALARMS SHALL BE PROVIDED IN DWELLING UNITS; HEAT DETECTION SHALL BE PROVIDED IN NEW ATTACHED GARAGES.

SMOKE ALARM LOCATIONS:

1. IN EACH SLEEPING ROOM.
 2. OUTSIDE EACH SEPARATE SLEEPING AREA IN THE IMMEDIATE VICINITY OF THE BEDROOMS.
 3. ON EACH ADDITIONAL STORY OF THE DWELLING, INCLUDING BASEMENTS AND HABITABLE ATTICS AND NOT INCLUDING CRAWL SPACES AND UNINHABITABLE ATTICS. IN DWELLINGS OR DWELLING UNITS WITH SPLIT LEVELS AND WITHOUT AN INTERVENING DOOR BETWEEN THE ADJACENT LEVELS, A SMOKE ALARM INSTALLED ON THE UPPER LEVEL SHALL SUFFICE FOR THE ADJACENT LOWER LEVEL PROVIDED THAT THE LOWER LEVEL IS LESS THAN ONE FULL STORY BELOW THE UPPER LEVEL.
 4. SMOKE ALARMS SHALL BE INSTALLED NOT LESS THAN 3 FEET HORIZONTALLY FROM THE DOOR OR OPENING OF A BATHROOM THAT CONTAINS A BATHTUB OR SHOWER UNLESS THIS WOULD PREVENT PLACEMENT OF A SMOKE ALARM REQUIRED BY THIS SECTION.
- SMOKE ALARM INSTALLATION EXCEPTIONS APPLY IN REGARD TO COOKING EQUIPMENT - SEE DRAWING, THIS PAGE.

INTERCONNECTION OF SMOKE ALARMS:

WHERE MORE THAN ONE SMOKE ALARM IS REQUIRED TO BE INSTALLED WITHIN AN INDIVIDUAL DWELLING UNIT IN ACCORDANCE WITH SECTION R314.3, THE ALARM DEVICES SHALL BE INTERCONNECTED IN SUCH A MANNER THAT THE ACTUATION OF ONE ALARM WILL ACTIVATE ALL OF THE ALARMS IN THE INDIVIDUAL DWELLING UNIT.

PHYSICAL INTERCONNECTION OF SMOKE ALARMS SHALL NOT BE REQUIRED WHERE LISTED. WIRELESS ALARMS ARE INSTALLED AND ALL ALARMS SOUND UPON ACTIVATION OF ONE ALARM.

EXCEPTIONS:

SMOKE ALARMS IN EXISTING AREAS SHALL NOT BE REQUIRED TO BE INTERCONNECTED AND HARD WIRED WHERE INTERIOR WALL OR CEILING FINISHES ARE NOT REMOVED TO EXPOSE THE STRUCTURE.

SMOKE ALARMS ARE NOT TO BE INSTALLED WITHIN 3 FEET OF A BATHROOM.

COMBINATION SMOKE AND CARBON MONOXIDE ALARMS SHALL BE PERMITTED TO BE USED IN LIEU OF SMOKE ALARMS.

ELECTRICAL:

1. ALL ELECTRICAL WORK IS TO BE PERFORMED BY AN ELECTRICAL CONTRACTOR LICENSED TO WORK IN THE VILLAGE OF PORT CHESTER.

2. ALL ELECTRICAL WORK, WIRING AND EQUIPMENT SHALL CONFORM TO THE 2017 NATIONAL ELECTRICAL CODE (NFPA 70-2017) AND ALL OTHER REGULATING AGENCIES.

3. THE ELECTRICAL CONTRACTOR SHALL SUPPLY ALL REQUIRED WIRING, DEVICES, CIRCUIT BREAKERS AND OTHER MATERIALS AS REQUIRED BY CODE.

4. UNLESS STIPULATED OTHERWISE, ALL LIGHT FIXTURES AND LAMPS TO BE SUPPLIED AND INSTALLED BY THE ELECTRICIAN; ALL NEW LIGHT FIXTURES TO BE LED TYPE.

5. SINGLE AND MULTIPLE-STATION SMOKE DETECTING ALARM DEVICES TO BE HARDWIRED AND INSTALLED TO CONFORM WITH THE BUILDING CODE AS FOLLOWS:

1. ON THE CEILING OR WALL OUTSIDE OF EACH SEPARATE SLEEPING AREA IN THE IMMEDIATE VICINITY OF BEDROOMS.
2. IN EACH ROOM USED FOR SLEEPING PURPOSES.

6. CARBON MONOXIDE ALARMS AND CARBON MONOXIDE DETECTION SHALL BE INSTALLED IN NEW AND EXISTING BUILDINGS IN ACCORDANCE WITH SECTION 915 OF THE FIRE CODE OF THE STATE OF NEW YORK.

7. PROVIDE GFCI OUTLETS IN KITCHEN PER CODE.

8. PROVIDE DEDICATED APPLIANCE (REFRIGERATOR AND DISHWASHER) OUTLETS PER CODE AND PER MANUFACTURER'S INSTRUCTIONS.

9. PROVIDE ARC FAULT PROTECTED OUTLETS IN BEDROOM PER CODE.

10. PROVIDE UNDER-CABINET LIGHTING PER OWNER AND DESIGNER'S REQUIREMENTS.

BATHROOM BRANCH CIRCUITS & GROUND FAULT INTERRUPTERS:

A MINIMUM OF 20-AMPERE BRANCH CIRCUIT SHALL BE PROVIDED TO SUPPLY BATHROOM RECEPTACLE OUTLET(S), SUCH CIRCUITS SHALL HAVE NO OTHER OUTLETS.

EXCEPTION: WHERE THE 20-AMPERE CIRCUIT SUPPLIES A SINGLE BATHROOM, OUTLETS FOR OTHER EQUIPMENT WITHIN THE SAME BATHROOM SHALL BE PERMITTED TO BE SUPPLIED IN ACCORDANCE WITH SECTION E3702. [210.11(C)(3) EXCEPTION]

AT LEAST ONE RECEPTACLE OUTLET SHALL BE INSTALLED IN BATHROOMS AND SUCH OUTLET SHALL BE LOCATED WITHIN 36" OF THE OUTSIDE EDGE OF EACH LAVATORY BASIN. THE RECEPTACLE OUTLET SHALL BE LOCATED ON A WALL OR PARTITION THAT IS ADJACENT TO THE LAVATORY BASIN LOCATION, LOCATED ON THE COUNTERTOP, OR INSTALLED ON THE SIDE OR FACE OF THE BASIN CABINET. THE RECEPTACLE SHALL BE LOCATED NOT MORE THAN 12" BELOW THE TOP OF THE BASIN OR BASIN COUNTERTOP.

125-VOLT, SINGLE-PHASE, 15- AND 20-AMPERE RECEPTACLES INSTALLED IN BATHROOMS SHALL HAVE GROUND-FAULT CIRCUIT-INTERRUPTER PROTECTION FOR PERSONNEL. [210.8(A)(1)]

BATHTUB OR SHOWER STALL RECEPTACLES: 125-VOLT, SINGLE-PHASE, 15- AND 20-AMPERE RECEPTACLES THAT ARE LOCATED WITHIN 6 FEET OF THE OUTSIDE EDGE OF A BATHTUB OR SHOWER STALL SHALL HAVE GROUND-FAULT CIRCUIT-INTERRUPTER PROTECTION FOR PERSONNEL. [210.8(A)(8)]

CEILING (ELECTRICAL) PENETRATIONS: PENETRATIONS OF MEMBRANES THAT ARE PART OF A HORIZONTAL ASSEMBLY SHALL COMPLY WITH SECTION 714.5.1.1 OR 714.5.1.2, WHERE FLOOR/CEILING ASSEMBLIES ARE REQUIRED TO HAVE A FIRE-RESISTANCE RATING, RECESSED FIXTURES SHALL BE INSTALLED SUCH THAT THE REQUIRED FIRE RESISTANCE WILL NOT BE REDUCED.

EXCEPTIONS: CEILING MEMBRANE PENETRATIONS OF MAXIMUM 2-HOUR HORIZONTAL ASSEMBLIES BY STEEL ELECTRICAL BOXES THAT DO NOT EXCEED 16 SQUARE INCHES IN AREA, PROVIDED THAT THE AGGREGATE AREA OF SUCH PENETRATIONS DOES NOT EXCEED 100 SQUARE INCHES IN ANY 100 SQUARE FEET OF CEILING AREA, AND THE ANNUAL SPACE BETWEEN THE CEILING MEMBRANE AND THE BOX DOES NOT EXCEED $\frac{1}{8}$ INCH.

PROJECT NAME:
FLOOR PLAN ALTERATION

DRAWING NAME:
ELECTRICAL 02

DRAWING NUMBER:
E-02

DATE:
05.15.2025
 ISSUE:
PRELIMINARY
 07.23.2025
 08.15.2025
FOR PERMIT

DATE:
12.04.2025
AMENDMENT

NOTE:
 THIS DRAWING IS VALID FOR CONSTRUCTION IF (AND ONLY IF) A PERMIT IS ISSUED, BASED ON THIS DRAWING, BY THE VILLAGE OF PORT CHESTER.