

SITE PLAN

BACKGROUND INFORMATION FROM SURVEY BY LALSA LAND SURVEYING PLLC, 03.24.2025
1" = 10'-0"

SITE WORK

EXCAVATION SAFETY:

THE CONTRACTOR SHALL COMPLY WITH THE TRENCHING AND EXCAVATION REQUIREMENTS OF 29 CFR 1926.651 AND 1926.652 OR COMPARABLE OSHA-APPROVED STATE PLAN REQUIREMENTS. TRENCHES 5 FEET DEEP OR GREATER REQUIRE A PROTECTIVE SYSTEM UNLESS THE EXCAVATION IS MADE ENTIRELY IN STABLE ROCK.

THE CONTRACTOR SHALL HAVE A COMPETENT PERSON INSPECT EXCAVATIONS DAILY AND AS CONDITIONS CHANGE TO ENSURE ELIMINATION OF EXCAVATION HAZARDS.

A COMPETENT PERSON IS AN INDIVIDUAL WHO IS CAPABLE OF IDENTIFYING EXISTING AND PREDICTABLE HAZARDS OR WORKING CONDITIONS THAT ARE HAZARDOUS, UNSANITARY, OR DANGEROUS TO WORKERS, SOIL TYPES AND PROTECTIVE SYSTEMS REQUIRED, AND WHO IS AUTHORIZED TO TAKE PROMPT CORRECTIVE MEASURES TO ELIMINATE THESE HAZARDS AND CONDITIONS.

EXCAVATION - LOCATING UTILITIES - CALL 811:

NEW YORK STATE LAW (16 NYCRR PART 753) REQUIRES ALL EXCAVATORS TO PLACE A LOCATION REQUEST WITH DIG SAFELY NEW YORK AT LEAST TWO (2) FULL WORKING DAYS, BUT NO MORE THAN 10 WORKING DAYS BEFORE BEGINNING AN EXCAVATION PROJECT IN ORDER TO ENSURE ALL UNDERGROUND UTILITY LINES ARE PROPERLY MARKED BY THEIR OWNERS.

A LOCATION REQUEST MAY BE PLACED, AND THE PROCESS OF MARKING UNDERGROUND UTILITIES MAY BE TRACKED BY USING THE ONLINE LOCATION REQUEST PROGRAM, EXACTIX. OR, THE EXCAVATOR MAY CALL 811 TO PLACE THE LOCATION REQUEST.

- NOTIFY: NOTIFY 811 ONLINE WITH EXACTIX OR BY CALLING 811.
- WAIT: AT LEAST TWO DAYS FOR UTILITIES TO RESPOND (NOT INC. THE DAY YOU CALL).
- CONFIRM: CHECK ALL UTILITIES HAVE RESPONDED.
- RESPECT: ADHERE TO UTILITY MARKS AND FLAGS.
- DIG W/CAUTION: DIG CAREFULLY AROUND BURIED UTILITIES.

NOTE:
THE VILLAGE OF PORT CHESTER MAY REQUIRE THE CONTRACTOR TO PROVIDE A "DIG SAFELY" CODE 753 CASE NUMBER.

EROSION CONTROL:


THE NEW YORK STATE DEPARTMENT OF ENVIRONMENTAL CONSERVATION (NYS DEC) PROVIDES MINIMUM STANDARDS AND SPECIFICATIONS FOR THE CONTROL OF STORMWATER DISCHARGES ASSOCIATED WITH CONSTRUCTION ACTIVITY. EROSION CONTROL SHALL BE PROVIDED IN ACCORDANCE WITH THE NEW YORK STATE STANDARDS AND SPECIFICATIONS FOR EROSION AND SEDIMENT CONTROL, WITH ALL RELEVANT REGULATIONS OF THE VILLAGE OF PORT CHESTER AND AS FOLLOWS:

THE SILT FENCE SHALL BE INSTALLED BEFORE UP-SLOPE GROUND COVER IS REMOVED. FENCE SHALL BE PLACED ON THE FLATTEST AREA AVAILABLE; A RUN OF SILT FENCE SHOULD FOLLOW THE CONTOUR AS CLOSELY AS POSSIBLE WITH THE ENDS TURNED UPSLOPE TO POND WATER BEHIND THE FENCE.

THE SILT FENCE FABRIC SHOULD BE BURIED AT LEAST 6" DEEP AND HAVE A TOTAL OF 8" (MINIMUM) FABRIC BELOW THE GROUND.

STAKES SHALL BE A MINIMUM OF 2X2 NOMINAL (1 1/2" X 1 1/2" ACTUAL) HARDWOOD AND OF SOUND QUALITY. THE STAKES SHALL BE PLACED ON THE DOWN-SLOPE SIDE OF THE GEOTEXTILE AND AT A MAXIMUM SPACING OF 8'-0" ON CENTER.

THE APPLICANT AND/OR CONTRACTOR SHALL ESTABLISH EROSION CONTROL AS NOTED IN THESE DRAWINGS AND SHALL MAINTAIN EROSION CONTROL MEASURES THROUGHOUT CONSTRUCTION UNTIL SUCH TIME THAT THE BUILDING INSPECTOR DEEMS THE LAND TO BE STABLE.

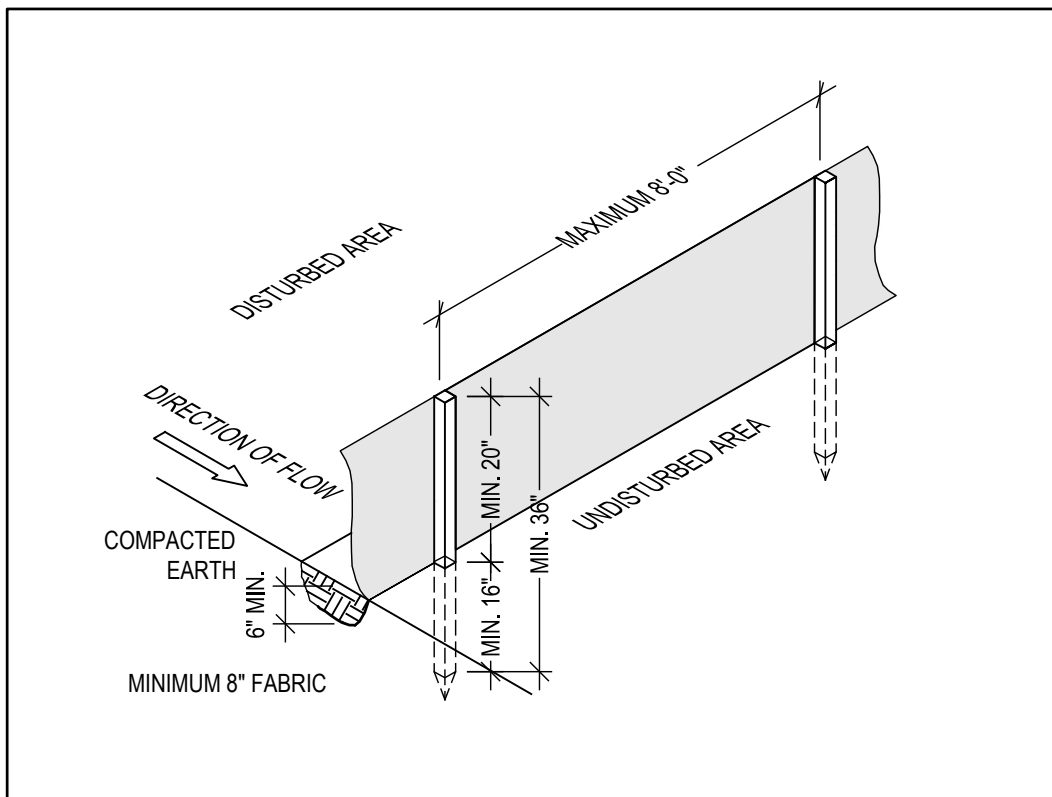

SEDIMENT FENCE DETAIL

NOT TO SCALE

LOT AREA AND IMPERVIOUS COVERAGE				
	LOT AREA COVERAGE		IMPERVIOUS COVERAGE	
	EXISTING	PROPOSED	EXISTING	PROPOSED
HOUSE FOOTPRINT	825.6 +/-	825.6 +/-	825.6 +/-	825.6 +/-
DETACHED GARAGE	387.9 +/-	387.9 +/-	387.9 +/-	387.9 +/-
FRONT PORCH/DECK			120 +/-	168 +/-
FRONT STEPS			30.3 +/-	31.89 +/-
FRONT WALKWAY			66.26 +/-	62.44 +/-
REAR PORCH/DECK			134.8 +/-	431.3 +/-
REAR STEPS				81.6 +/-
FLAGSTONE DRIVEWAY			139.6 +/-	139.6 +/-
TOTAL:	1,213.5 +/-	1,213.5 +/-	1,704.46 +/-	2,128.3 +/-

ZONING COMPLIANCE					
ADDRESS:	30 SUMMER STREET	ZONE:	RS ONE-FAMILY RESIDENCE	MUNICIPALITY:	VILLAGE OF PORT CHESTER
			TAXID:	136.70-1-38	
		REQUIRED	EXISTING	PROPOSED	
LOT INFORMATION					
LOT AREA (SF)		5,000.0	6730 +/-	NO CHANGE	
LOT FRONTAGE (FT)		50.0	50.0	NO CHANGE	
YARD SETBACKS (FT):					
FRONT YARD		25.0	34.7	NO CHANGE	
REAR YARD		30.0	70.1 +/-	NO CHANGE	
FIRST SIDE YARD		8.0	12.7	NO CHANGE	
TOTAL OF TWO		14.0	> 14.0	NO CHANGE	
SIDE YARD ADJOINING STREET					
PRINCIPAL BUILDING INFORMATION					
GROSS FLOOR AREA (SF)				NO CHANGE	
BUILDING HEIGHT				NO CHANGE	
STORES				NO CHANGE	
HEIGHT TO PRINCIPAL EAVE (FT)				NO CHANGE	
HEIGHT TO HIGHEST ROOF RIDGE (FT)				NO CHANGE	
BUILDING COVERAGE					
PRINCIPAL BUILDING COVERAGE (SF)			825.6 +/-	NO CHANGE	
PRINCIPAL BUILDING COVERAGE (%)			12.3% +/-	NO CHANGE	
ACCESSORY BUILDING COVERAGE (SF)				NO CHANGE	
ACCESSORY BUILDING COVERAGE (%)				NO CHANGE	
ACCESSORY STRUCTURES					
DETACHED GARAGE					
SETBACKS					
TO PRINCIPAL BUILDING (FT)		10.0	27.6 +/-	NO CHANGE	
TO SIDE LOTLINE (FT)		5.0	5.0	NO CHANGE	
TO REAR LOTLINE (FT)		5.0	23.5	NO CHANGE	
BUILDING HEIGHT:					
HEIGHT TO PRINCIPAL EAVE (FT)				NO CHANGE	
HEIGHT TO HIGHEST ROOF RIDGE (FT)				NO CHANGE	
IMPERVIOUS SURFACE COVERAGE					
IMPERVIOUS SURFACE COVERAGE (SF)			1,704.46 +/-	2,128.3 +/-	
IMPERVIOUS SURFACE COVERAGE (%)					

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PROPERTY ADDRESS:

PORT CHESTER, NY 10573
(VILLAGE OF PORT CHESTER
BUILDING DEPARTMENT)

S-B-L:

CLIENT:

*** **

TEL: ***

EMAIL:

DATE:

05.15.2025

07.23.2025

08.15.2025

12.04.2025

AMENDMENT

AMENDMENT

PROJECT NAME:

FLOOR PLAN ALTERATION

DRAWING NAME:

SITE PLAN

DRAWING NUMBER:

C-02

DATE:

05.15.2025


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AS NOTED


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FOUNDATION PLAN EXISTING AND DEMOLITION
1/4" = 1'-0"



FIRST FLOOR EXISTING AND DEMOLITION
1/4" = 1'-0"

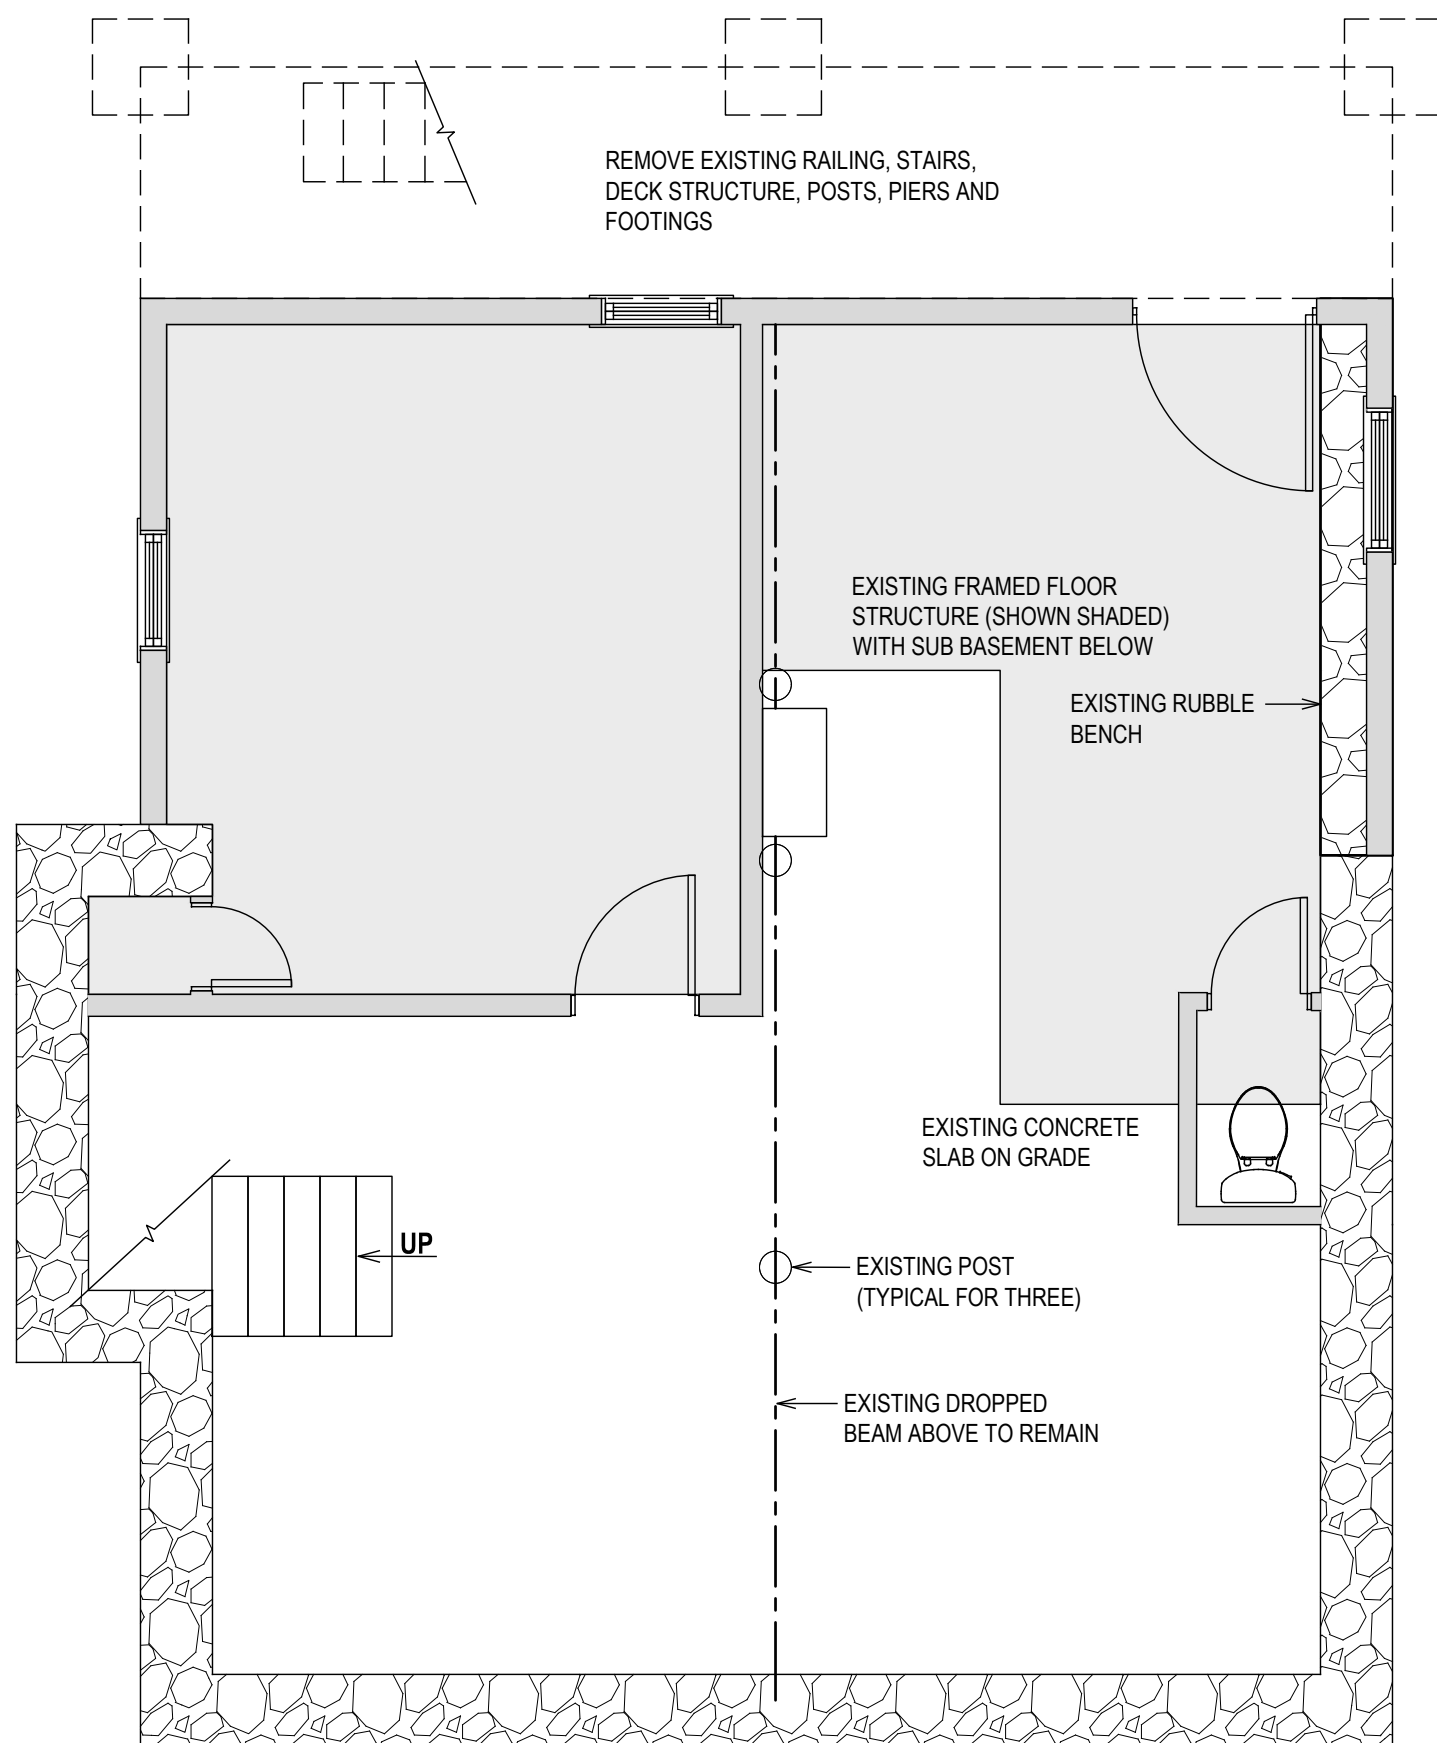

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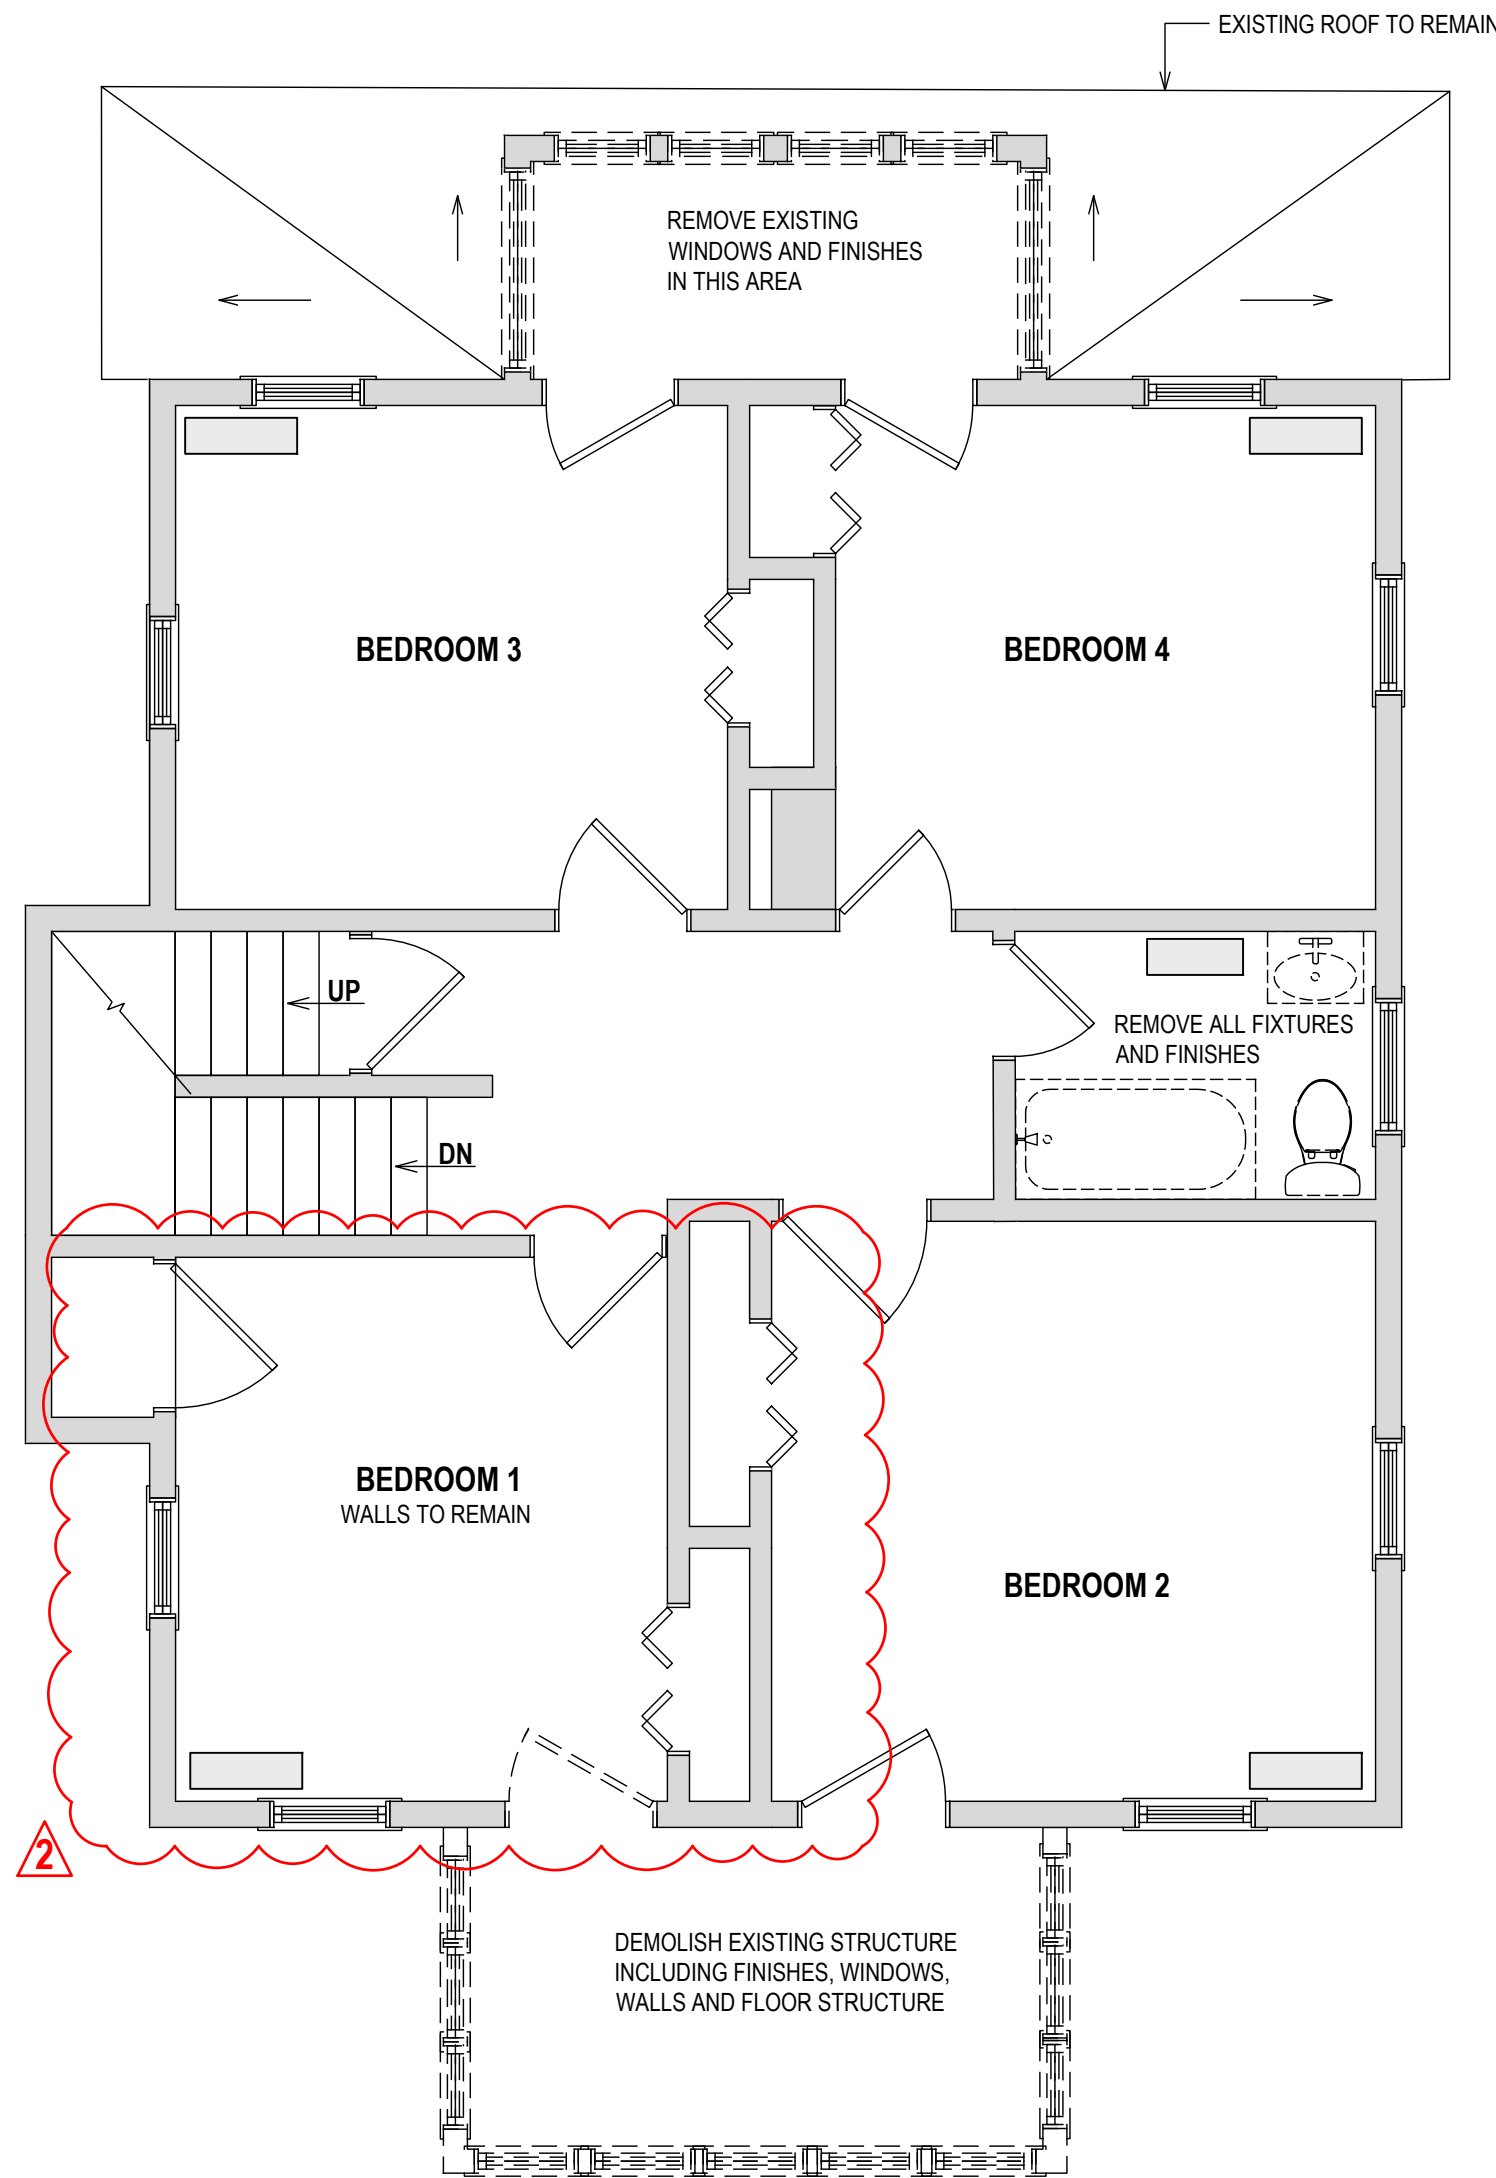
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EXISTING AND DEMOLITION 01

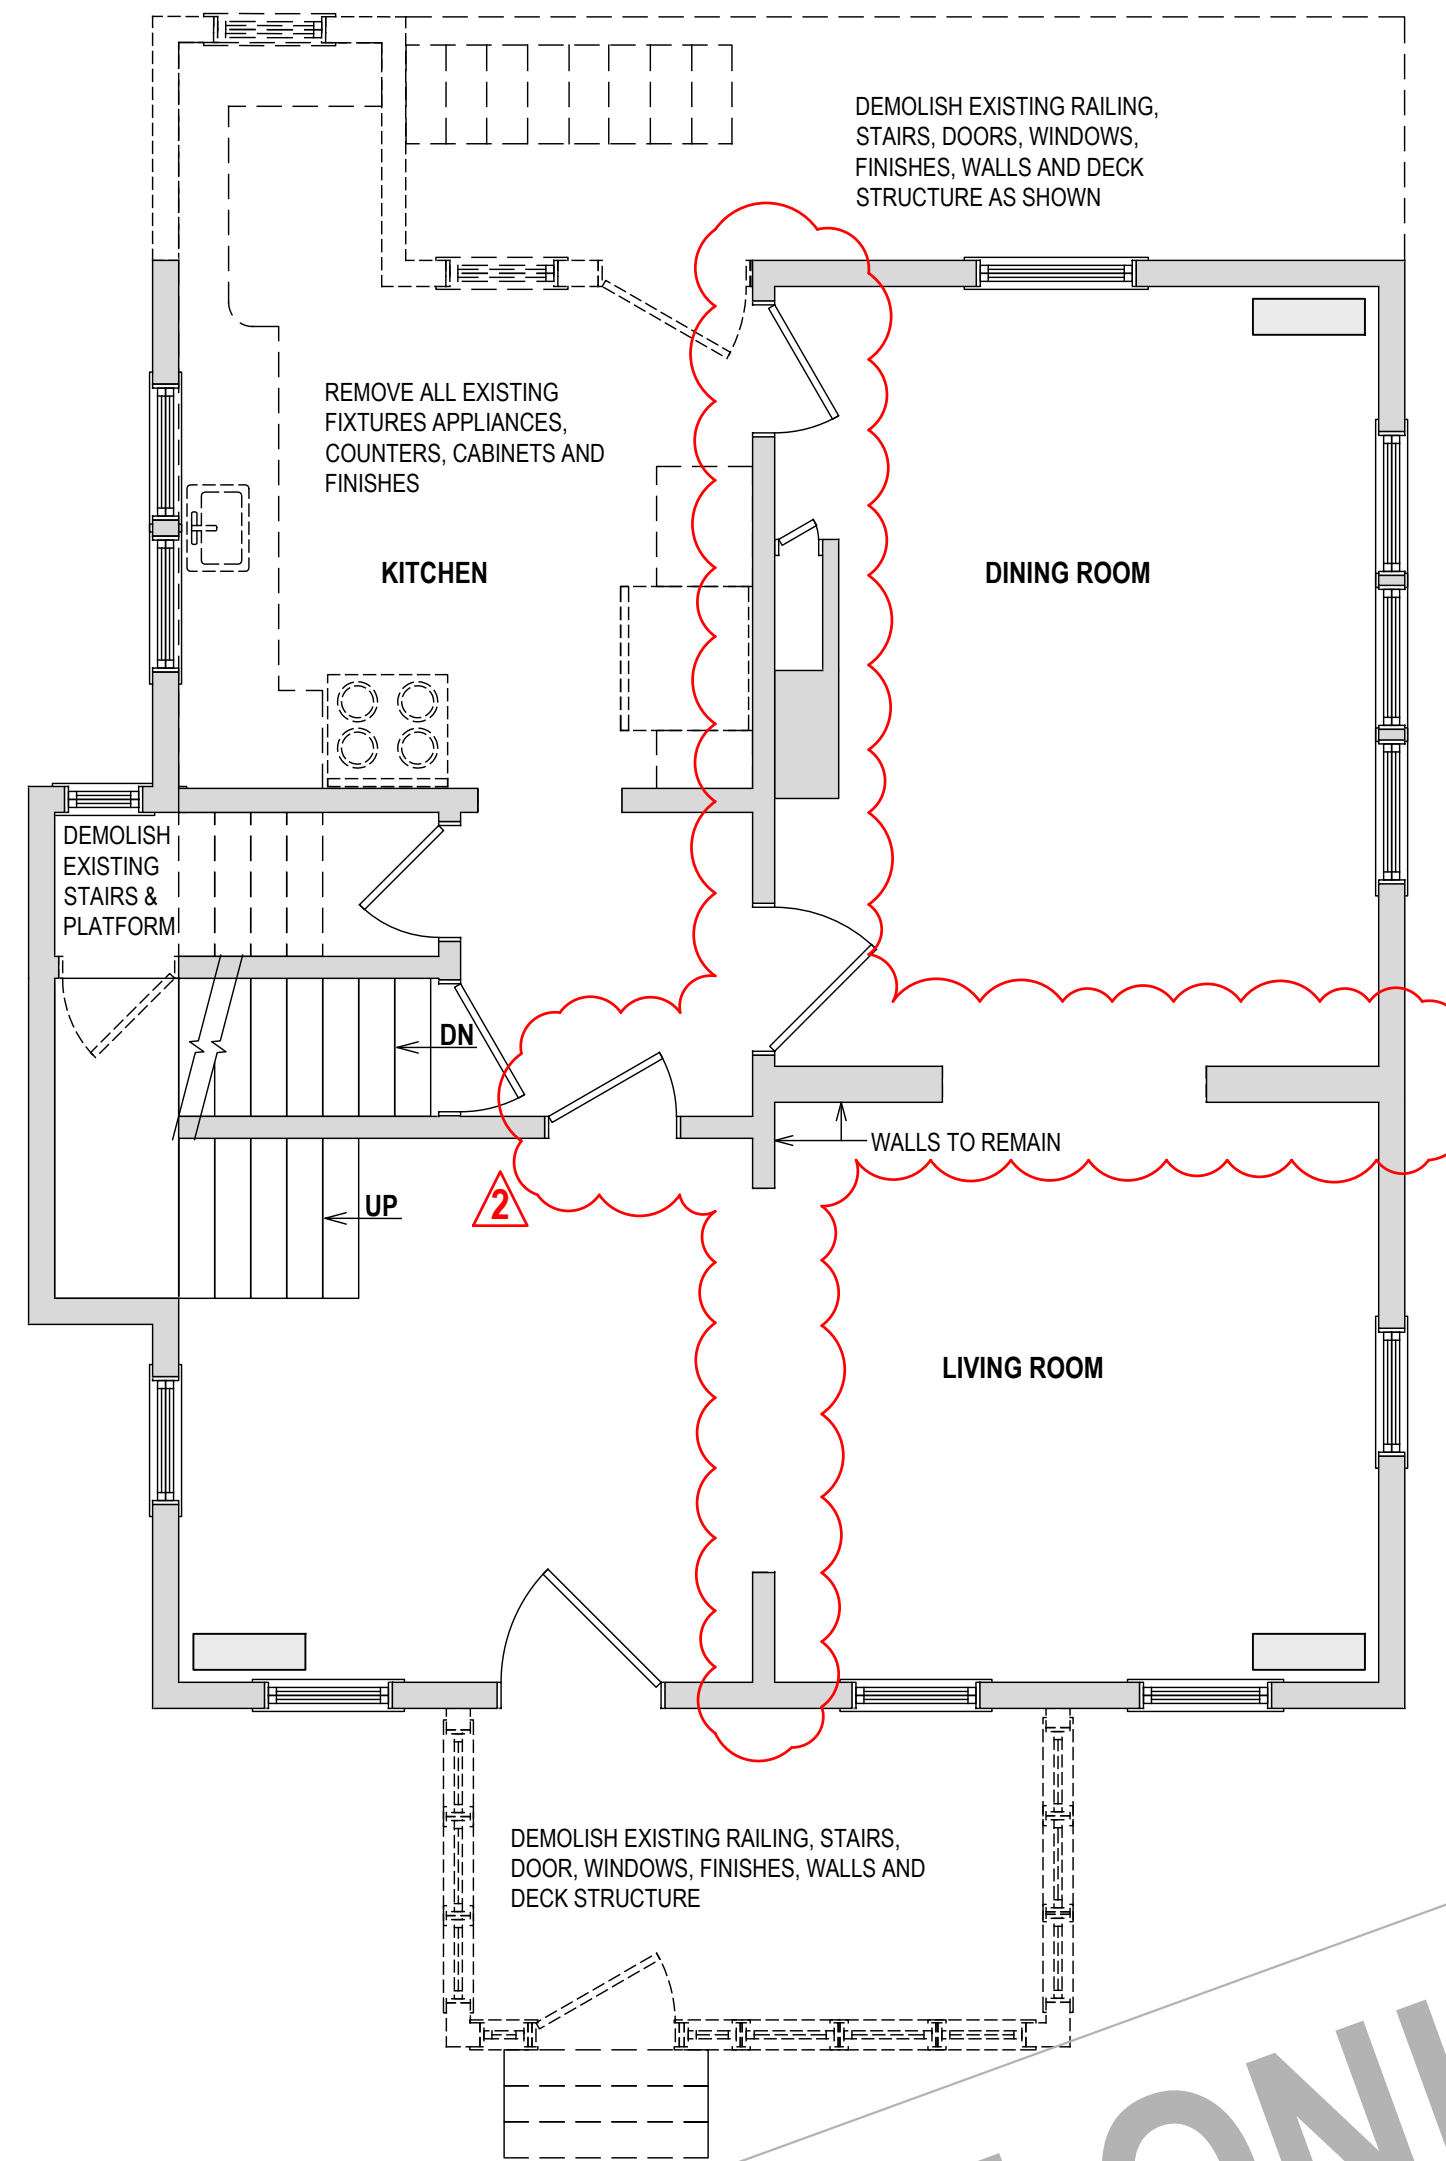DRAWING NUMBER:
D-01


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SECOND FLOOR EXISTING AND DEMOLITION
1/4" = 1'-0"



ATTIC AND ROOF PLAN (NOT TO SCALE)
1/4" = 1'-0"



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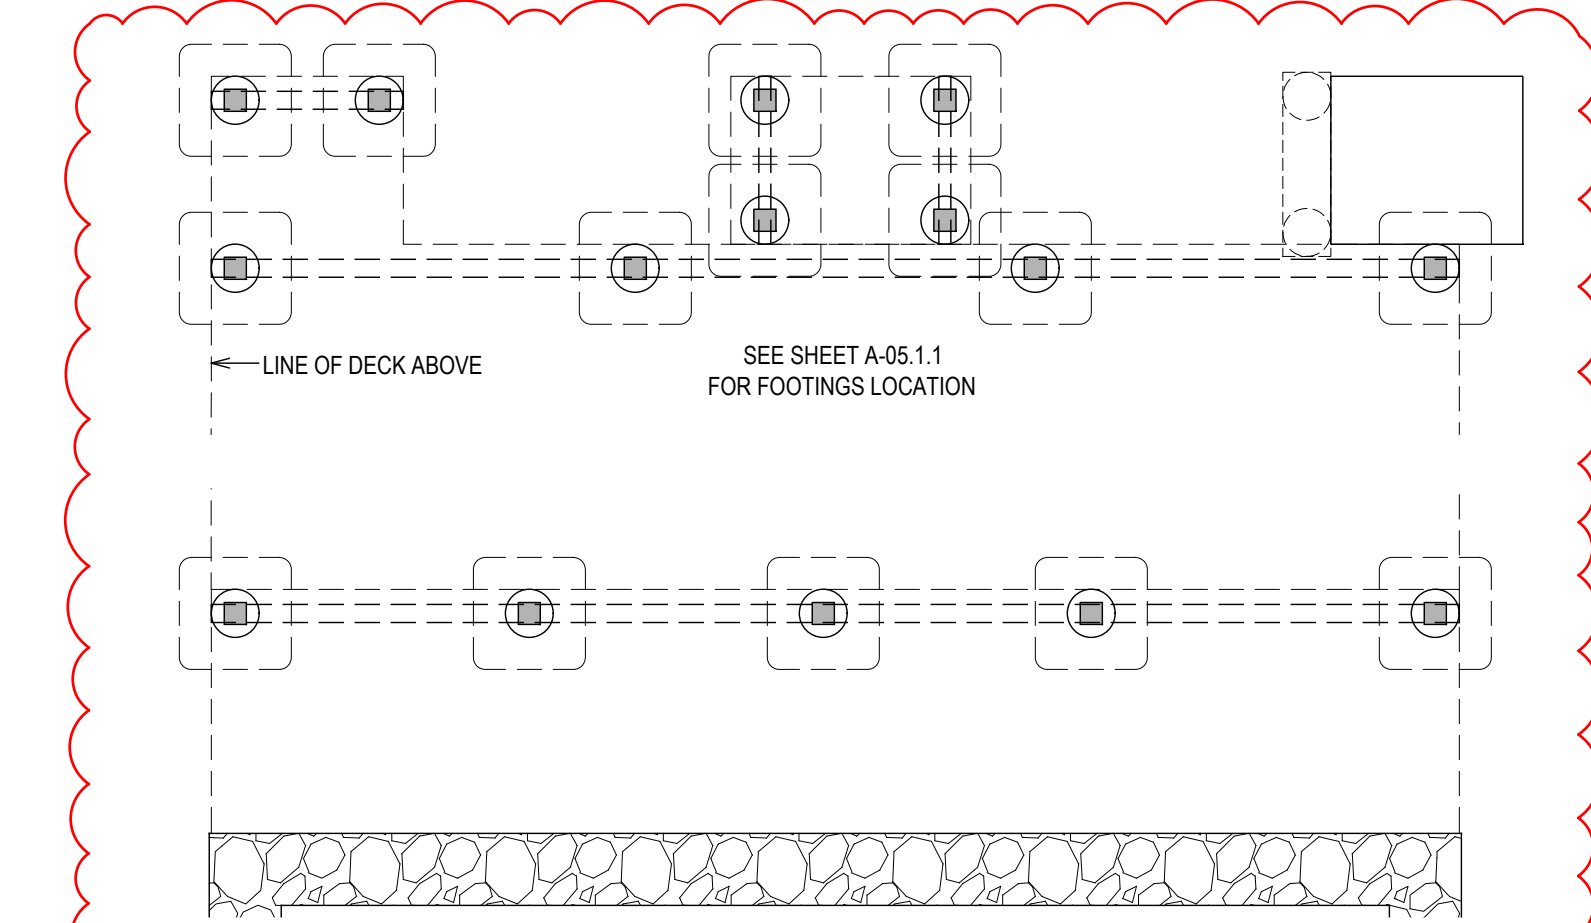
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EXISTING AND DEMOLITION
02

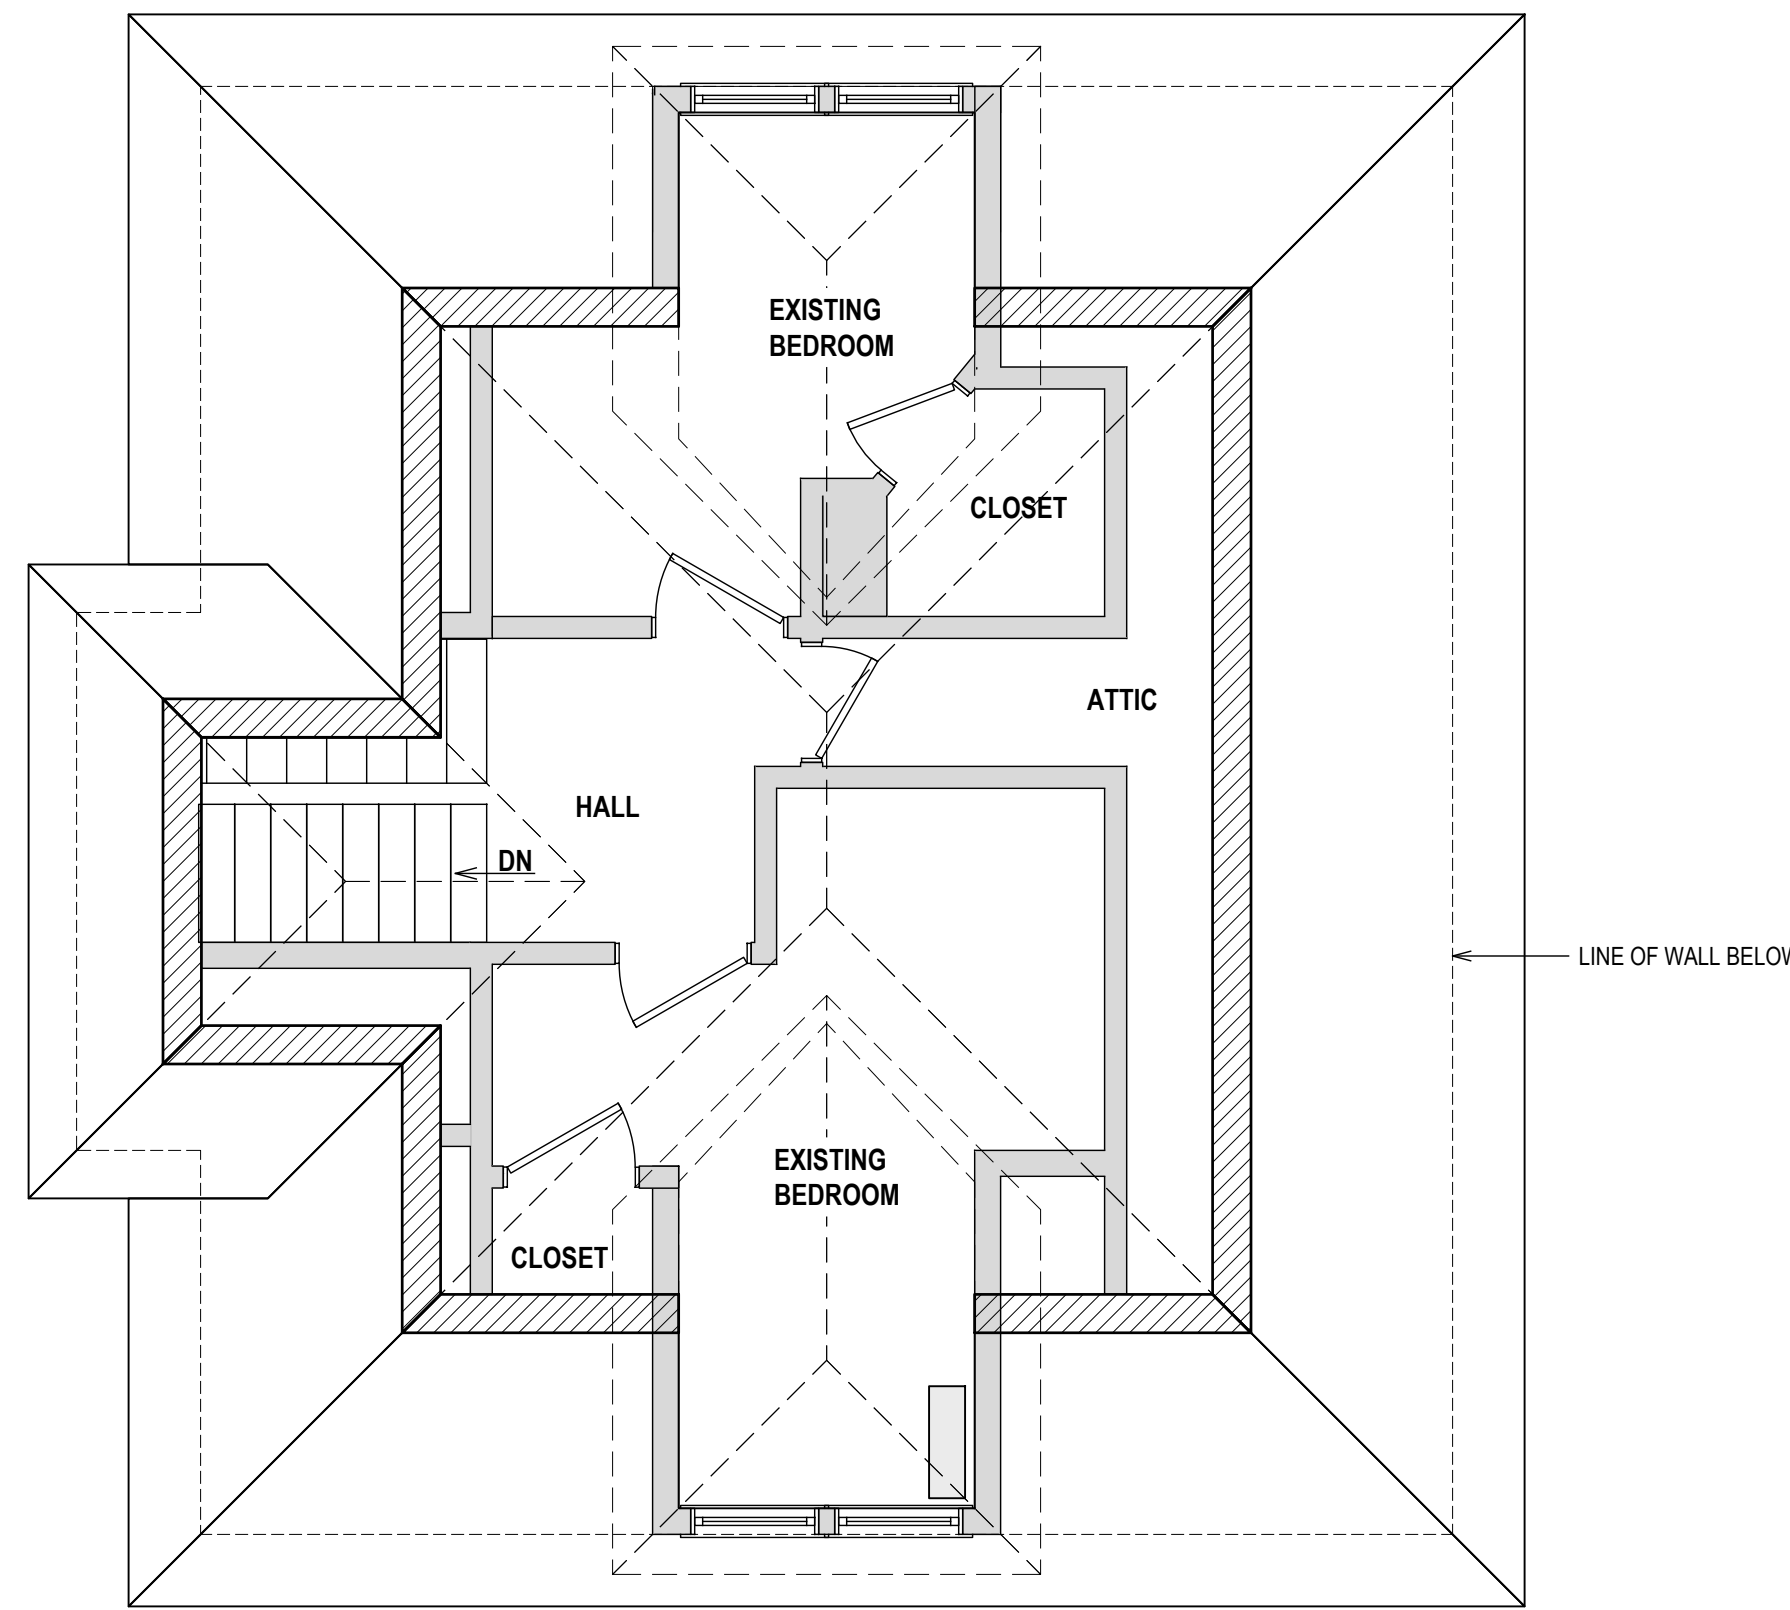DRAWING NUMBER:
D-02

DATE:
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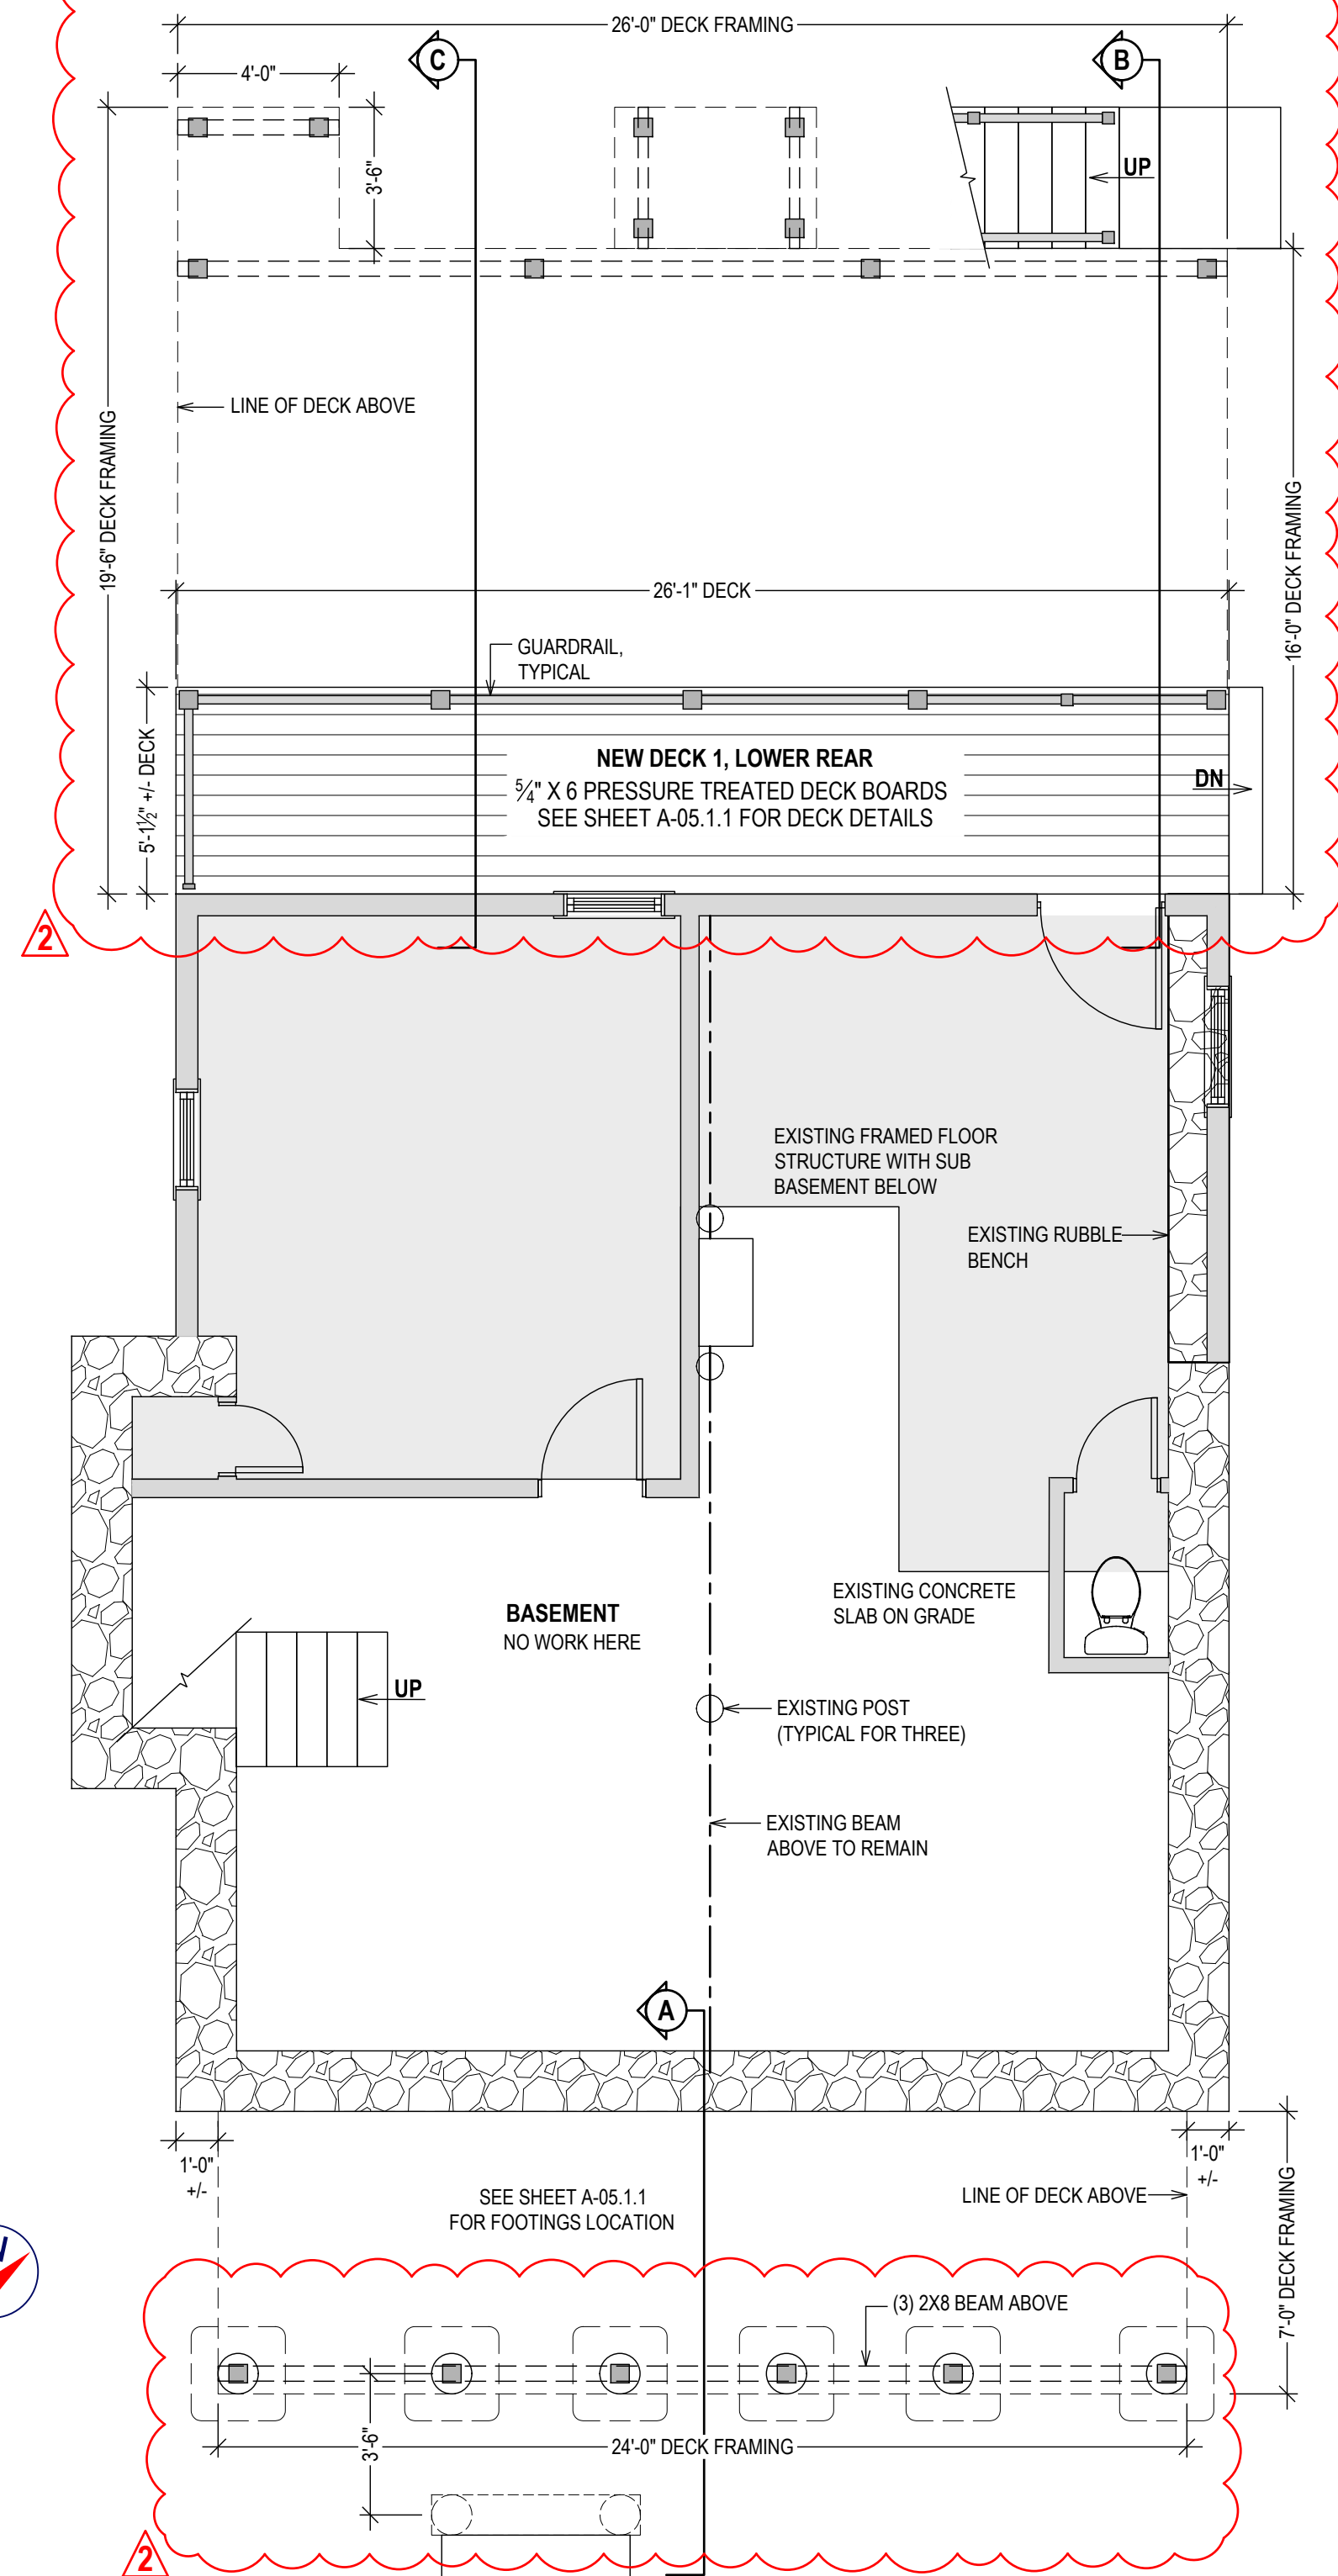
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PROPOSED SUB-BASEMENT PLAN

1/4" = 1'-0"



PROPOSED BASEMENT/FOUNDATION PLAN

1/4" = 1'-0"

WINDOW SCHEDULE							
ALL WINDOWS: SIMULATED DIVIDED LIGHT ON TOP SASH; LOW E GLASS; ENERGY CODE COMPLIANT; 3.5" FLAT EXTERIOR CASING; WHITE INSIDE AND OUT; WHITE HARDWARE; FULL SCREENS; EXTENSION JAMBS AS REQUIRED; CONFIRM ALL DETAILS WITH OWNER; SITE-MEASURE ALL WINDOWS BEFORE ORDERING - CONSIDER LARGER SIZE(S)							
MARK	NO.	TYPE	MODEL**	WIDE*	HIGH*	GLASS	OTHER
W-1	1	ANDERSEN A 200 SERIES DOUBLE-HUNG	244DH2840	2'-8"	4'-0"		
W-2	1	ANDERSEN A 200 SERIES DOUBLE-HUNG	244DH2849	2'-8"	4'-9"		
W-3	1	ANDERSEN A 200 SERIES DOUBLE-HUNG	244DH1849	1'-8"	4'-9"		


NOTES: **ALL ITEMS ABOVE ARE SUBJECT TO OWNER APPROVAL AND/OR AS SELECTED BY OWNER;
* CONFIRM ALL DIMENSIONS BEFORE ORDERING DOORS

DOOR SCHEDULE
TO BE APPROVED BY OWNER
CONFIRM ALL DIMENSIONS

MARK	NO.	TYPE	MODEL**	HAND	WIDE*	HIGH*	HARDWARE**	OTHER
D-1	1	ANDERSEN A 100 SERIES PATIO DOOR			7'-11/4"	79-1/2"	ENTRY	SLIDING
D-2	1	12 LITE PRIMED STEEL PREHUNG FRONT DOOR		L.H.	36"	80"	ENTRY	OUTSWING
INTERIORS	VARIES	MATCH WITH EXISTING					VARIES	

NOTES: **ALL ITEMS ABOVE ARE SUBJECT TO OWNER APPROVAL AND/OR AS SELECTED BY OWNER;
* CONFIRM ALL DIMENSIONS BEFORE ORDERING DOORS

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CONFIRM ALL DIMENSIONS

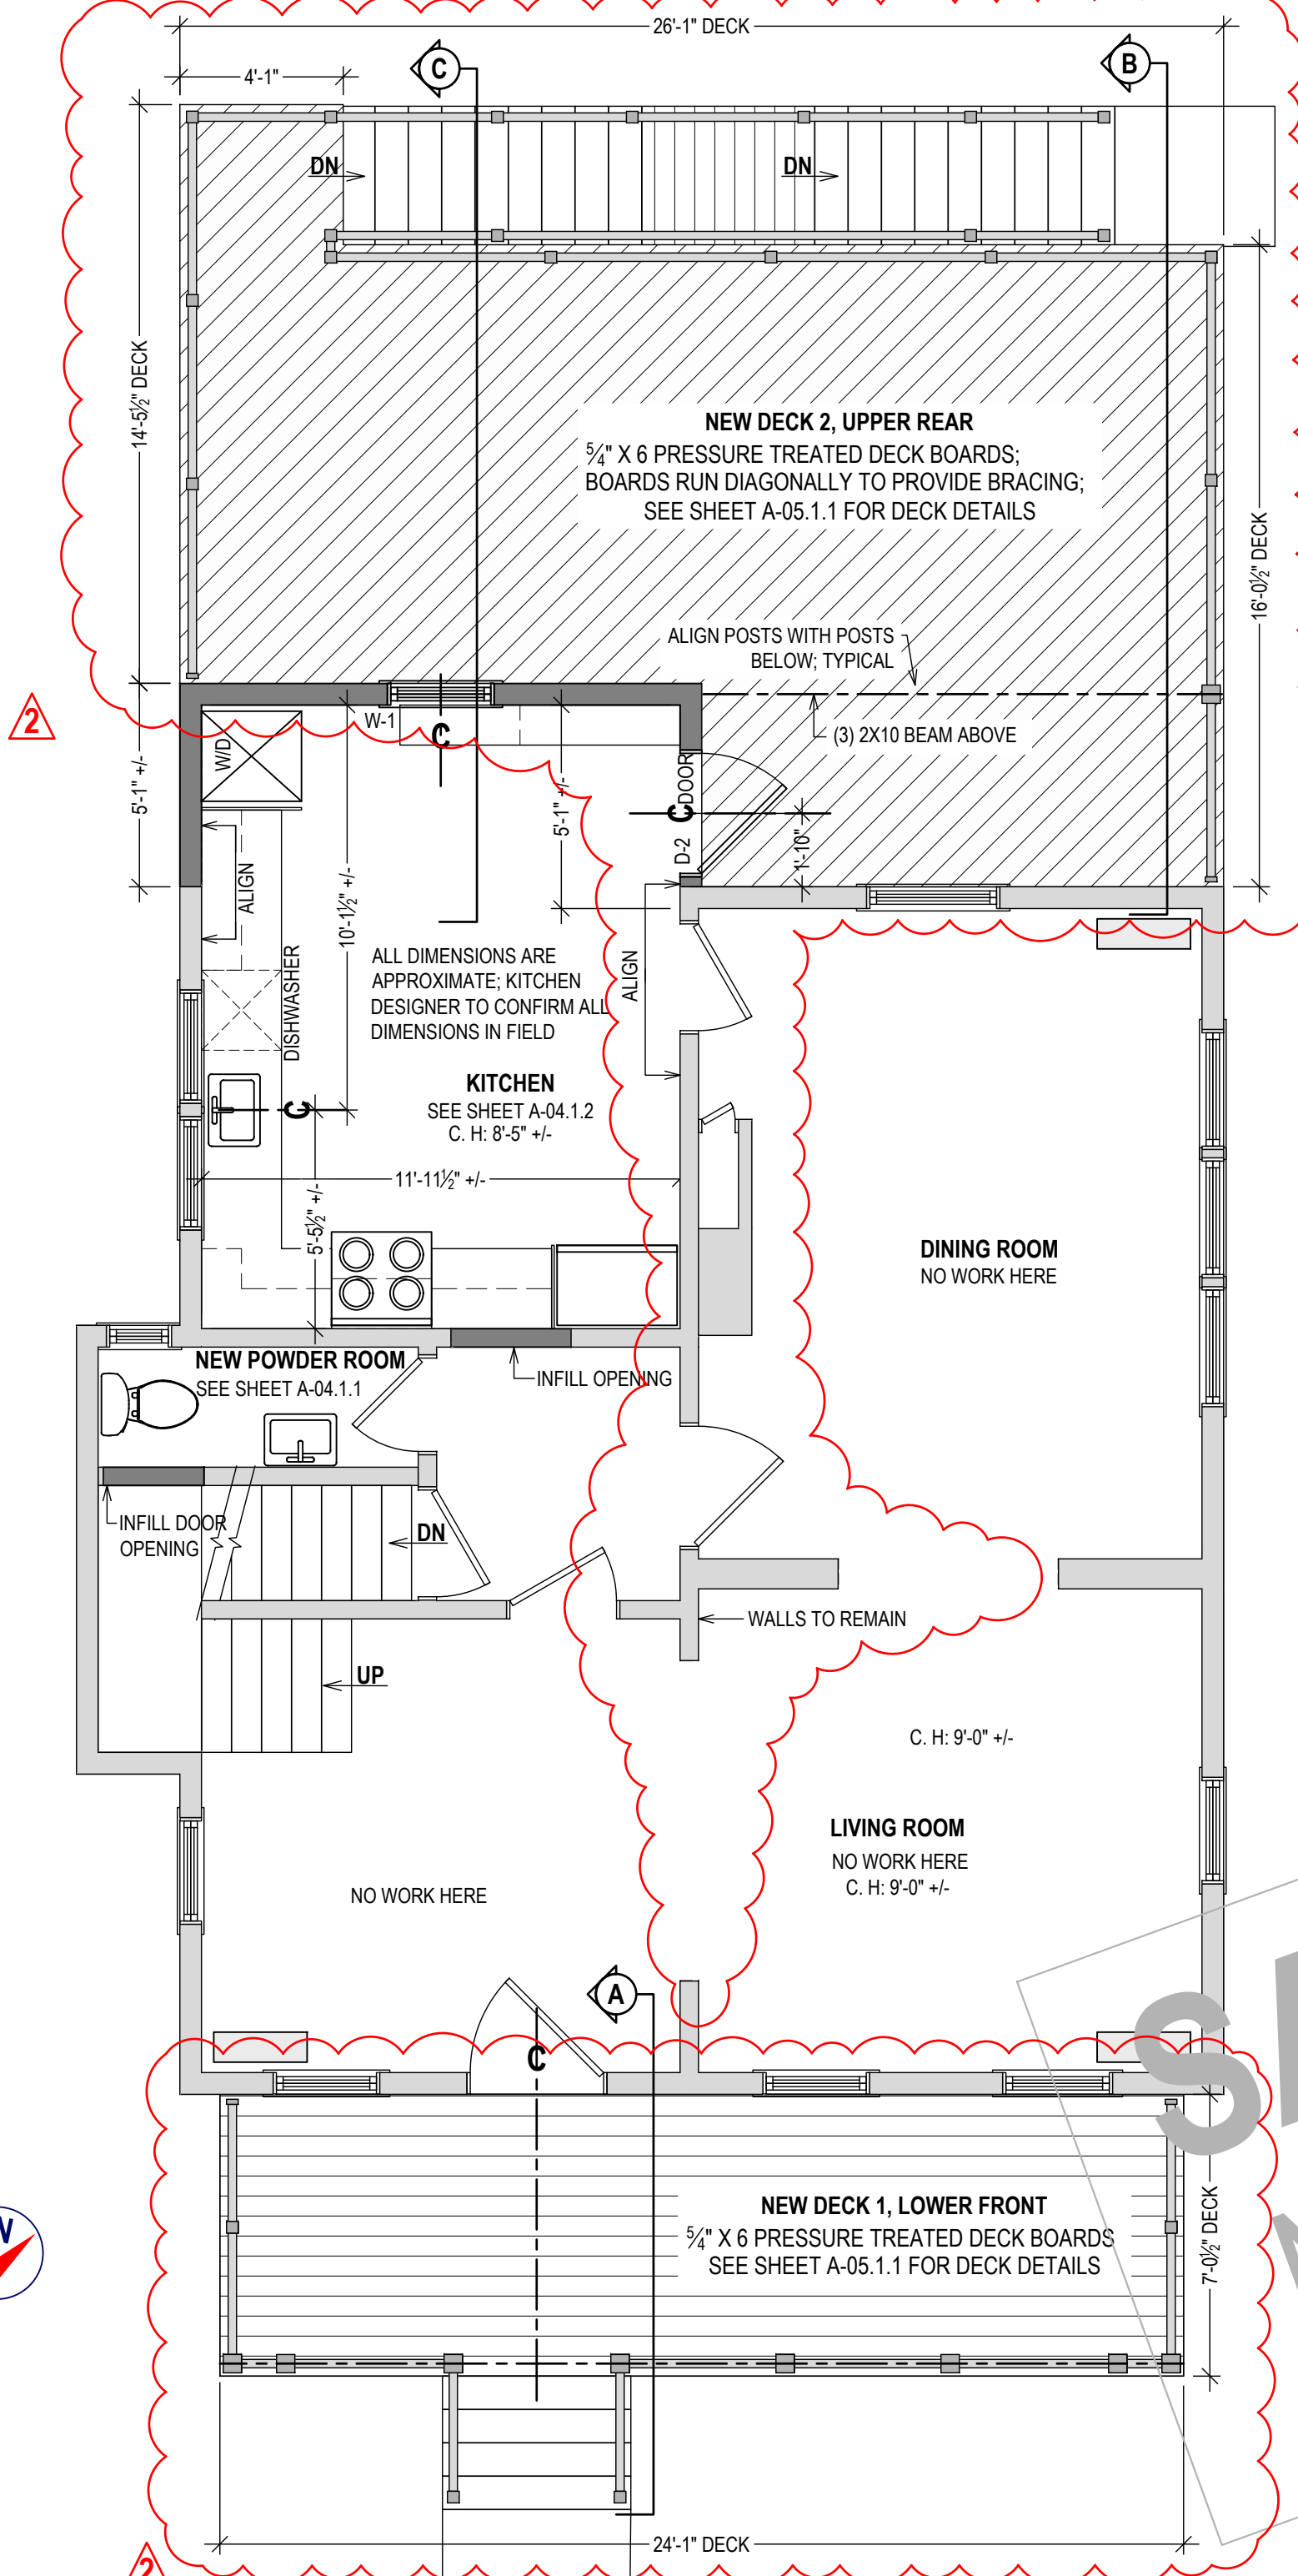


PROPOSED FIRST FLOOR

1/4" = 1'-0"

TRUSS TYPE CONSTRUCTION:

UTILIZATION:
THE UTILIZATION OF TRUSS-TYPE CONSTRUCTION, PRE-ENGINEERED WOOD CONSTRUCTION AND/OR TIMBER CONSTRUCTION IN RESIDENTIAL STRUCTURES IS SUBJECT TO THE REQUIREMENTS OF TITLE 19 OF THE NEW YORK CODES, RULES AND REGULATIONS (NYCRR), PART 1205: ANY PERSON UTILIZING TRUSS TYPE, PRE-ENGINEERED WOOD OR TIMBER CONSTRUCTION FOR THE ERECTION OF ANY NEW RESIDENTIAL STRUCTURE, FOR ANY ADDITION TO AN EXISTING RESIDENTIAL STRUCTURE, OR FOR ANY REHABILITATION OF AN EXISTING RESIDENTIAL STRUCTURE, SHALL, UPON APPLICATION FOR A BUILDING PERMIT WITH THE LOCAL GOVERNMENT HAVING JURISDICTION, INCLUDE ON THE PERMIT APPLICATION THAT TRUSS TYPE, PRE-ENGINEERED WOOD OR TIMBER CONSTRUCTION IS BEING UTILIZED, AND THAT THE PROPERTY OWNER OR THE PROPERTY OWNER'S REPRESENTATIVE SHALL COMPLETE A FORM PRESCRIBED BY THE STATE FIRE PREVENTION AND BUILDING CODE COUNCIL (HEREINAFTER REFERRED TO AS THE CODE COUNCIL) DESIGNATING THE STRUCTURE AS TRUSS TYPE, PRE-ENGINEERED WOOD OR TIMBER CONSTRUCTION AND FILE SUCH FORM WITH THE APPLICATION FOR A BUILDING PERMIT.

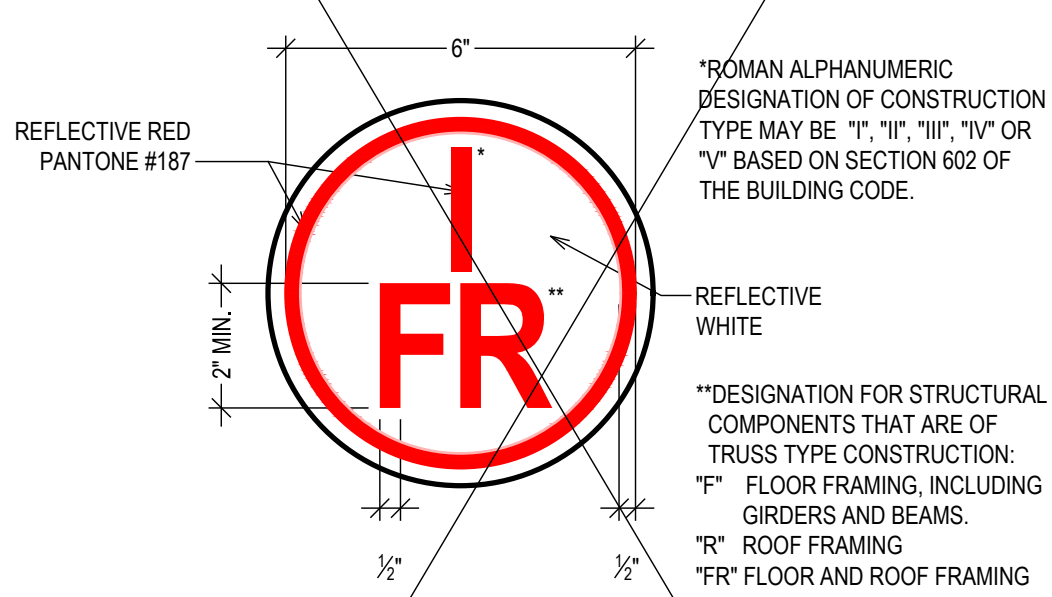

REQUIRED SIGN:
AS A CONDITION OF THE RECEIPT OF A CERTIFICATE OF OCCUPANCY, A SIGN OR SYMBOL DESIGNED AND APPROVED BY THE CODE COUNCIL SHALL BE AFFIXED TO THE ELECTRIC BOX ATTACHED TO THE EXTERIOR OF THE RESIDENTIAL STRUCTURE, PROVIDED:
HOWEVER:
IF AFFIXING THE SIGN OR SYMBOL TO THE ELECTRIC BOX WOULD OBSCURE ANY METER ON THE ELECTRIC BOX, OR IF THE UTILITY PROVIDING ELECTRIC SERVICE TO THE RESIDENTIAL STRUCTURE DOES NOT ALLOW THE SIGN OR SYMBOL TO BE AFFIXED TO THE ELECTRIC BOX, THE SIGN OR SYMBOL SHALL BE AFFIXED TO THE EXTERIOR WALL OF THE RESIDENTIAL STRUCTURE AT A POINT IMMEDIATELY ADJACENT TO THE ELECTRIC BOX, AND:
IF NO ELECTRIC BOX IS ATTACHED TO THE EXTERIOR OF THE RESIDENTIAL STRUCTURE OR IF, IN THE OPINION OF THE AUTHORITY HAVING JURISDICTION, THE ELECTRIC BOX ATTACHED TO THE EXTERIOR OF THE BUILDING IS NOT LOCATED IN A PLACE LIKELY TO BE SEEN BY FIREFIGHTERS OR OTHER FIRST RESPONDERS RESPONDING TO A FIRE OR OTHER EMERGENCY AT THE RESIDENTIAL STRUCTURE, THE SIGN OR SYMBOL SHALL BE AFFIXED TO THE EXTERIOR OF THE STRUCTURE IN A LOCATION APPROVED BY THE BUILDING OFFICIAL OF THE VILLAGE OF PORT CHESTER AS A LOCATION LIKELY TO BE SEEN BY FIREFIGHTERS OR OTHER FIRST RESPONDERS RESPONDING TO A FIRE OR OTHER EMERGENCY AT THE RESIDENTIAL STRUCTURE.

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PROPOSED 01

DRAWING NUMBER:

A-01.1

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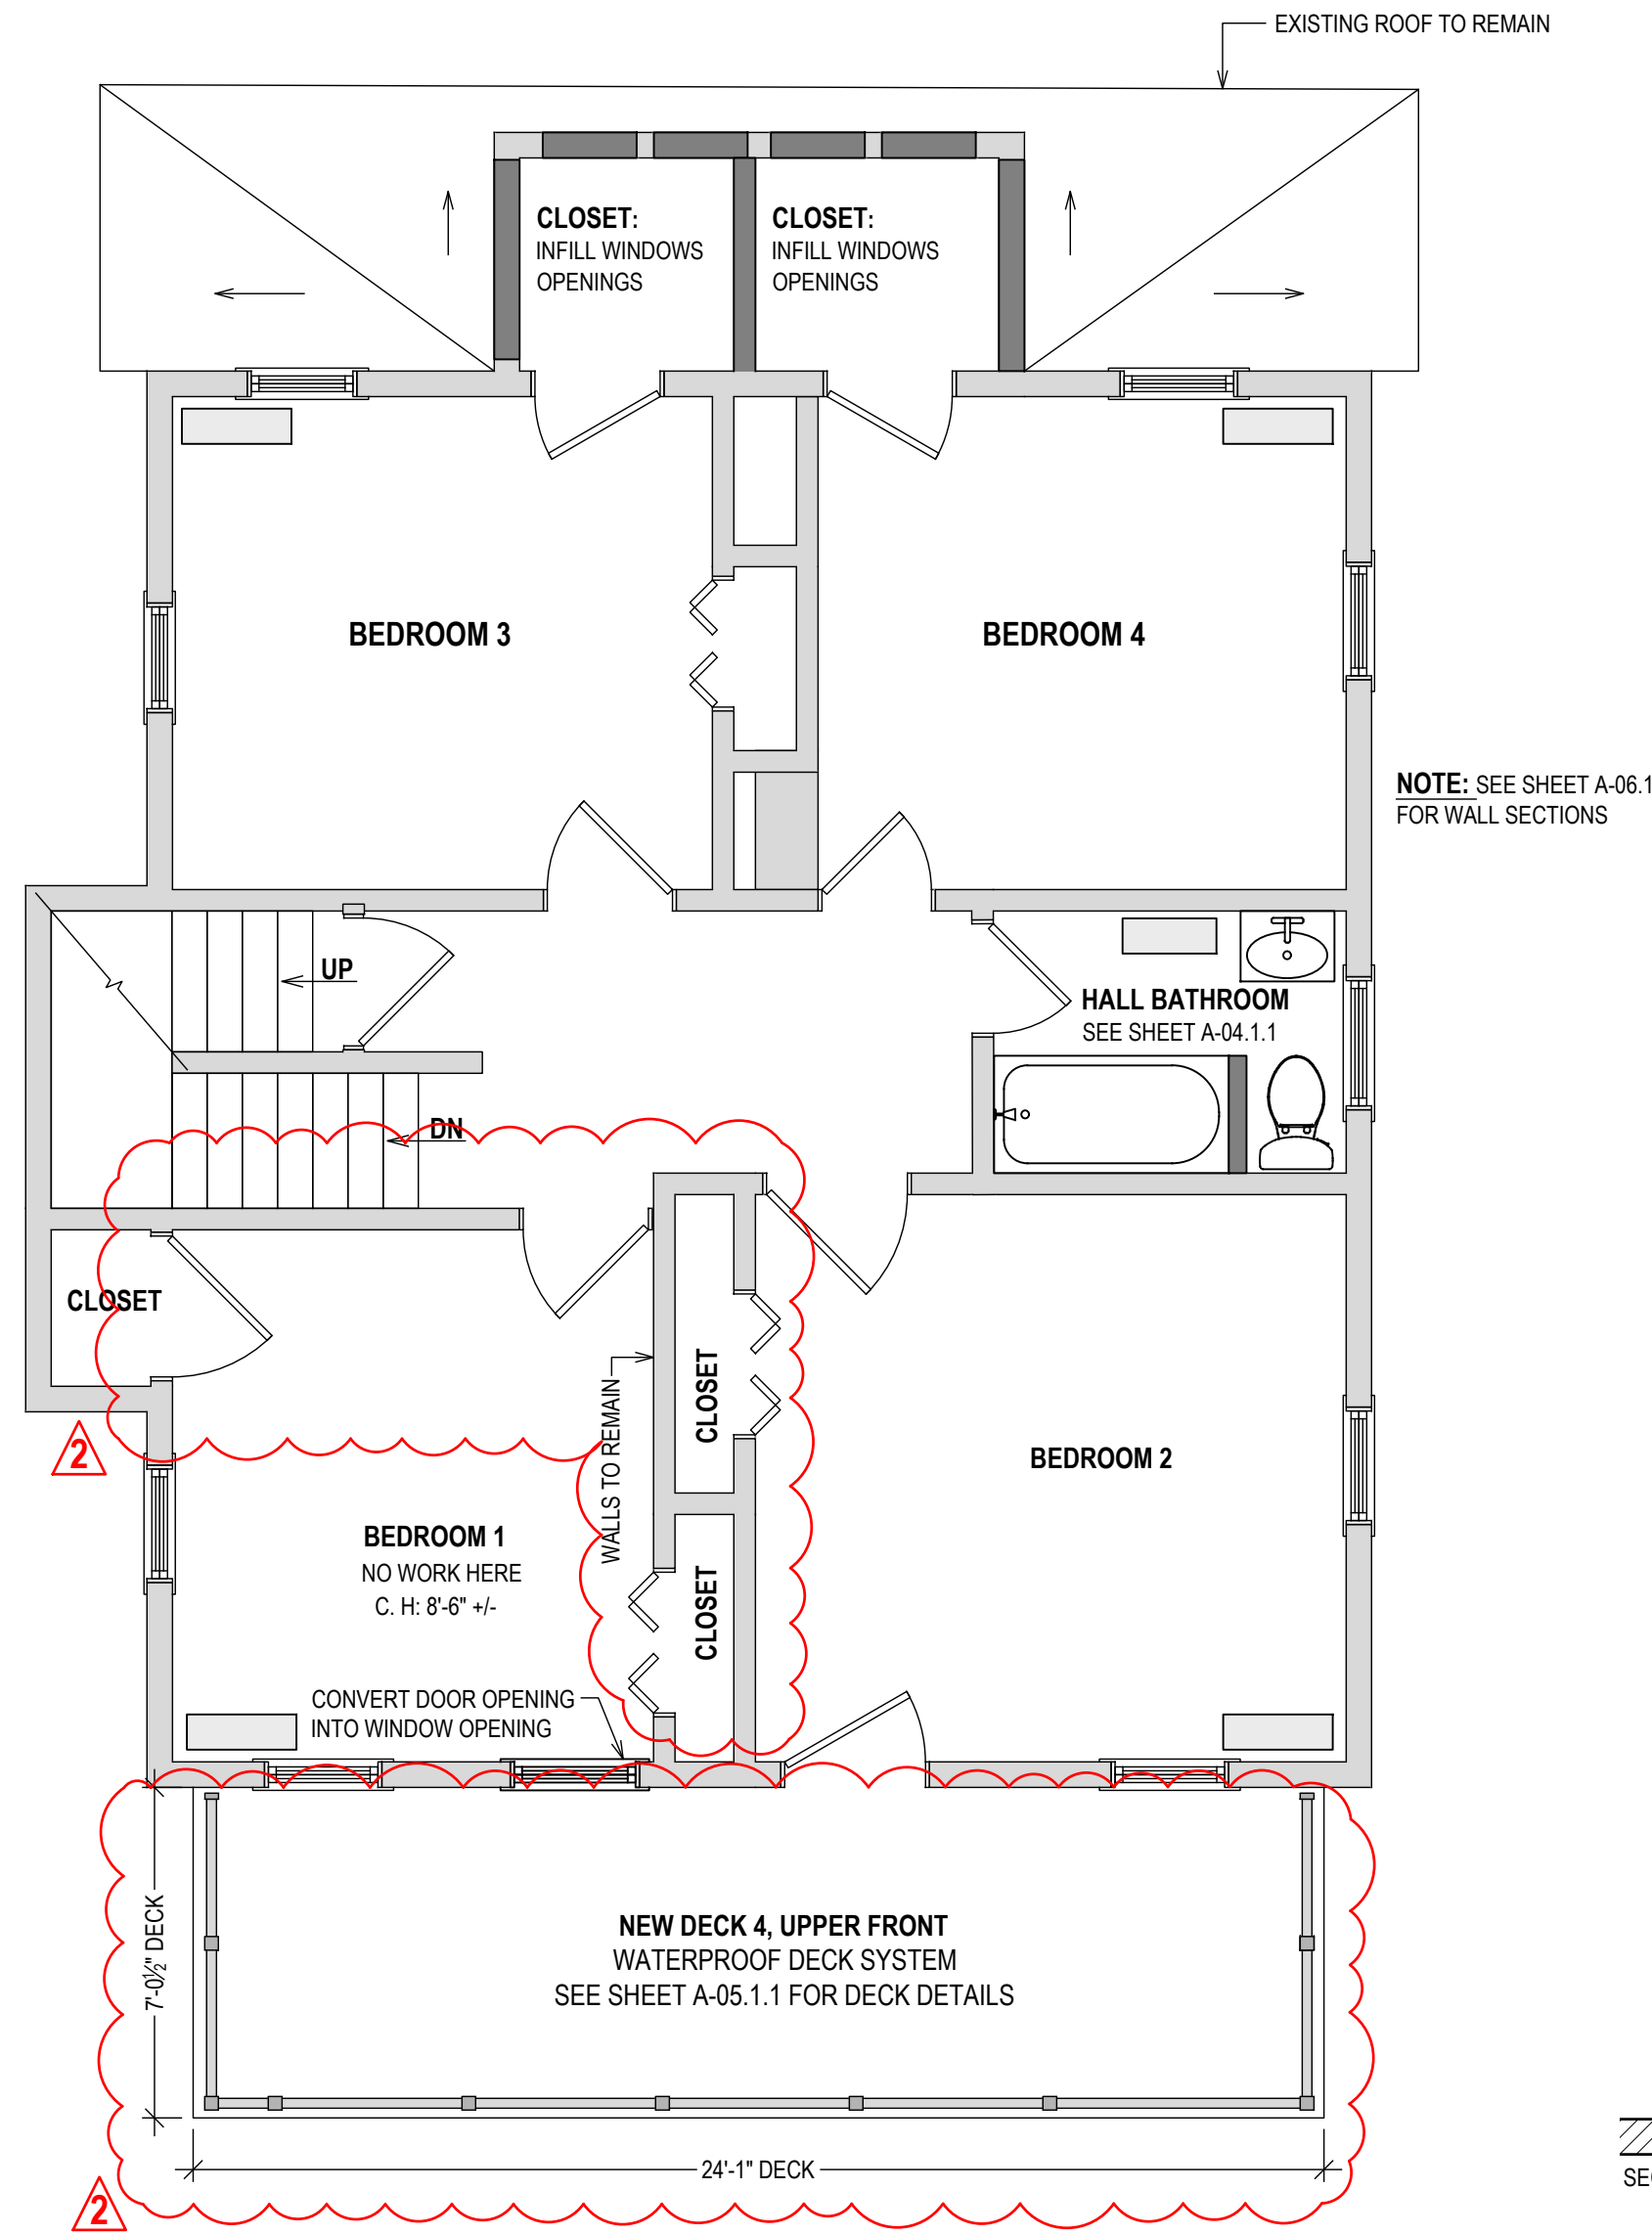
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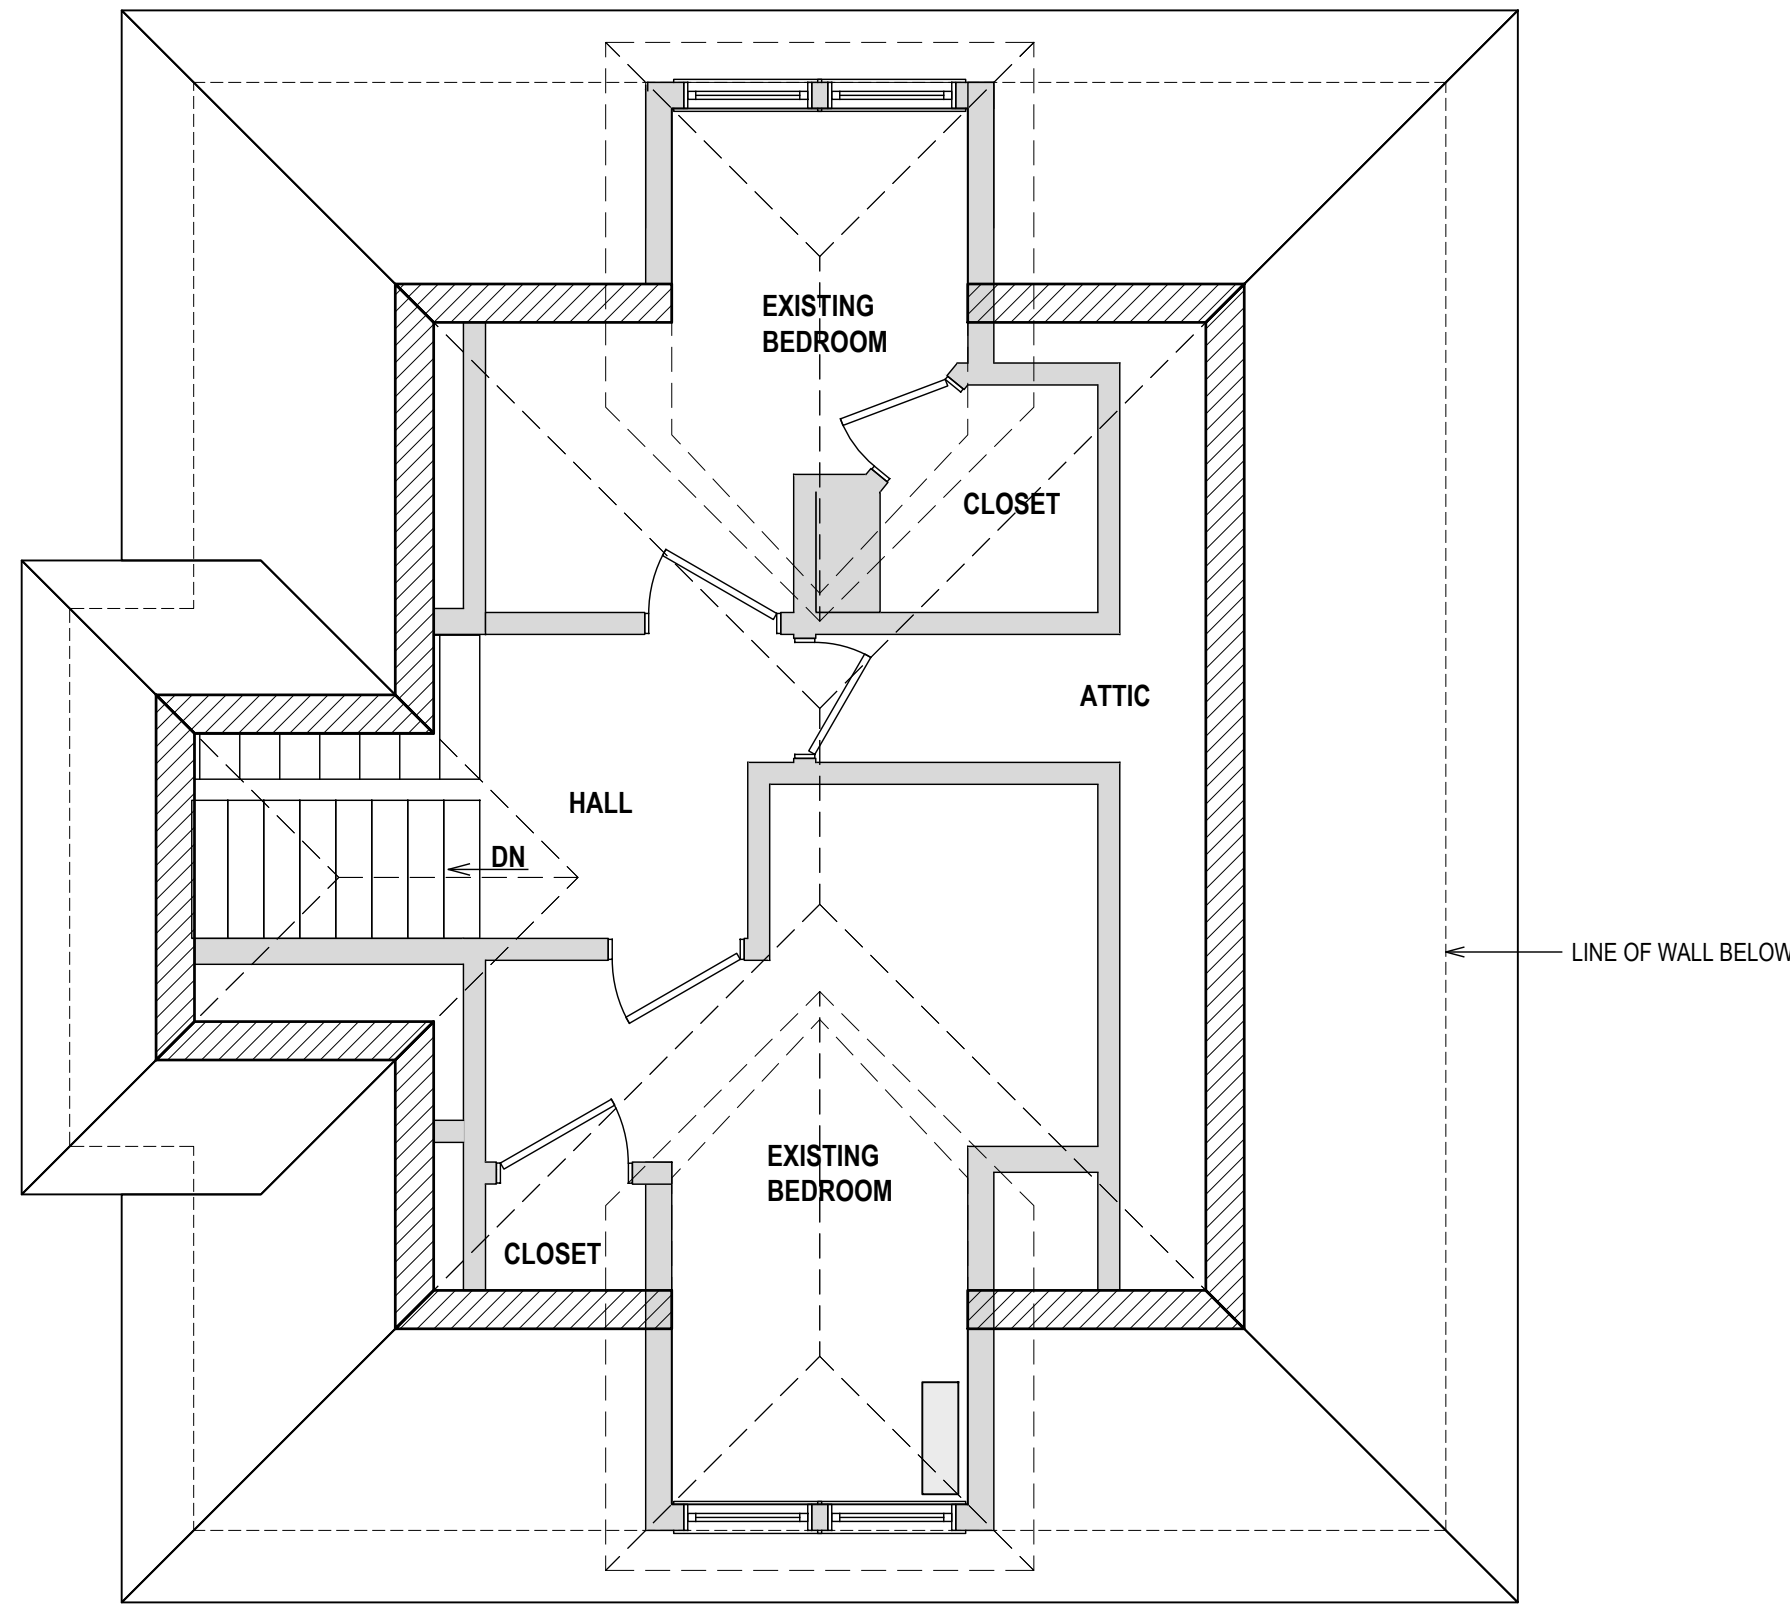
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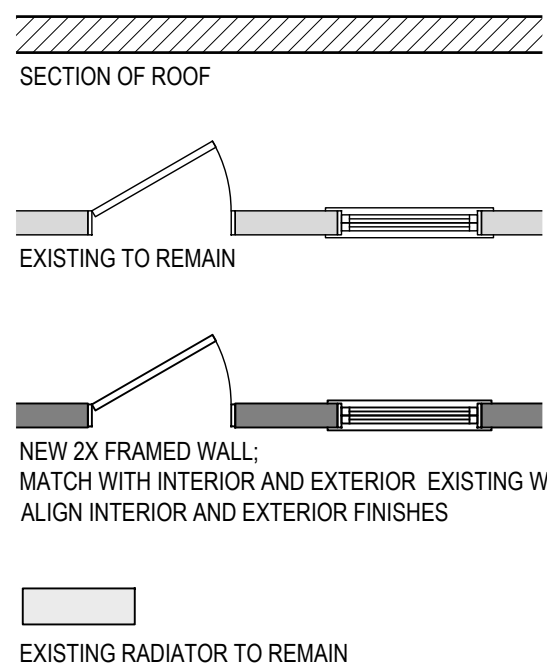
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PROPOSED SECOND FLOOR
1/4" = 1'-0"



PROPOSED ATTIC (NO WORK THIS AREA)
1/4" = 1'-0"



WOOD FRAMING:

FLOOR FRAMING:
STRUCTURAL FLOOR MEMBERS SHALL CONFORM TO THE APPLICABLE PROVISIONS OF SECTION R502.

ALL FLOOR FRAMING, INCLUDING JOISTS, LEDGERS, HEADERS AND BLOCKING, IS TO BE 2X DOUGLAS FIR-LARCH NO. 2 OR HEM-FIR NO. 2, FB-850 PSI, 1.4E OR BETTER.

FLOOR FRAMING IS TO BE AT 16" (MAXIMUM) ON CENTER, OR AS OTHERWISE NOTED IN THE DRAWINGS.

AVOID NOTCHING (SEE CUTTING AND NOTCHING) PROVIDE SISTER MEMBERS AS REQUIRED.

FLOOR SHEATHING SHALL BE 3/4" AVANTECH T&G SUBFLOOR FASTENED WITH 8D COMMON NAILS @ 6" O.C. AND AVANTECH SUBFLOOR ADHESIVE PER MANUFACTURERS INSTRUCTIONS AND SHALL CONFORM TO SECTION 502 OF THE RESIDENTIAL CODE.

WALL FRAMING:

LOAD BEARING WALLS SHALL CONFORM TO THE APPLICABLE PROVISIONS OF SECTION R602.

ALL LOAD BEARING WOOD FRAMED PARTITIONS INCLUDING STUDS, TOP AND BOTTOM PLATE AND BLOCKING, IS TO BE 2X DOUGLAS FIR-LARCH NO. 2 OR HEM-FIR NO. 2, FB-850 PSI, 1.4E OR BETTER.

WALL FRAMING IS TO BE AT 16" (MAXIMUM) ON CENTER, OR AS OTHERWISE NOTED IN THE DRAWINGS.

AVOID NOTCHING (SEE CUTTING AND NOTCHING) PROVIDE SISTER STUDS AS REQUIRED.

EXCEPTION:
BEARING STUDS NOT SUPPORTING FLOORS AND NONBEARING STUDS SHALL BE PERMITTED TO BE UTILITY GRADE LUMBER, PROVIDED THAT THE STUDS ARE SPACED AT 16" O.C. MINIMUM.

BOTTOM (SOLE) PLATE:
STUDS SHALL HAVE FULL BEARING ON A NOMINAL 2X OR LARGER PLATE OR SILL HAVING A WIDTH NOT LESS THAN TO THE WIDTH OF THE STUDS.

TOP PLATE:
WOOD STUD WALLS SHALL BE CAPPED WITH A DOUBLE TOP PLATE INSTALLED TO PROVIDE OVERLAPPING AT CORNERS AND INTERSECTIONS WITH BEARING PARTITIONS. END JOINTS IN TOP PLATES SHALL BE OFFSET NOT LESS THAN 24" JOINTS IN PLATES NEED NOT OCCUR OVER STUDS. PLATES SHALL BE NOT LESS THAN 2" NOMINAL THICKNESS AND HAVE A WIDTH NOT LESS THAN THE WIDTH OF THE STUDS.

WALL SHEATHING SHALL BE MINIMUM 1/2" WOOD STRUCTURAL PANEL, ZIP SYSTEM, PER MANUFACTURERS INSTRUCTIONS HARDIE PLANK LAP SIDING AND SHALL CONFORM TO SECTION 602 OF THE RESIDENTIAL CODE.

ROOF-CEILING CONSTRUCTION:

ROOF FRAMING SHALL CONFORM TO THE APPLICABLE PROVISIONS OF SECTION R802.


ALL ROOF FRAMING, INCLUDING RAFTERS, COLLAR TIES, RAFTER TIES AND CEILING JOISTS, IS TO BE 2X, DOUGLAS FIR-LARCH NO. 2 OR HEM-FIR NO. 2, FB-850 PSI, 1.4E, OR BETTER.

ROOF FRAMING IS TO BE AT 16" (MAXIMUM) ON CENTER, OR AS OTHERWISE NOTED IN THE DRAWINGS.

AVOID NOTCHING (SEE CUTTING AND NOTCHING) PROVIDE SISTER MEMBERS AS REQUIRED.

ROOF SHEATHING SHALL BE ZIP SYSTEM 5/8" SHEATHING AND SHALL CONFORM TO SECTION 803 OF THE RESIDENTIAL CODE.

CUTTING, DRILLING AND NOTCHING FOR WIRES AND PIPES:
WOOD-FRAMED STRUCTURAL MEMBERS SHALL NOT BE DRILLED, NOTCHED OR ALTERED IN ANY MANNER EXCEPT AS PROVIDED IN SECTIONS R502.8, R802.6, R802.7 AND R802.7.1 OF THE RESIDENTIAL CODE.

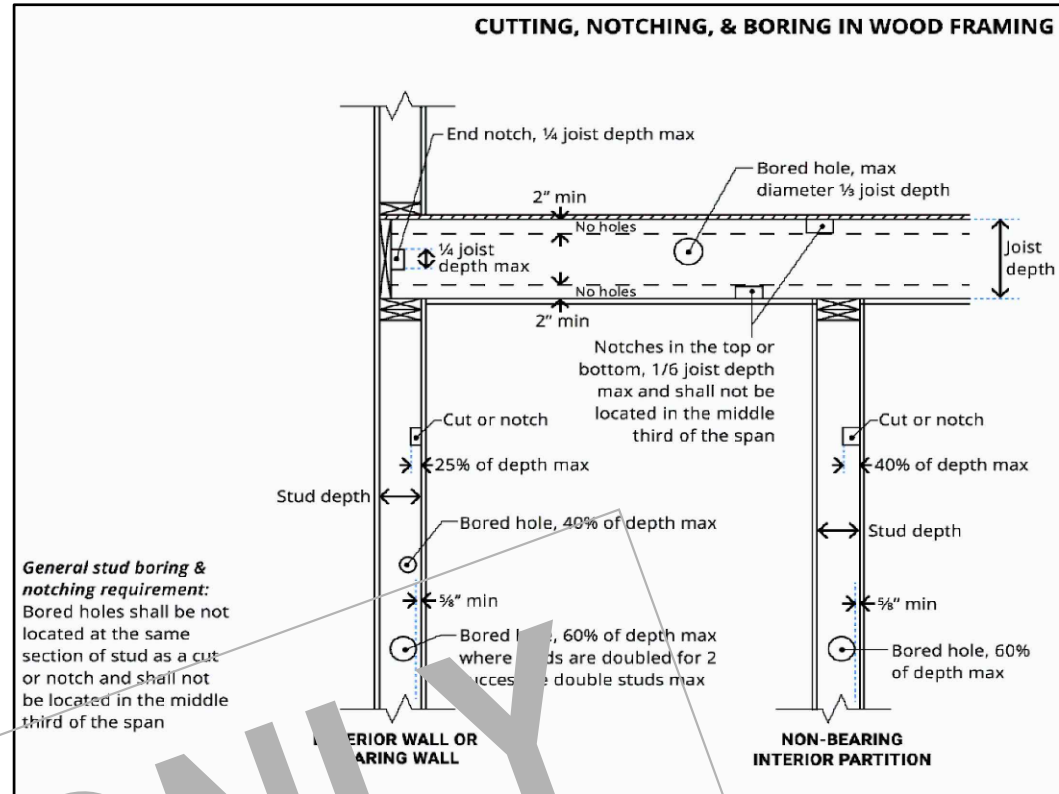

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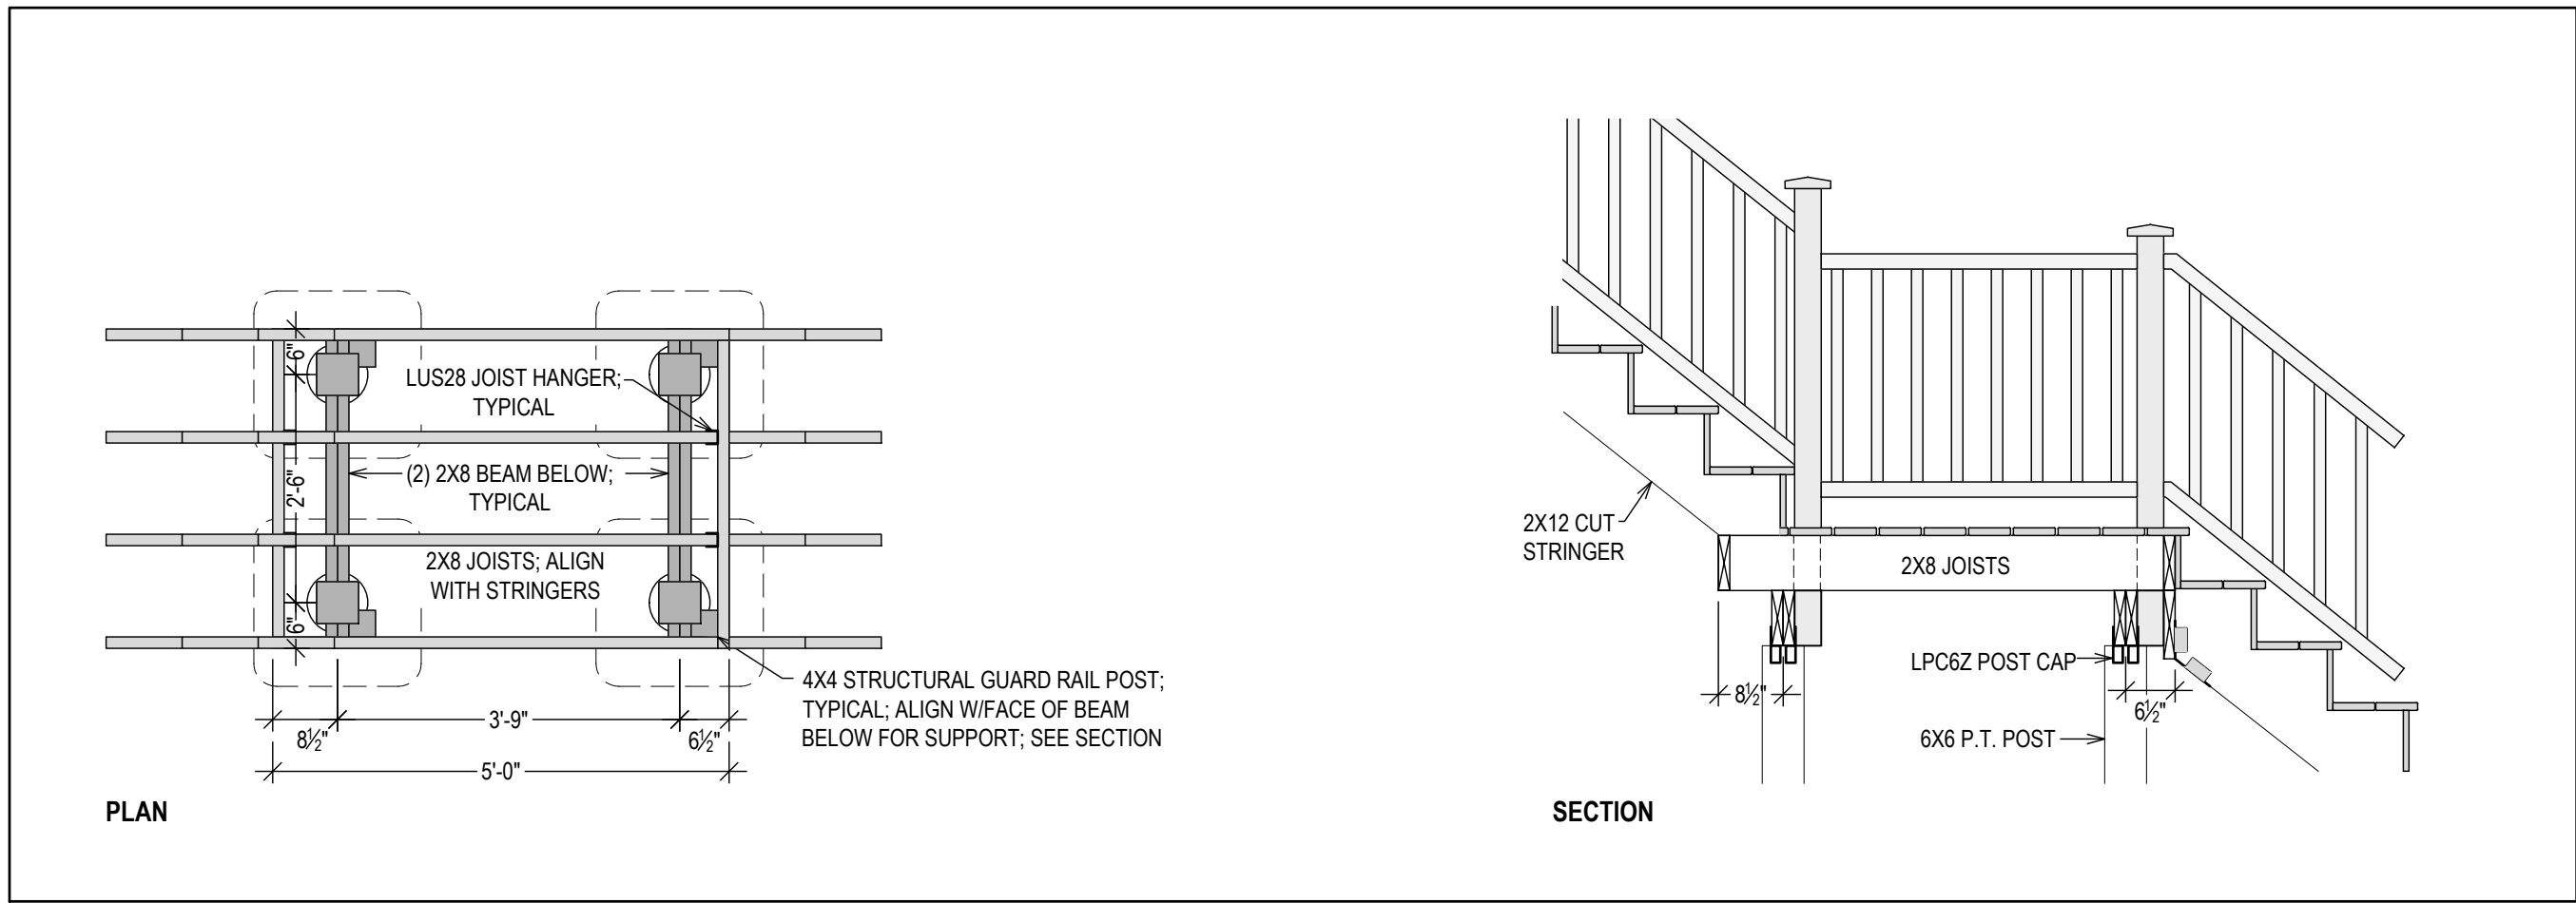
PROJECT NAME:
FLOOR PLAN ALTERATION

DRAWING NAME:
PROPOSED 02

DRAWING NUMBER:
A-01.2


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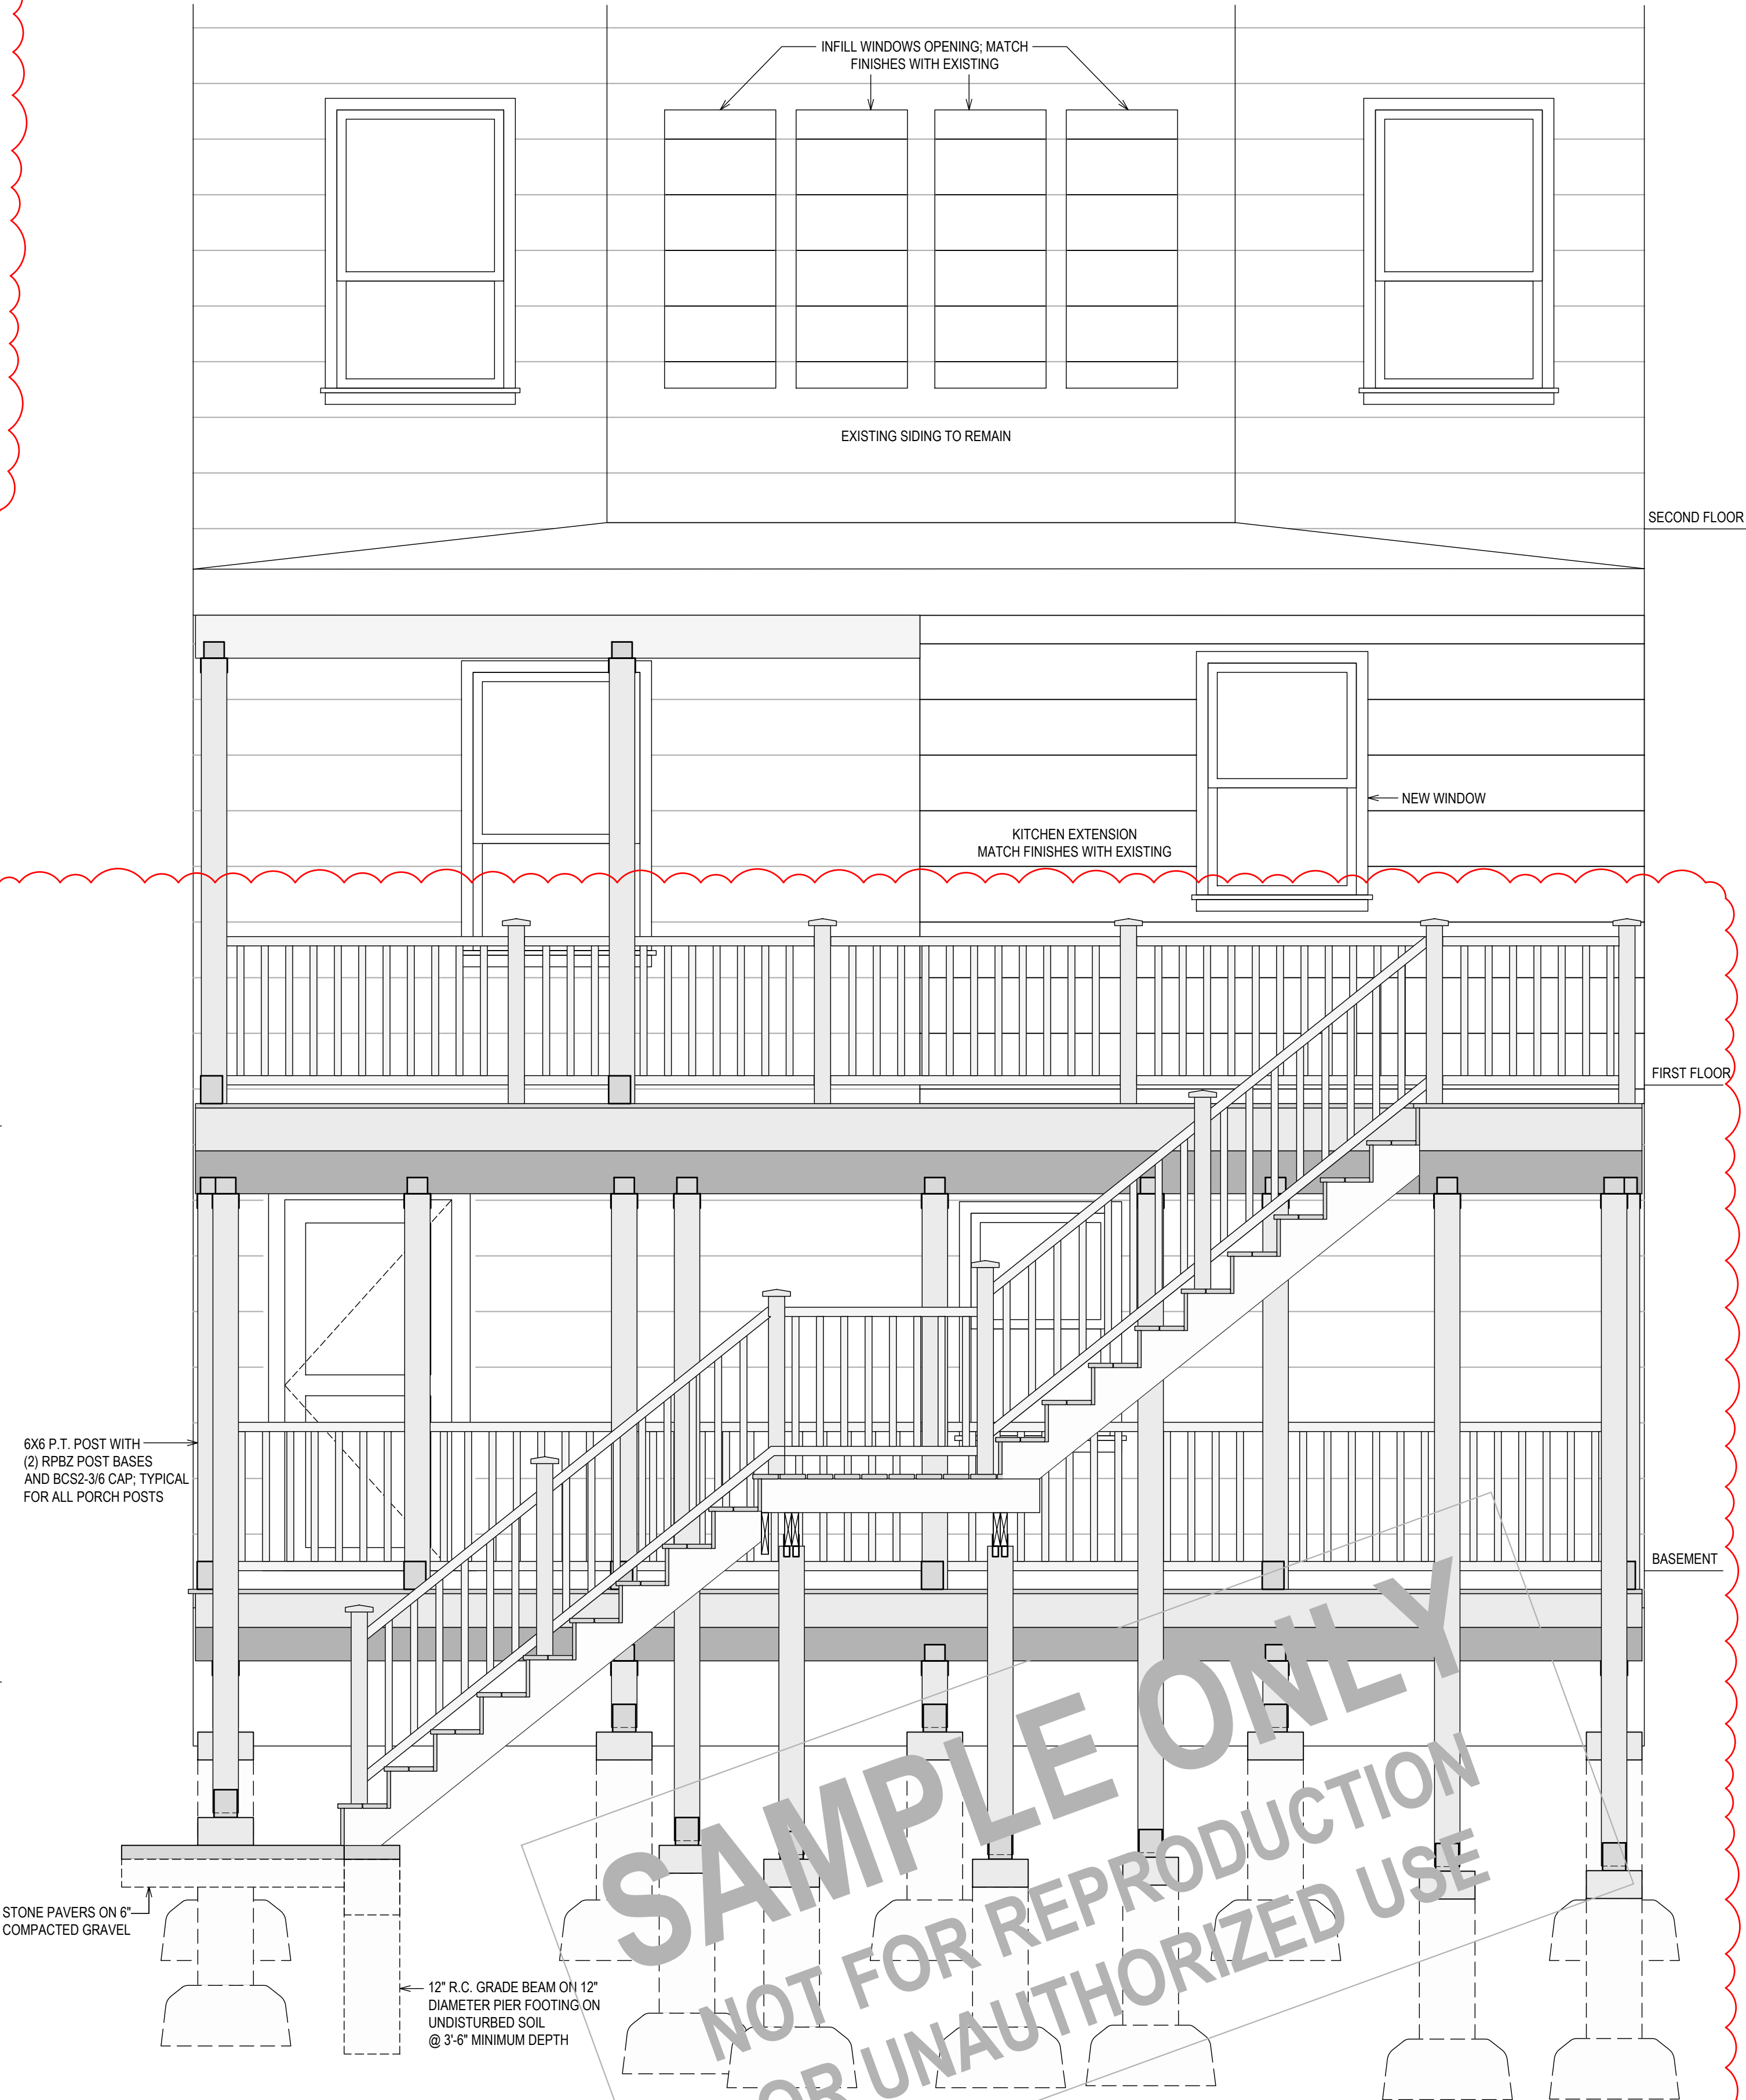
REAR STAIRS LANDING FRAMING

1/2" = 1'-0"



FRONT ELEVATION

1/2" = 1'-0"

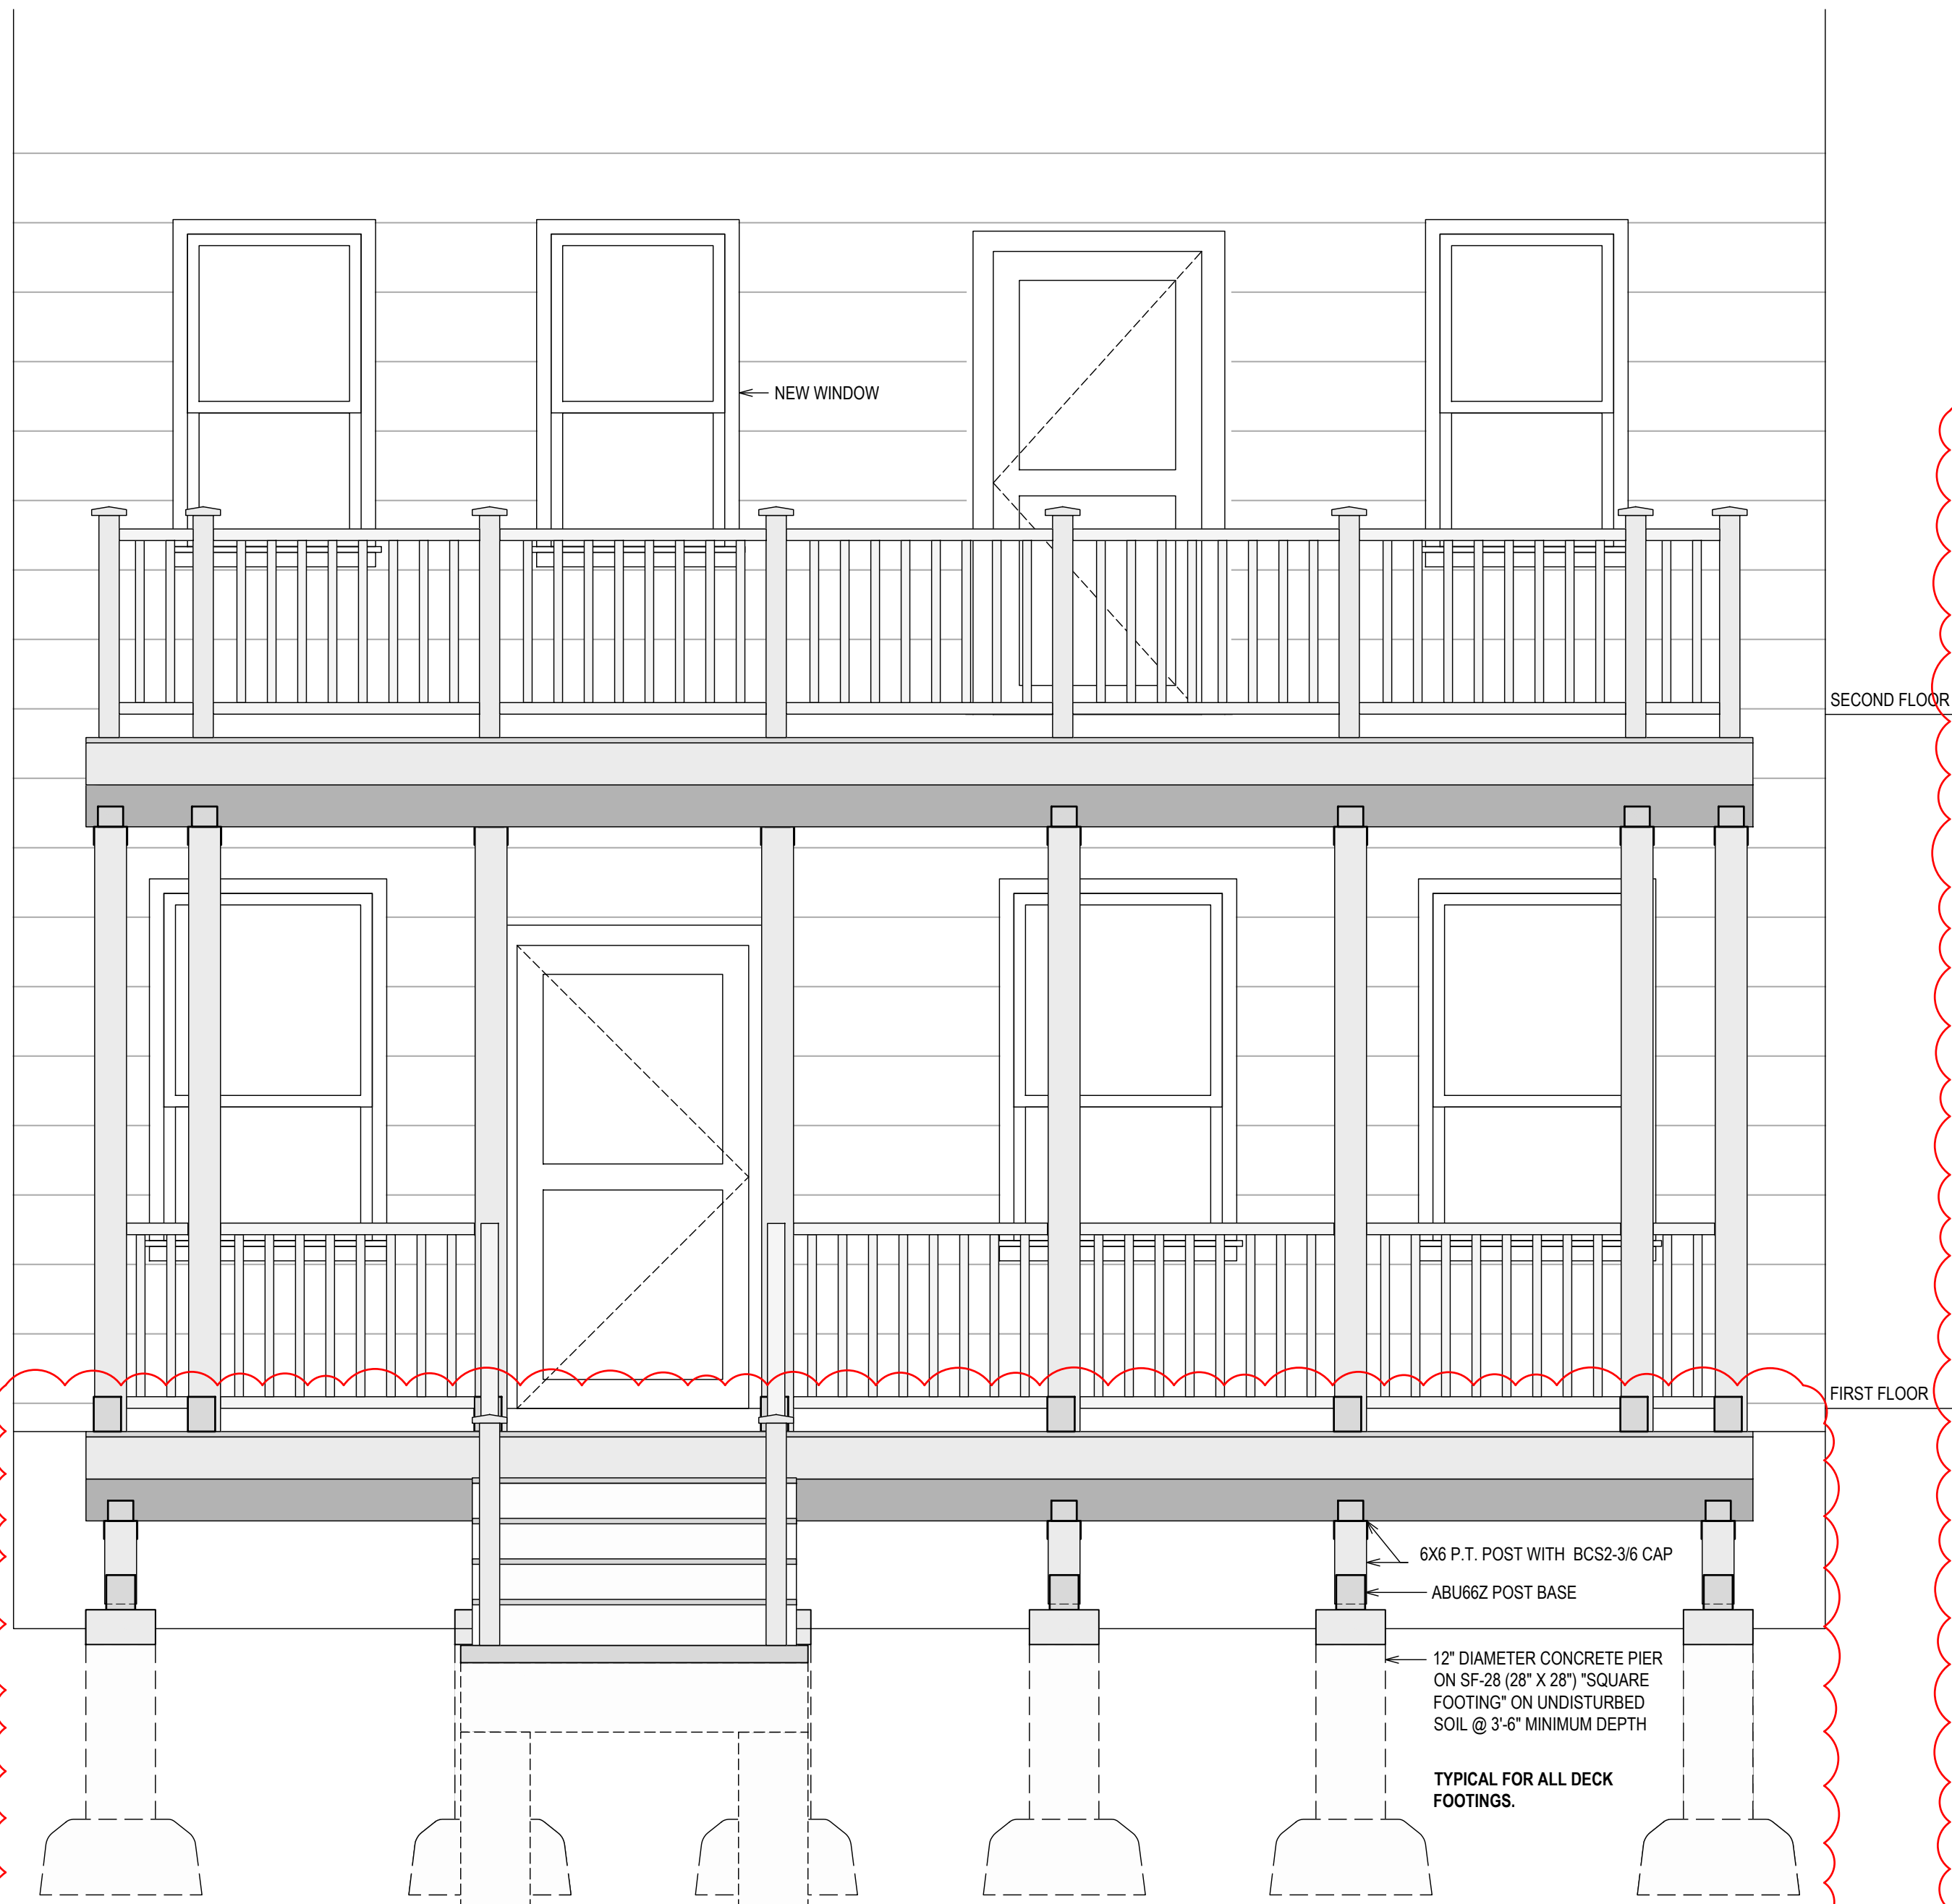

REAR ELEVATION

1/2" = 1'-0"

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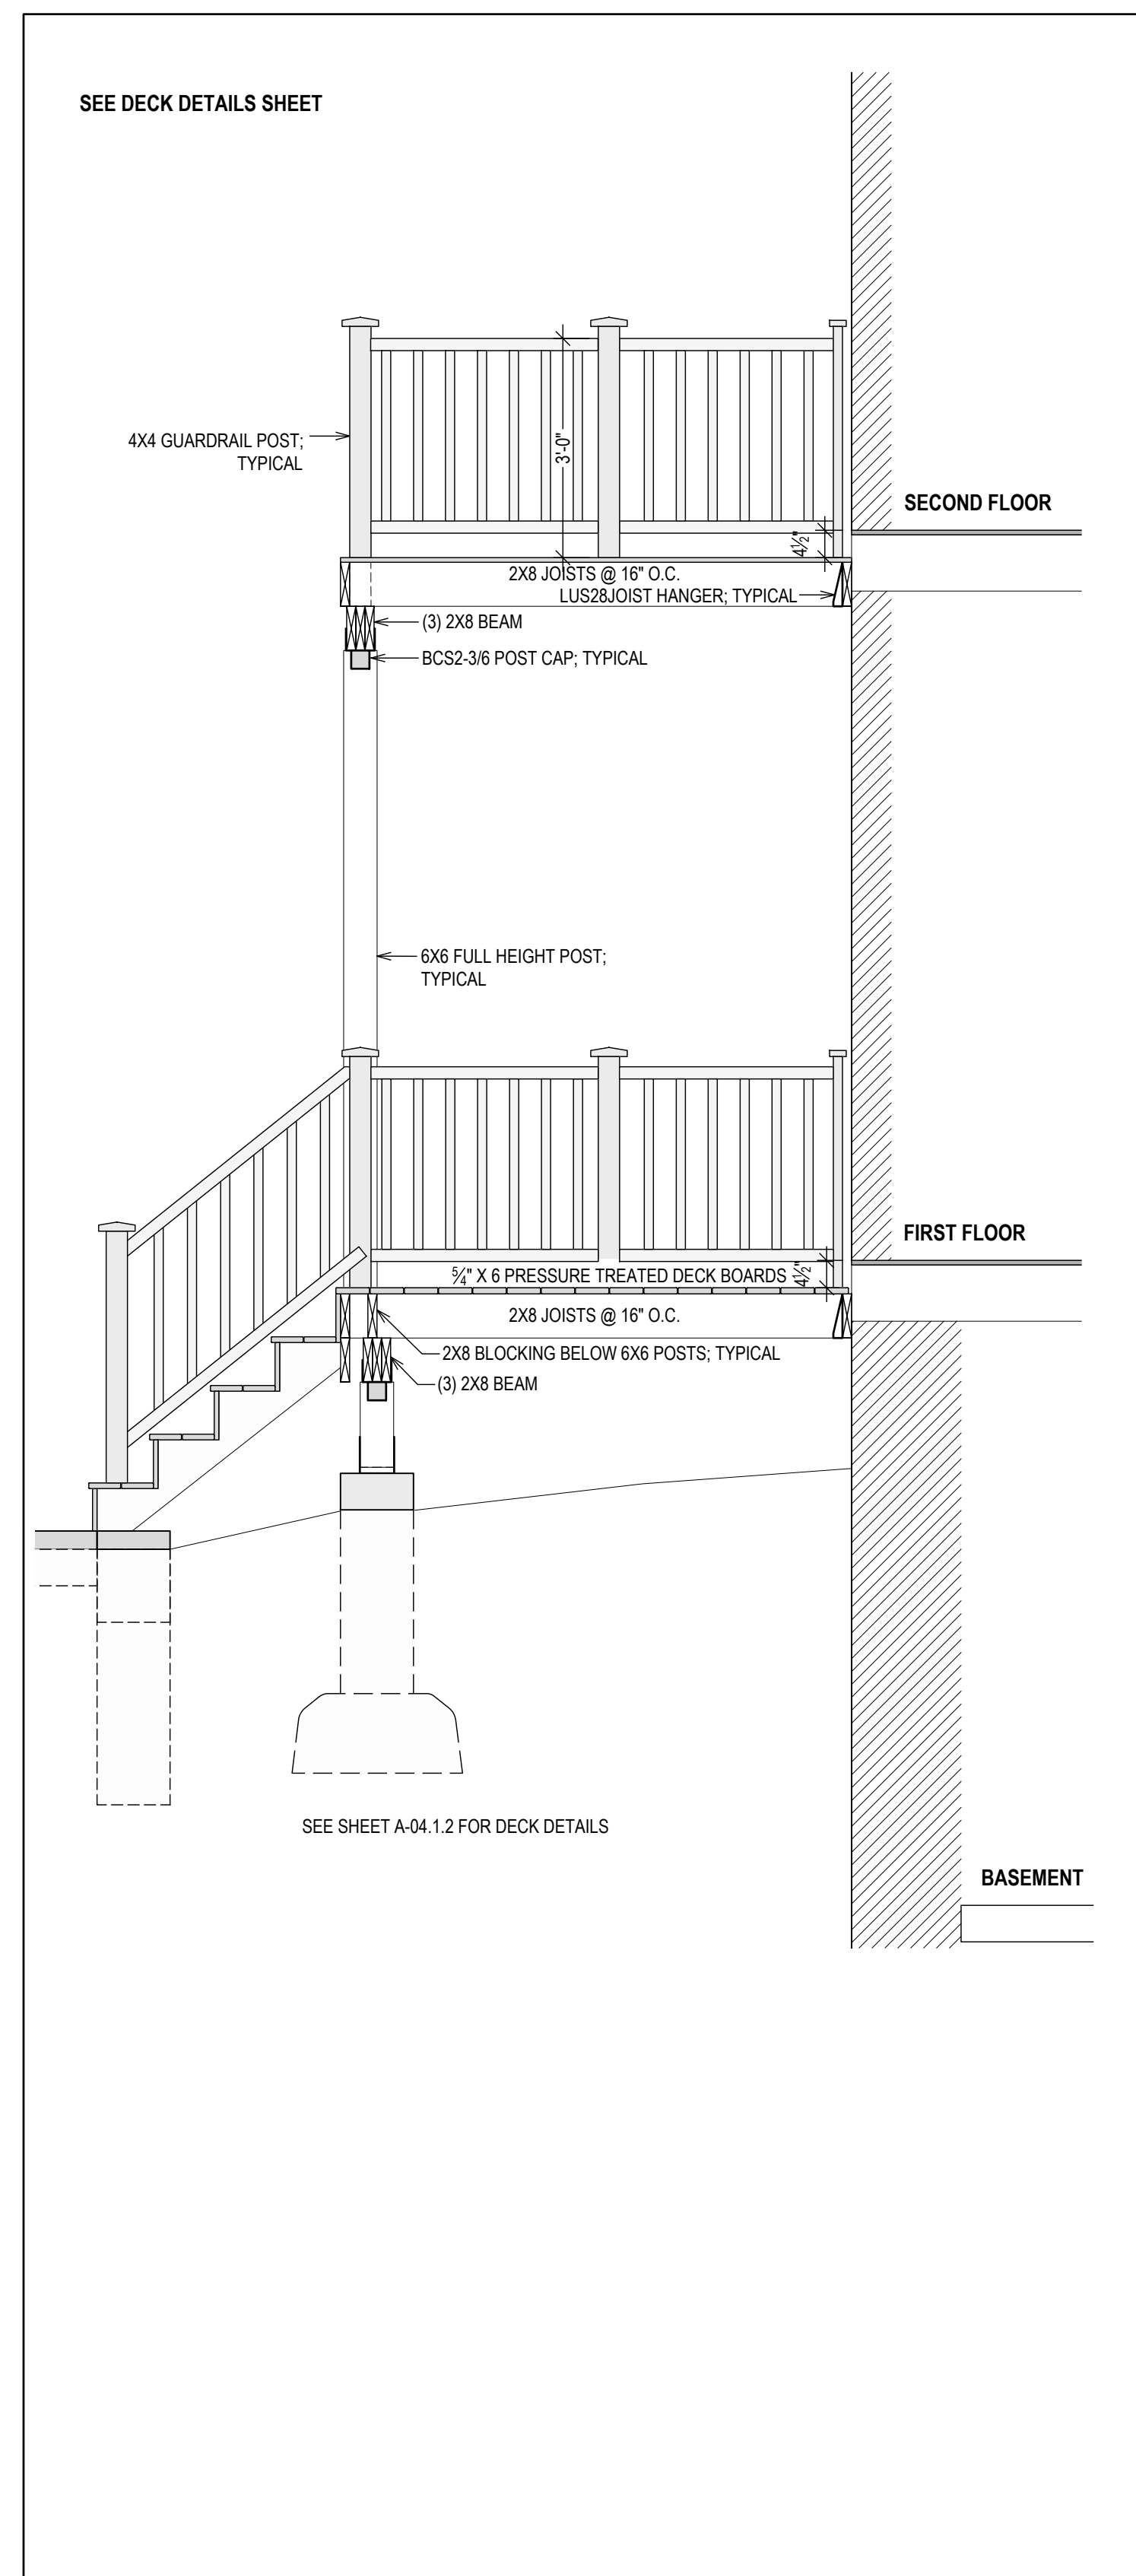
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SECTIONS

DRAWING NUMBER:
A-03.1


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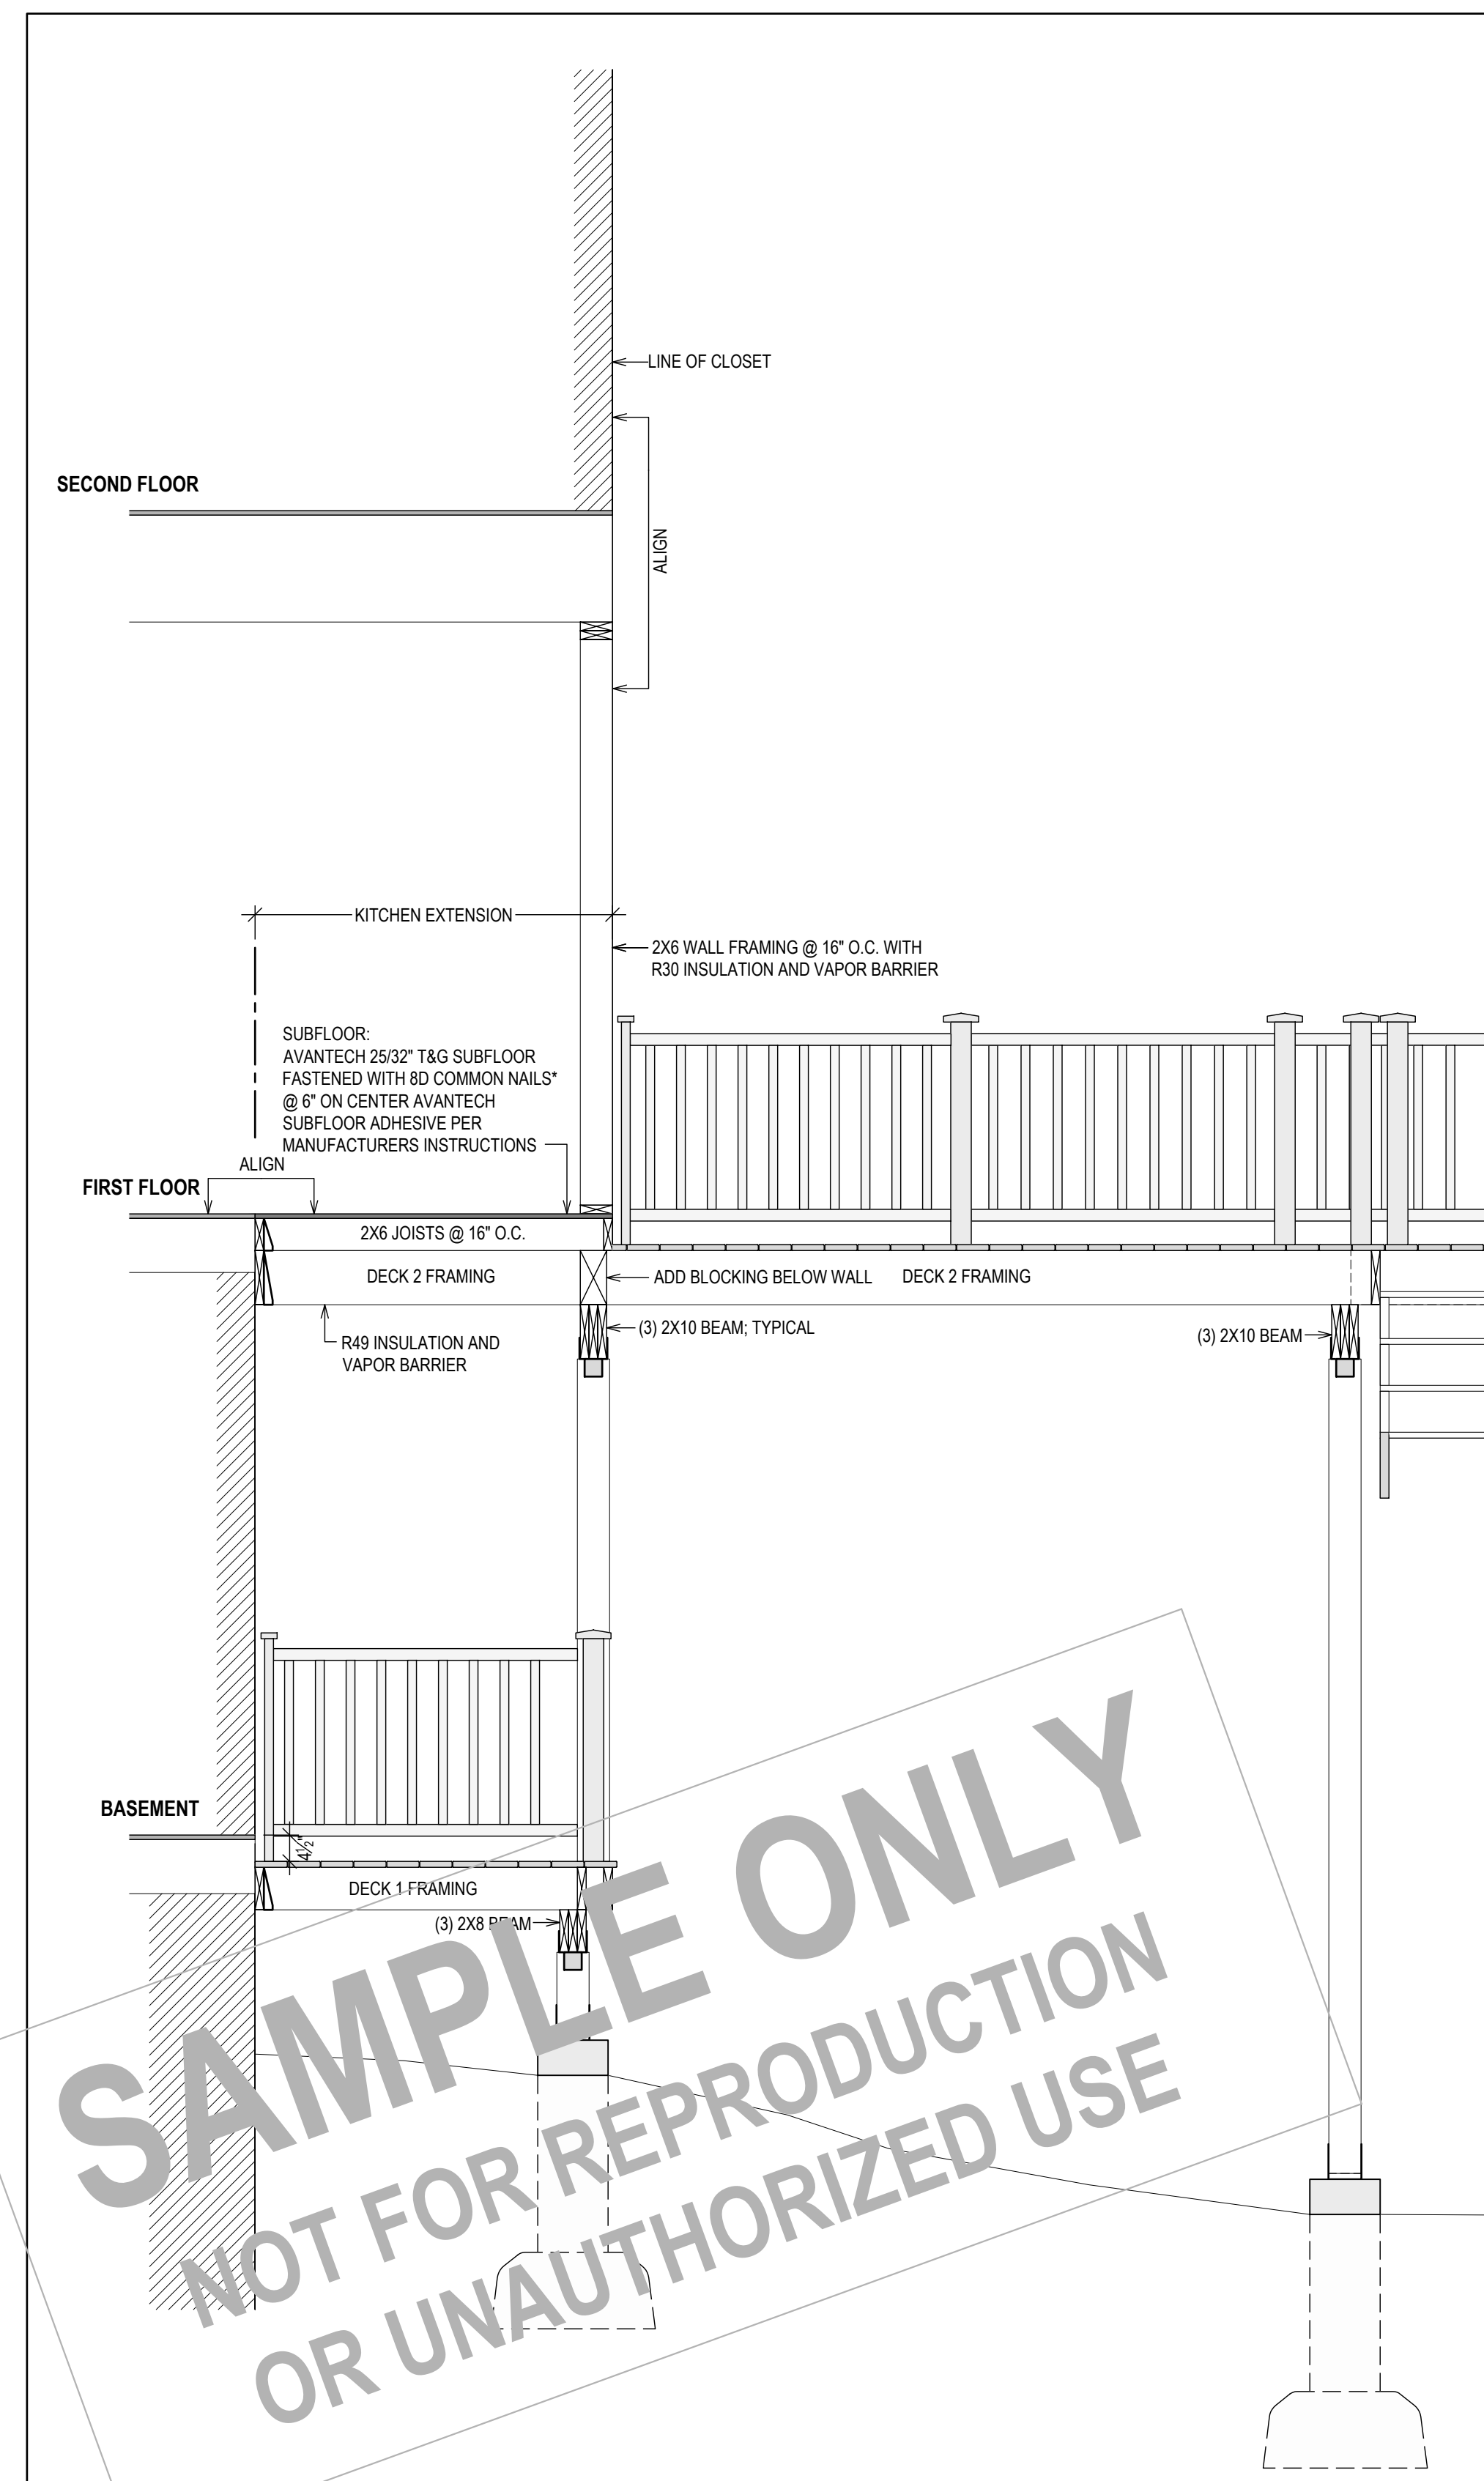
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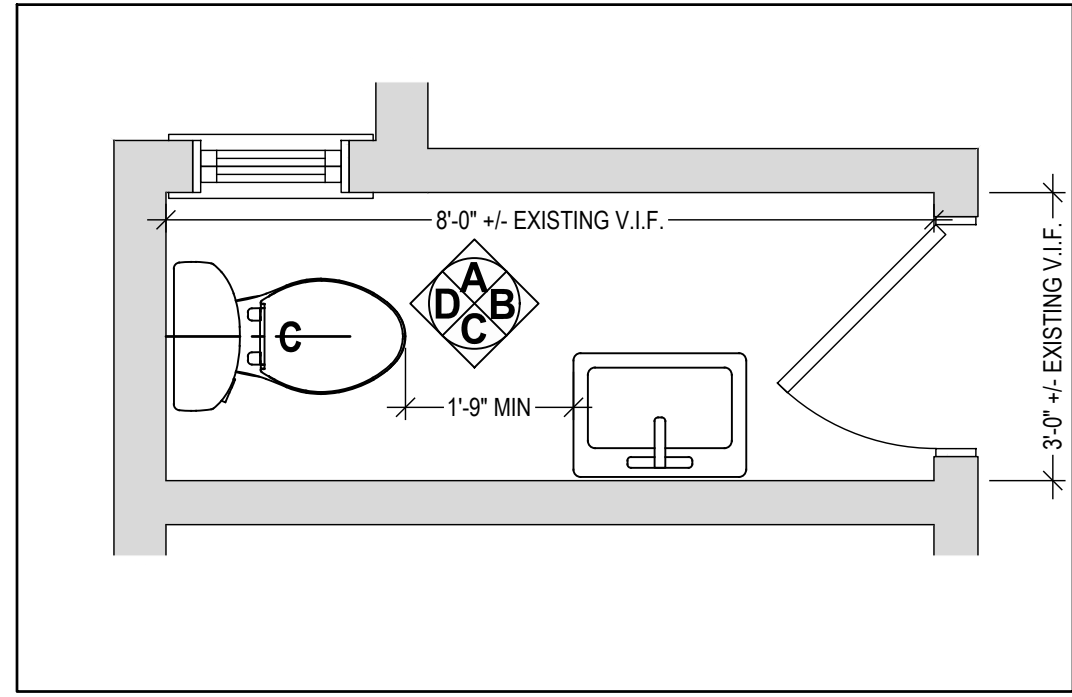
SECTION A: FRONT DECK
 $\frac{1}{2}" = 1'-0"$




SECTION B: REAR DECK
 $\frac{1}{2}" = 1'-0"$




SECTION C: REAR DECK
1/2" = 1'-0"

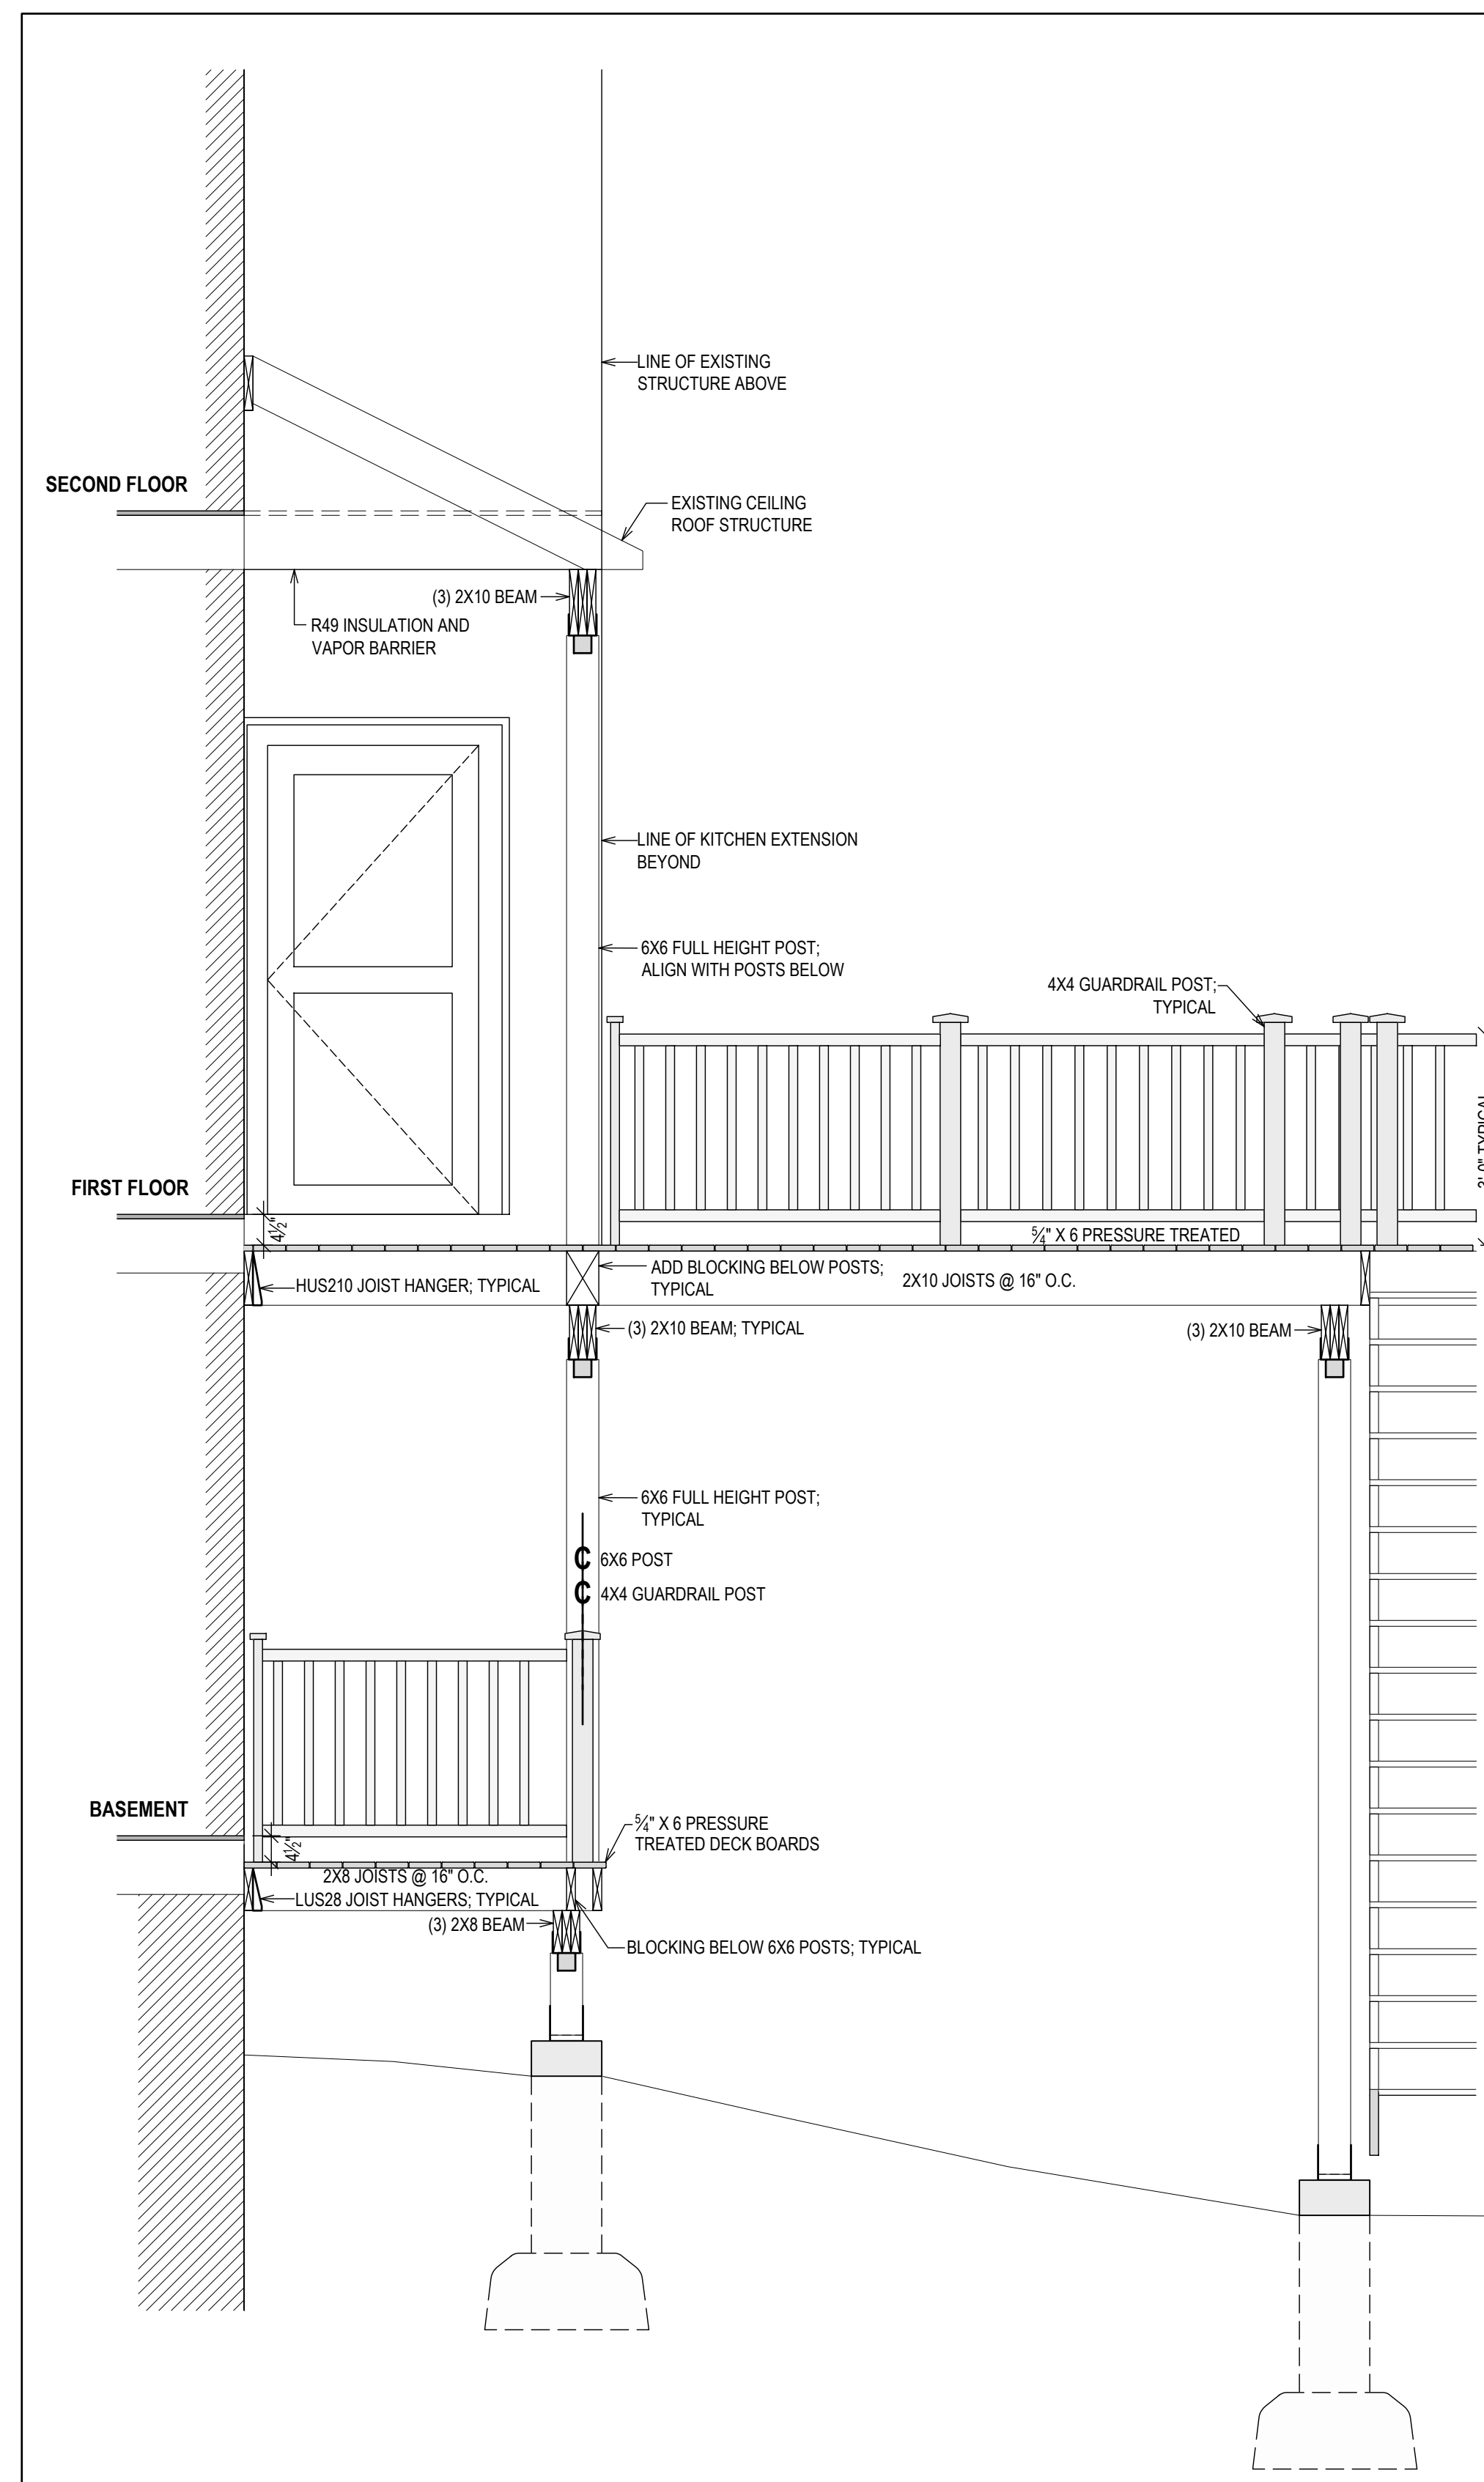


NEW POWDER ROOM LAYOUT
1/2" = 1'-0"

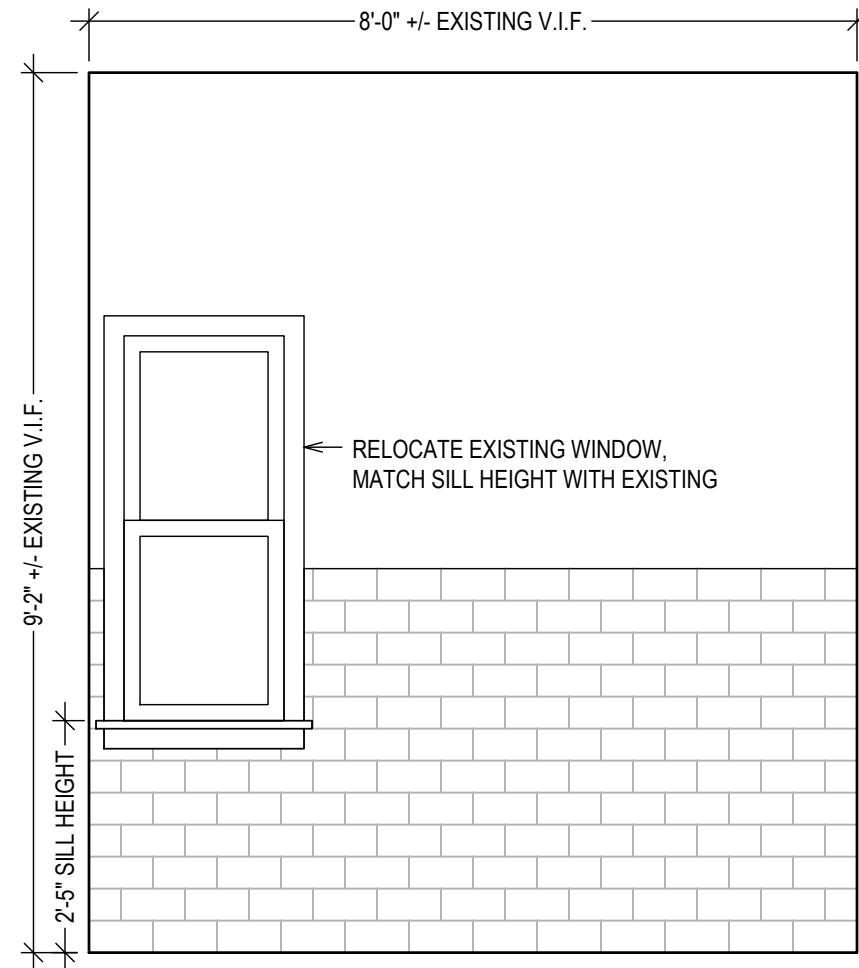


ELEVATION A
1/2" = 1'-0"

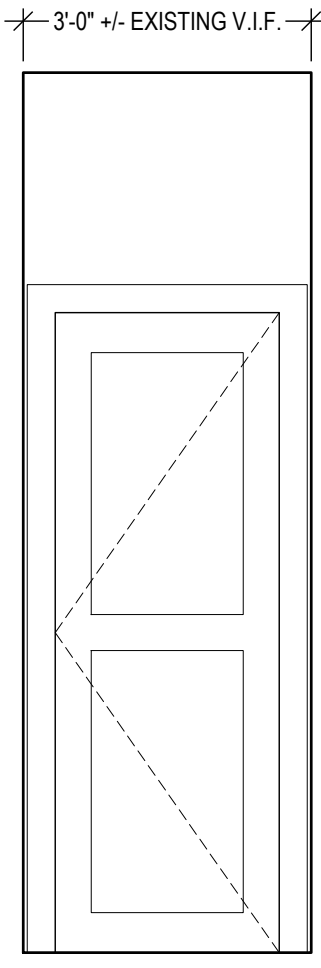


ELEVATION B
1/2" = 1'-0"

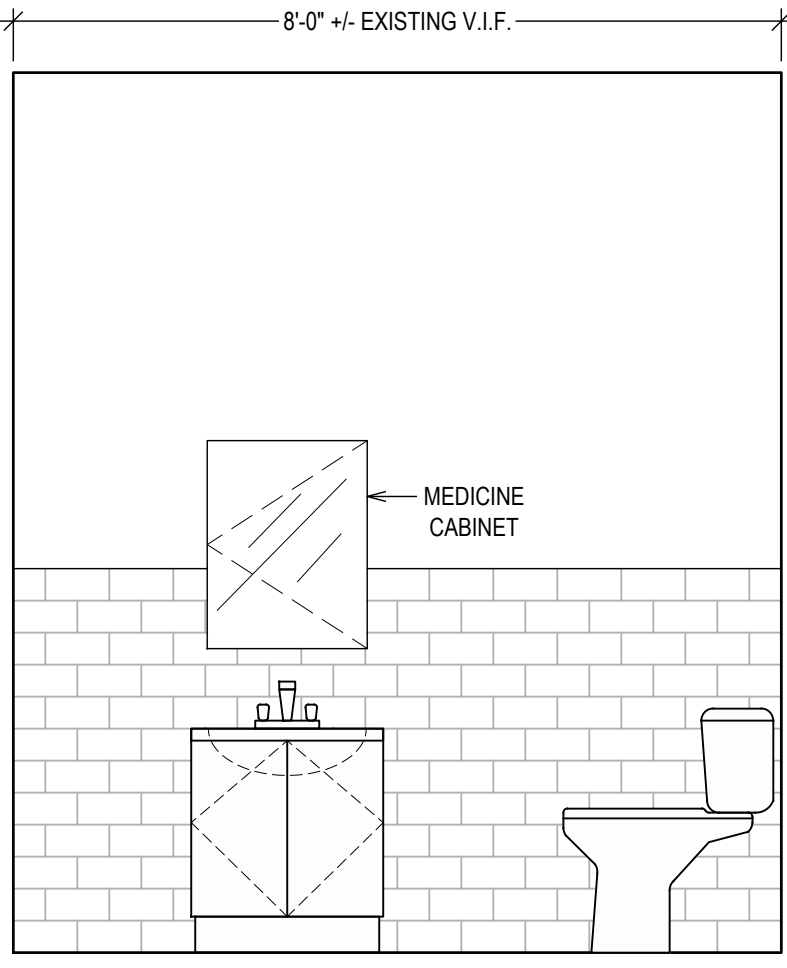


ELEVATION C
1/2" = 1'-0"

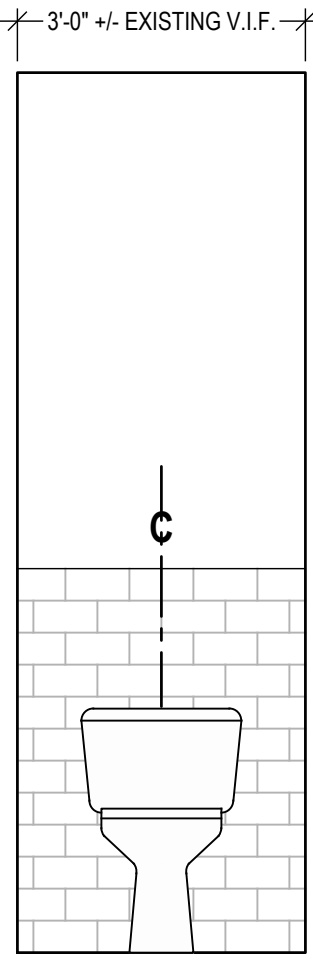


ELEVATION D
1/2" = 1'-0"

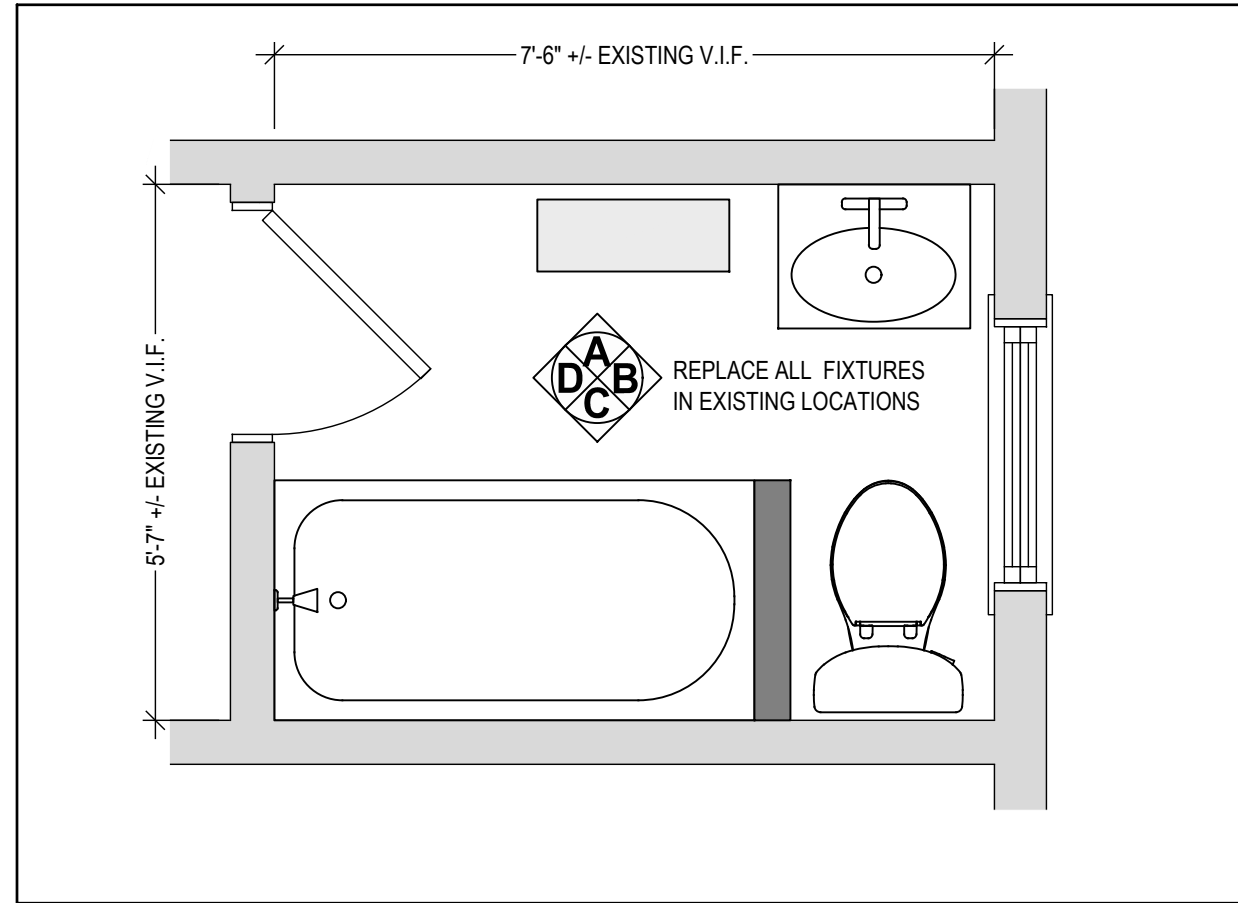


HALL BATHROOM LAYOUT
1/2" = 1'-0"

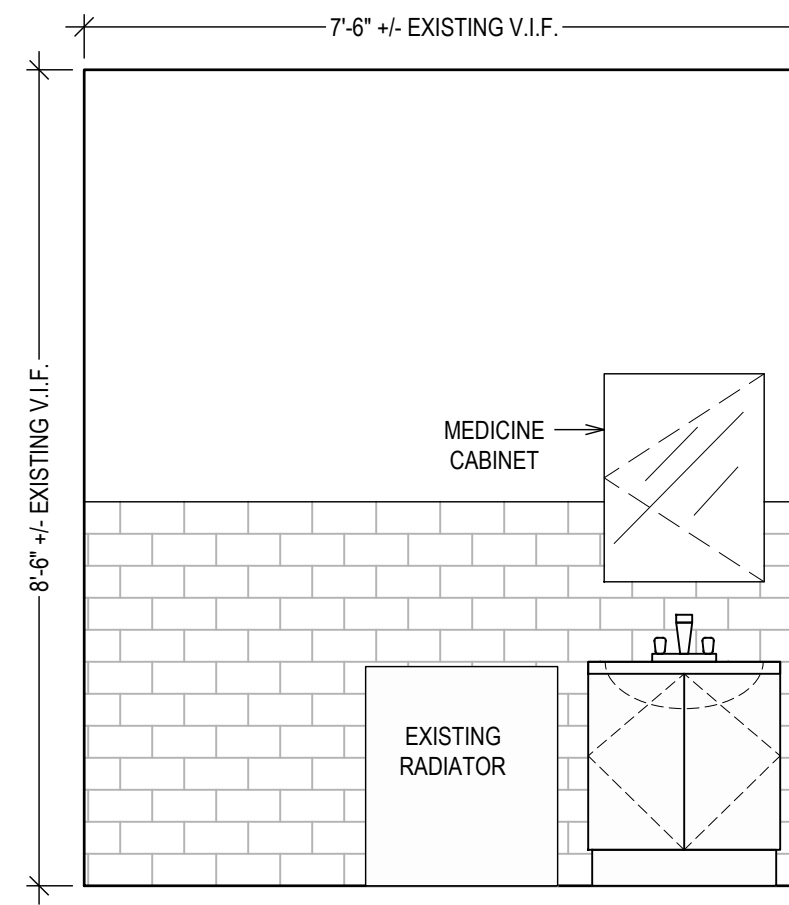


ELEVATION A
1/2" = 1'-0"

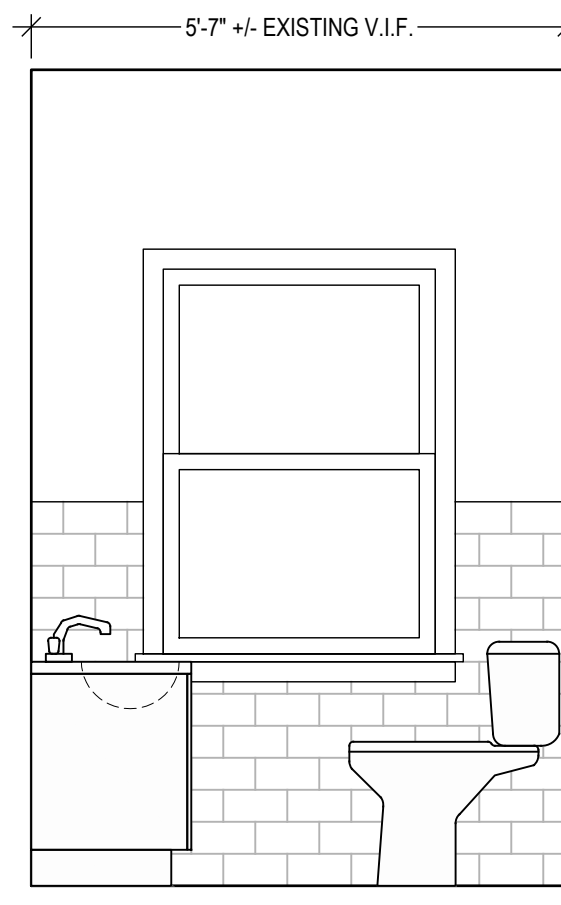


ELEVATION B
1/2" = 1'-0"

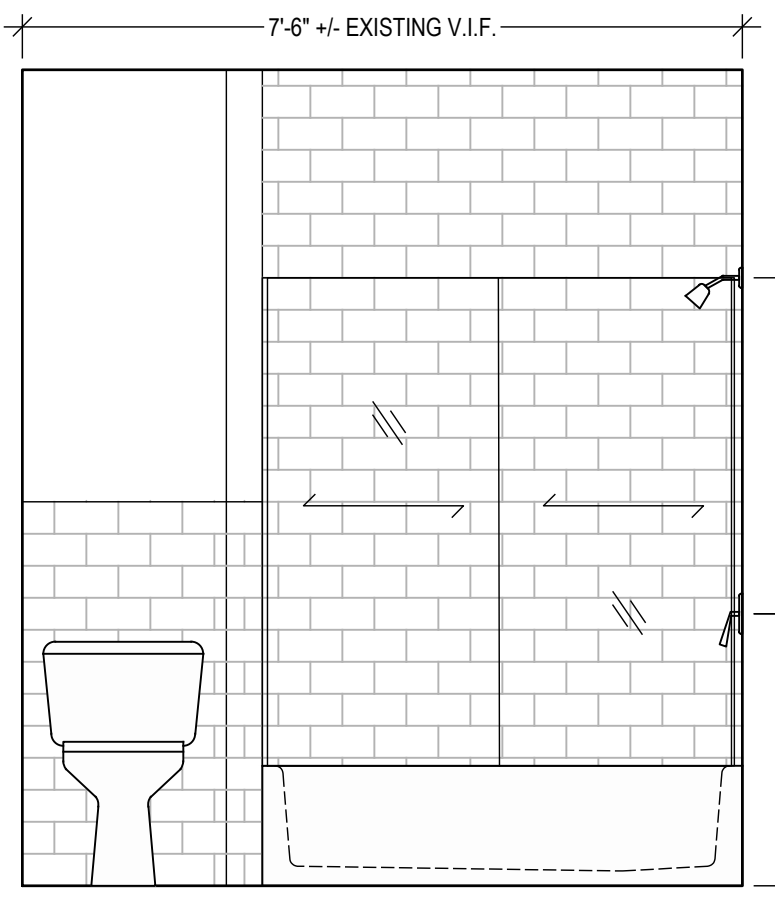


ELEVATION C
1/2" = 1'-0"

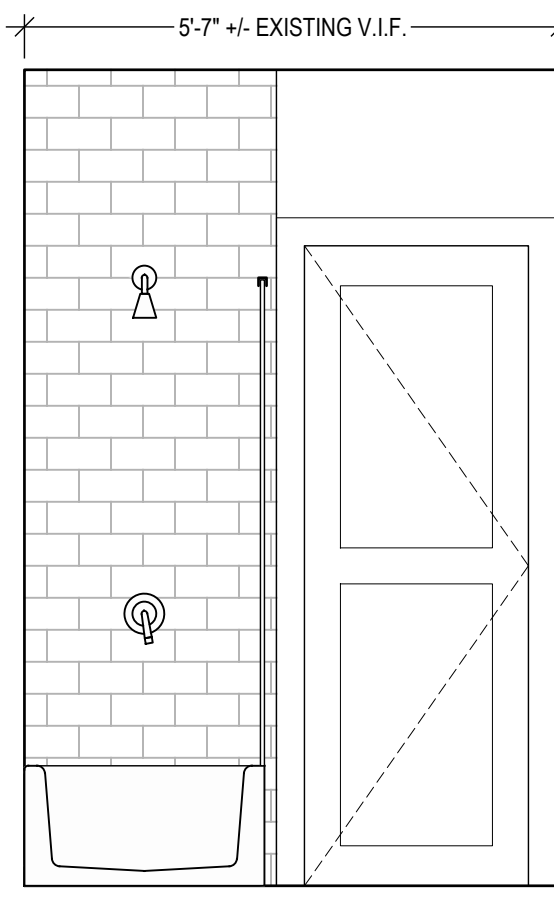


ELEVATION D
1/2" = 1'-0"

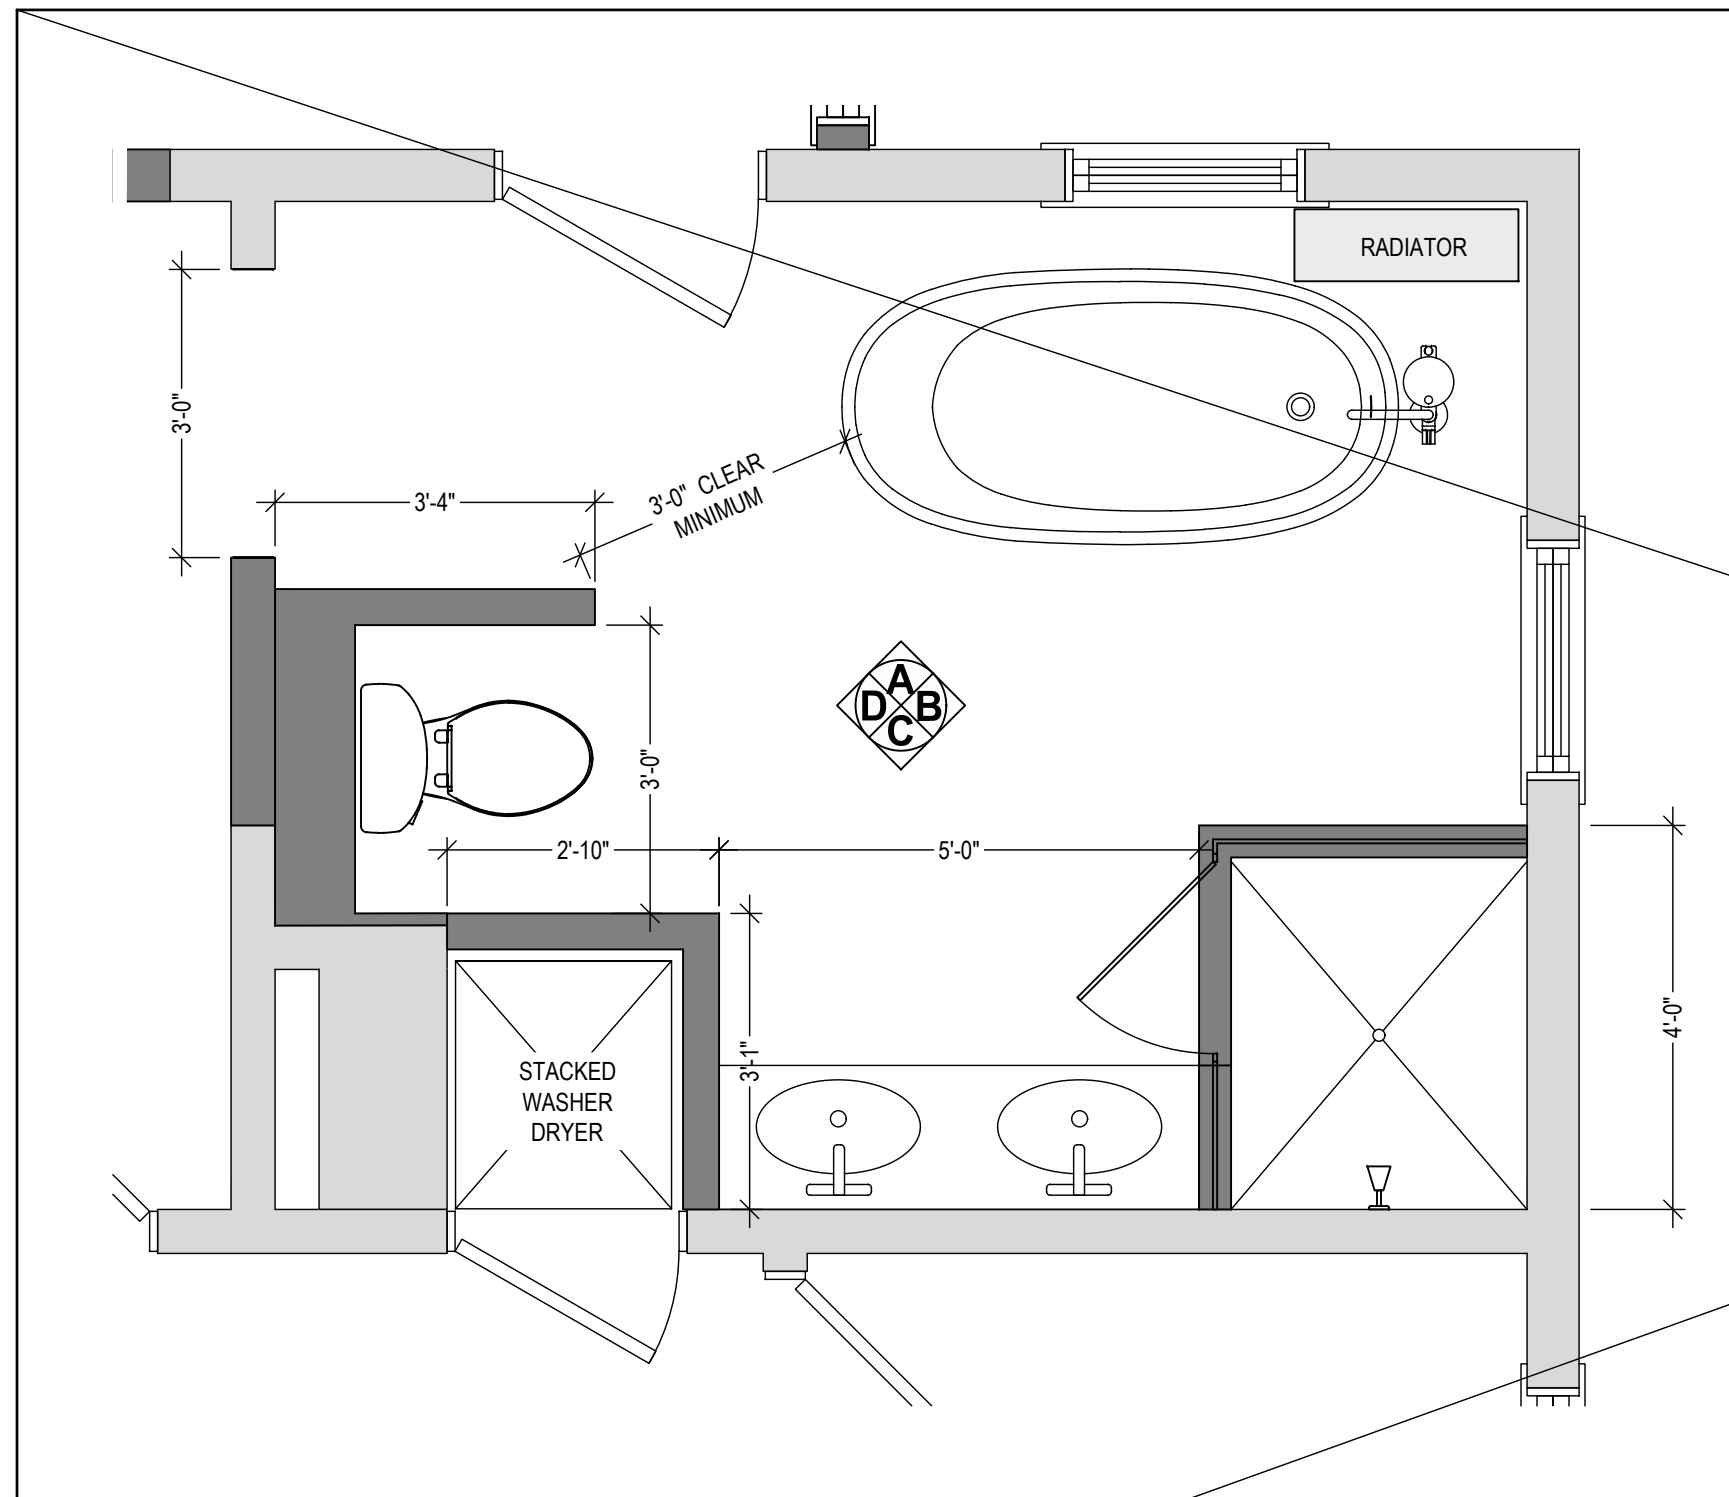


NEW MASTER BATHROOM LAYOUT
1/2" = 1'-0"

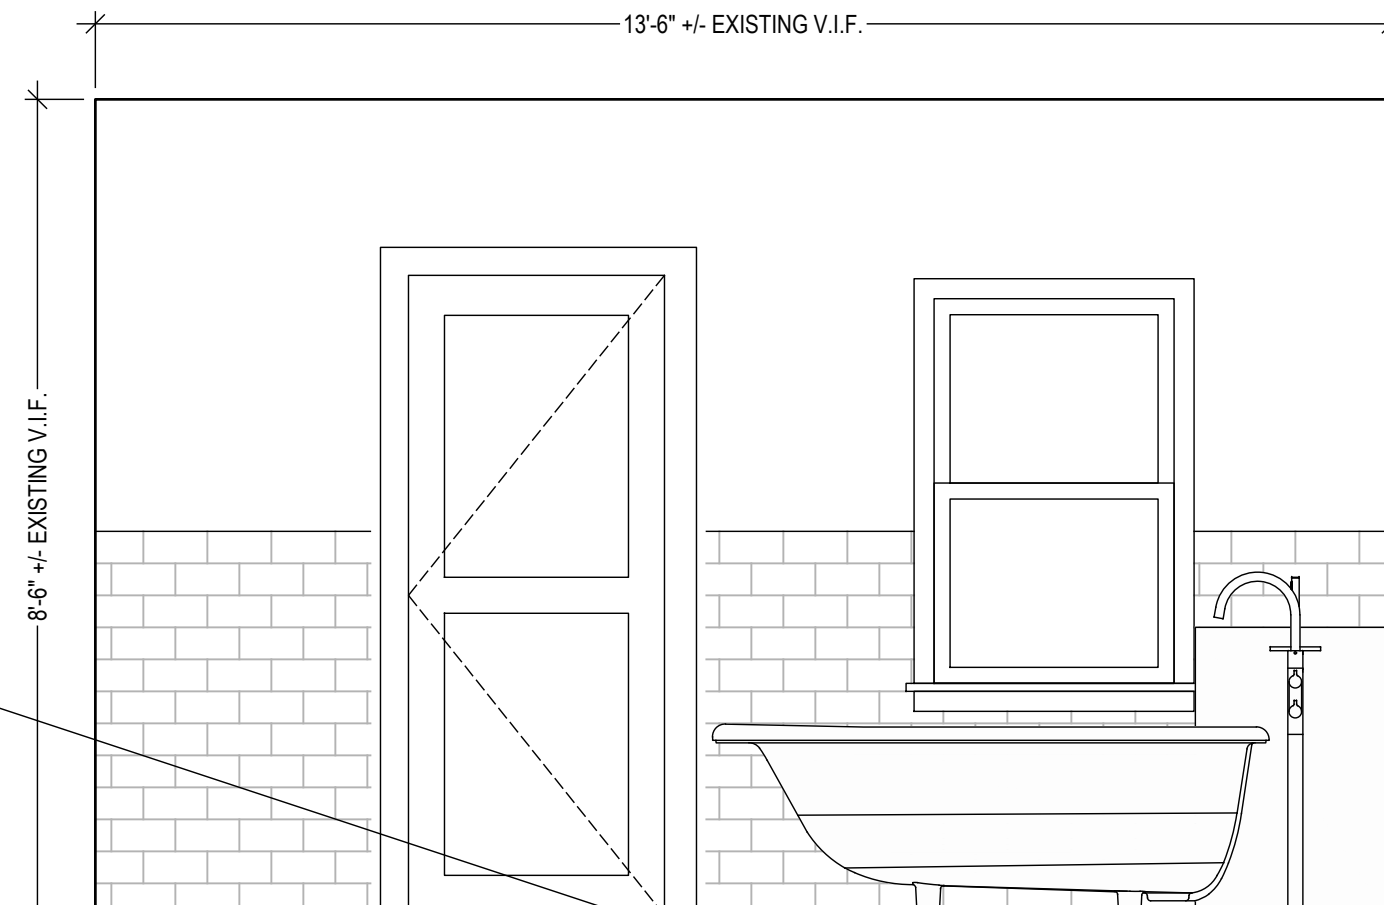


ELEVATION A
1/2" = 1'-0"

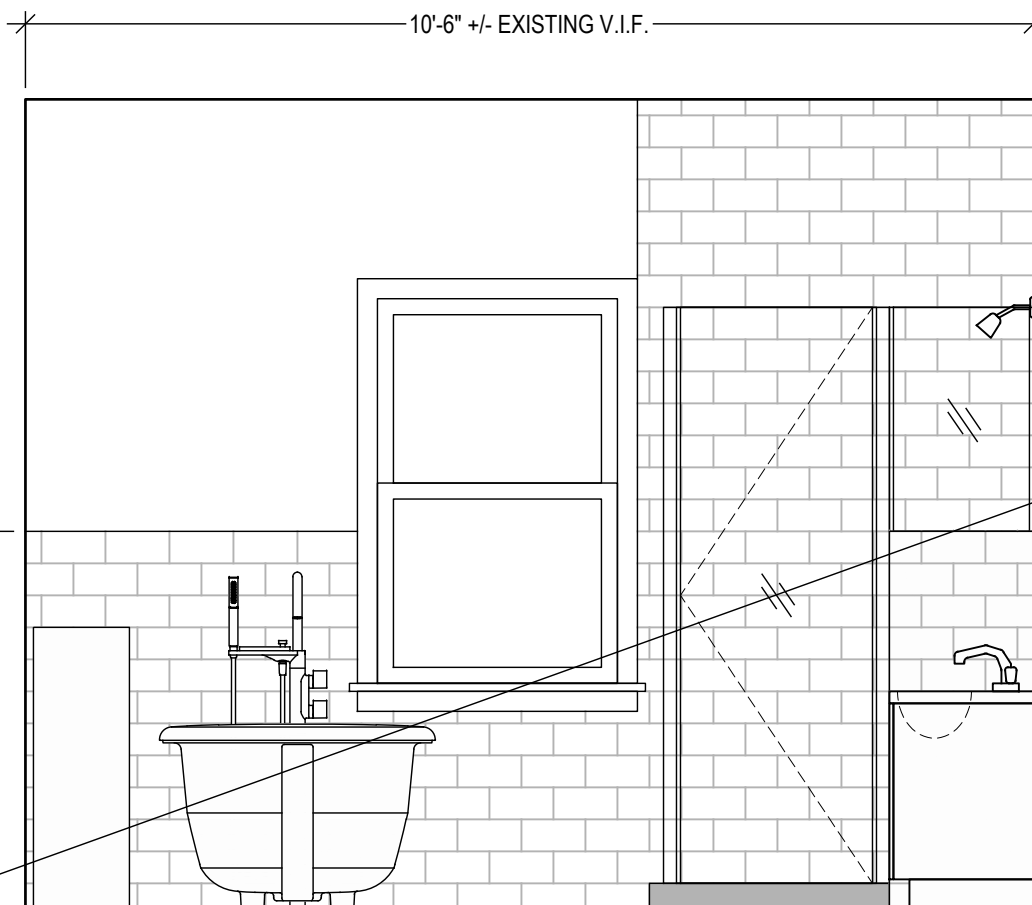

ELEVATION B
1/2" = 1'-0"

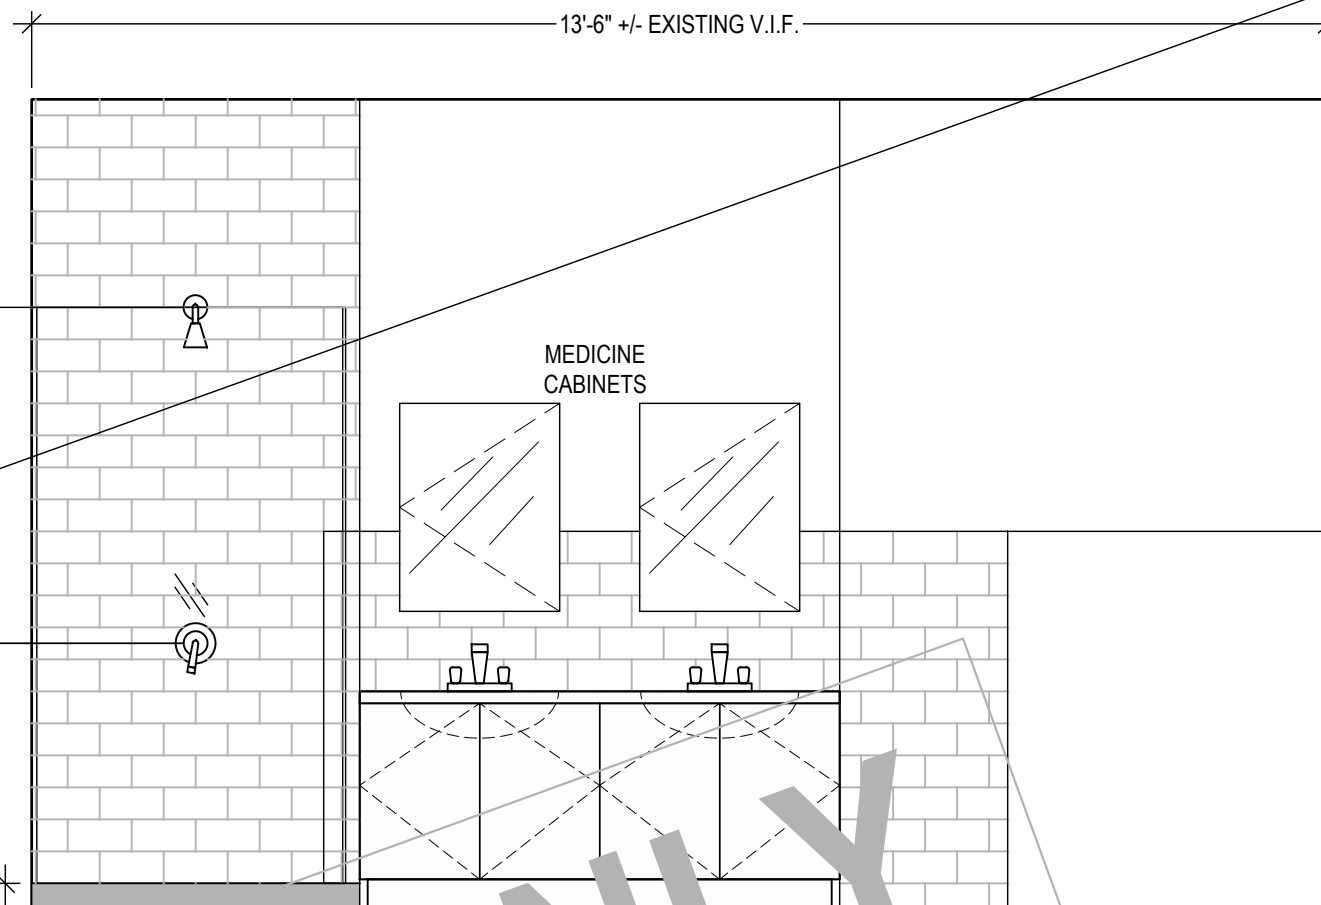

ELEVATION C
1/2" = 1'-0"

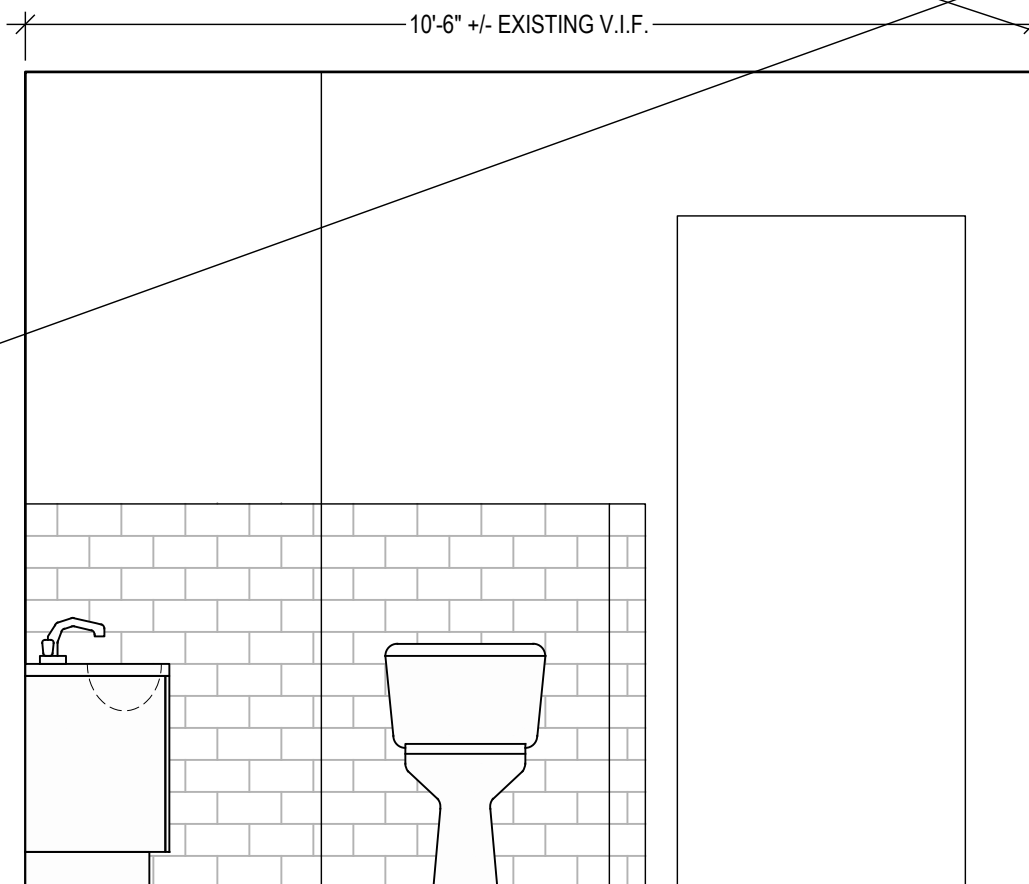

ELEVATION D
1/2" = 1'-0"

NOTE:
-VERIFY ALL DIMENSIONS IN FIELD
-SEE SHEET A-06.1 FOR BATHROOM CLEARANCES.
-SEE SHEET A-06.2 FOR FINISHES.
-SEE SHEET E-01 AND E-02 FOR ELECTRICAL PLAN.

SAMPLE ONLY
NOT FOR REPRODUCTION
OR UNAUTHORIZED USE

PROPERTY ADDRESS:

PORT CHESTER, NY 10573
(VILLAGE OF PORT CHESTER
BUILDING DEPARTMENT)

S-B-L:

CLIENT:
*** ***

TEL: ***
EMAIL: ***

DATE: 05.15.2025
07.23.2025
08.15.2025
ISSUE: PRELIMINARY
FOR PERMIT
FOR PERMIT

PROJECT NAME:
FLOOR PLAN ALTERATION


DRAWING NAME:
BATHROOM

DRAWING NUMBER:
A-04.1.1

DATE:
05.15.2025

SCALE:
AS NOTED

NOTE:
THIS DRAWING IS VALID FOR
CONSTRUCTION IF (AND ONLY IF) A
PERMIT IS ISSUED, BASED ON THIS
DRAWING, BY THE VILLAGE OF PORT
CHESTER.

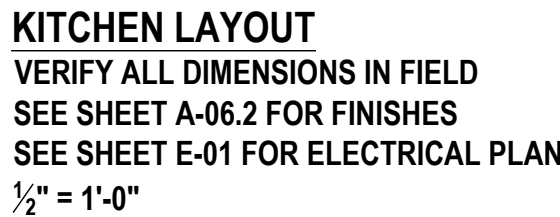

1. ALL PLUMBING WORK IS TO BE:
 - PERFORMED BY A PLUMBER LICENSED TO WORK IN WESTCHESTER COUNTY AND IN THE VILLAGE OF PORT CHESTER.
 - COMPLETED PER PART VII OF THE 2017 NATIONAL ELECTRICAL CODE (NFPA 70-2017).
 - FILED UNDER A SEPARATE PERMIT.
 - INSPECTED PER THE REQUIREMENTS OF THE BUILDING DEPARTMENT, AND BUILDING OFFICIAL OF VILLAGE OF PORT CHESTER.
2. ALL ABANDONED PIPING MUST BE REMOVED TO A POINT OF CONCEALMENT AND PROPERLY CAPPED.
3. ALL EXPOSED EXISTING AND NEW HOT AND COLD WATER AND HEATING PIPES MUST BE PROPERLY INSULATED.
4. ALL MATERIALS USED SHALL BE NEW, BEST OF THEIR RESPECTIVE BRANDS AND CONFORM TO THE REQUIREMENTS OF ALL STATE AND LOCAL AUTHORITIES HAVING JURISDICTION.

ADDITIONS, ALTERATIONS, RENOVATIONS OR REPAIRS TO ANY PLUMBING SYSTEM SHALL CONFORM TO THAT REQUIRED FOR A NEW PLUMBING SYSTEM WITHOUT REQUIRING THE EXISTING PLUMBING SYSTEM TO COMPLY WITH THE REQUIREMENTS OF THIS CODE. ADDITIONS, ALTERATIONS OR REPAIRS SHALL NOT CAUSE AN EXISTING SYSTEM TO BECOME UNSAFE, UNSANITARY OR OVERLOADED. MINOR ADDITIONS, ALTERATIONS, RENOVATIONS AND REPAIRS TO EXISTING PLUMBING SYSTEMS SHALL BE PERMITTED IN THE SAME MANNER AND ARRANGEMENT AS IN THE EXISTING SYSTEM, PROVIDED THAT SUCH REPAIRS OR REPLACEMENT ARE NOT HAZARDOUS AND ARE APPROVED.

NEW PLUMBING WORK AND PARTS OF EXISTING SYSTEMS AFFECTED BY NEW YORK OR ALTERATIONS SHALL BE INSPECTED BY THE BUILDING OFFICIAL TO ENSURE COMPLIANCE WITH THE REQUIREMENTS OF THE CODE.

A PLUMBING OR DRAINAGE SYSTEM, OR PART THEREOF, SHALL NOT BE COVERED, CONCEALED OR PUT INTO USE UNTIL IT HAS BEEN TESTED, INSPECTED AND APPROVED BY THE BUILDING OFFICIAL. WASTE AND VENT SYSTEMS TESTING


ROUGH-IN AND FINISHED PLUMBING INSTALLATIONS OF DRAIN, WASTE AND VENT SYSTEMS SHALL BE TESTED IN ACCORDANCE WITH SECTIONS P2503.5.1 AND P2503.5.2 P2503.5.

WOOD-FRAMED STRUCTURAL MEMBERS SHALL NOT BE DRILLED, NOTCHED OR ALTERED IN ANY MANNER EXCEPT AS PROVIDED IN SECTIONS R502.8, R602.6, R802.7 AND R802.7.1.

DWV SYSTEMS SHALL BE TESTED ON COMPLETION OF THE ROUGH PIPING INSTALLATION BY WATER OR, FOR PIPING SYSTEMS OTHER THAN PLASTIC, BY AIR, WITHOUT EVIDENCE OF LEAKAGE. EITHER TEST SHALL BE APPLIED TO THE DRAINAGE SYSTEM IN ITS ENTIRETY OR IN SECTIONS AFTER ROUGH-IN PIPING HAS BEEN INSTALLED, AS FOLLOWS:

EACH SECTION SHALL BE FILLED WITH WATER TO A POINT NOT LESS THAN 5'-0" ABOVE THE HIGHEST FITTING CONNECTION IN THAT SECTION, OR TO THE HIGHEST POINT IN THE COMPLETED SYSTEM. WATER SHALL BE HELD IN THE SECTION UNDER TEST FOR A PERIOD OF 15 MINUTES. THE SYSTEM SHALL PROVE LEAK FREE BY VISUAL INSPECTION.

THE PORTION UNDER TEST SHALL BE MAINTAINED AT A GAUGE PRESSURE OF 5 POUNDS PER SQUARE INCH (PSI) OR 10" OF MERCURY COLUMN. THIS PRESSURE SHALL BE HELD WITHOUT INTRODUCTION OF ADDITIONAL AIR FOR A PERIOD OF 15 MINUTES.

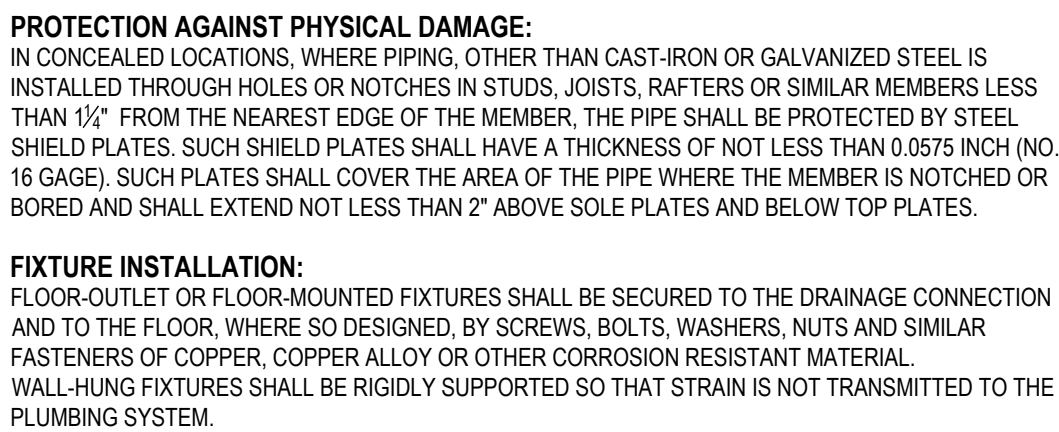


The diagram illustrates the protection of piping against physical damage in concealed spaces. It shows three scenarios:


- Top Scenario:** A pipe is shown in a concealed wall space. A label indicates: "Pipe in concealed wall space $\leq 1-1/2''$ from edge of member". A red circle highlights the pipe, and a label states: "Protection must extend to cover the area where the member is notched or bored".
- Middle Scenario:** A pipe is shown in a concealed ceiling/floor space. A label indicates: "Pipe in concealed ceiling/floor space". A label states: "Protection must extend 2'' min above sole plates".
- Bottom Scenario:** A pipe is shown in a concealed ceiling/floor space. A label indicates: "Pipe in concealed ceiling/floor space". A label states: "Protection must extend 2'' min below top plates".

Additional labels include:

- "When less than 1-1/2'' protection is required" (with a small figure icon).
- "Protective steel plate, 0.0575'' min thickness (16 gage)".
- "Applies to pipes other than cast-iron or steel in concealed locations".

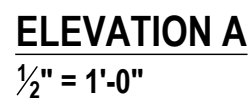

EXCEPTION: MAKEUP AIR IS NOT REQUIRED FOR EXHAUST SYSTEMS INSTALLED FOR THE EXCLUSIVE PURPOSE OF SPACE COOLING AND INTENDED TO BE OPERATED ONLY WHEN WINDOWS OR OTHER AIR INLETS ARE OPEN.

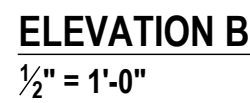

KITCHEN EXHAUST MAKEUP AIR SHALL BE DISCHARGED INTO THE SAME ROOM IN WHICH THE EXHAUST SYSTEM IS LOCATED OR INTO ROOMS OR DUCT SYSTEMS THAT COMMUNICATE THROUGH ONE OR MORE PERMANENT OPENINGS WITH THE ROOM IN WHICH SUCH EXHAUST SYSTEM IS LOCATED. SUCH PERMANENT OPENINGS SHALL HAVE A NET CROSS-SECTIONAL AREA NOT LESS THAN THE REQUIRED AREA OF THE MAKEUP AIR SUPPLY OPENINGS.


WHERE MAKEUP AIR IS REQUIRED BY SECTION M1503.6, MAKEUP AIR DAMPERS SHALL COMPLY WITH THIS SECTION. EACH DAMPER SHALL BE A GRAVITY DAMPER OR AN ELECTRICALLY OPERATED DAMPER THAT AUTOMATICALLY OPENS WHEN THE EXHAUST SYSTEM OPERATES. DAMPERS SHALL BE LOCATED TO ALLOW ACCESS FOR INSPECTION, SERVICE, REPAIR AND REPLACEMENT WITHOUT REMOVING PERMANENT CONSTRUCTION OR ANY OTHER DUCTS NOT CONNECTED TO THE DAMPER. INSPECTED, SERVICED, REPAIRED OR REPLACED GRAVITY OR ELECTRIC DAMPERS SHALL NOT BE USED IN PASSIVE MAKEUP AIR SYSTEMS EXCEPT WHERE THE DAMPERS ARE RATED TO PROVIDE THE DESIGN MAKEUP AIRFLOW AT A PRESSURE DIFFERENTIAL OF 0.01 IN. W.G. (3 PA) OR LESS.

AIR EXHAUST OPENINGS SHALL TERMINATE AS FOLLOWS:


NOT LESS THAN 3 FEET (914 MM) FROM PROPERTY LINES.

NOT LESS THAN 3 FEET (914 MM) FROM GRAVITY AIR INTAKE OPENINGS, DOORWAYS, WINDOWS AND DOORS.


NOT LESS THAN 10 FEET (3048 MM) FROM MECHANICAL AIR INTAKE OPENINGS, EXCEPT WHERE THE EXHAUST OPENING IS LOCATED NOT LESS THAN 3 FEET (914 MM) ABOVE THE AIR INTAKE OPENING.

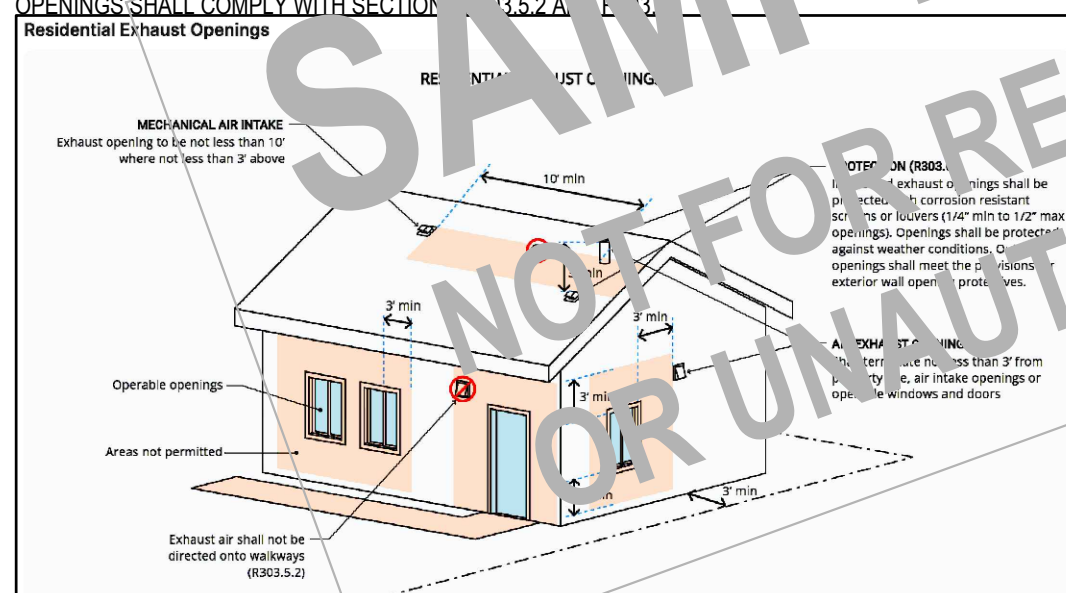



DO NOT SCALE DRAWINGS | THIS DRAWING IS SCALED TO PRINT ON AN ARCH D (24" X 36") SHEET

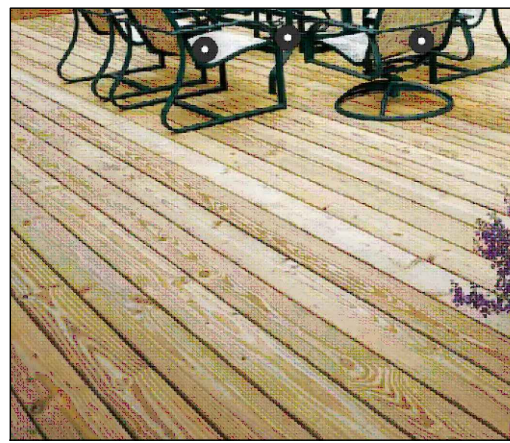


DECKING:
5/4" X 6" PRESSURE TREATED

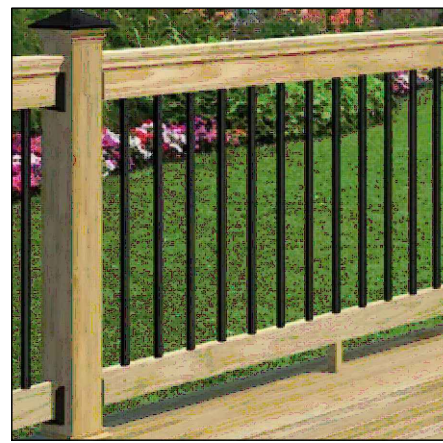


POSTS: PRESSURE TREATED 4X4; 6'-0" CENTER TO CENTER
RAILS: WOOD AND ALUMINUM RAIL KIT

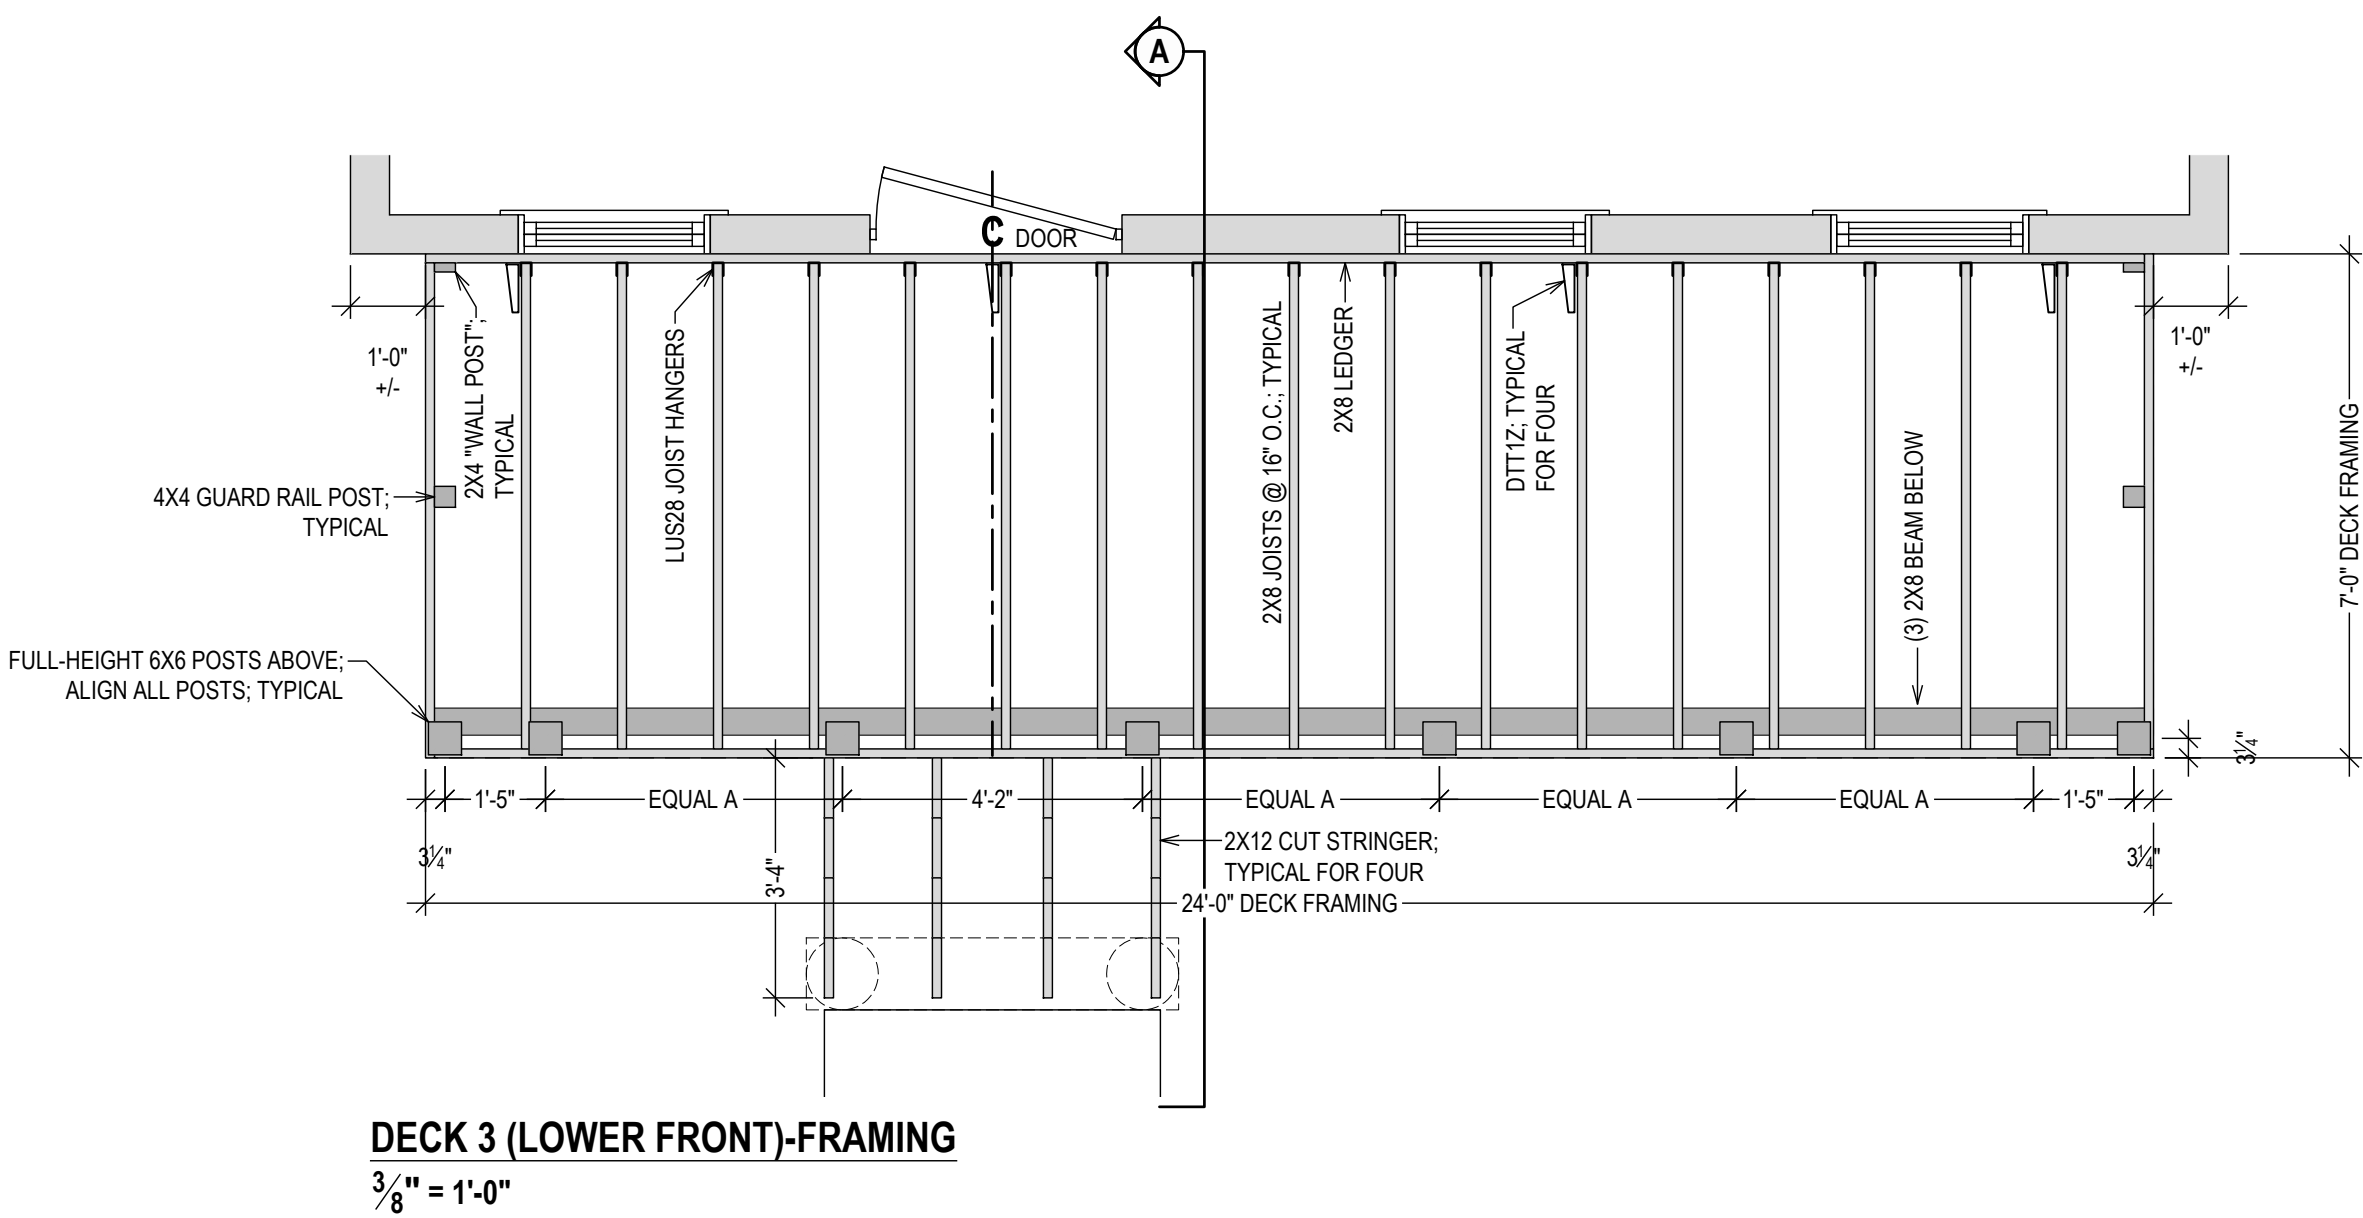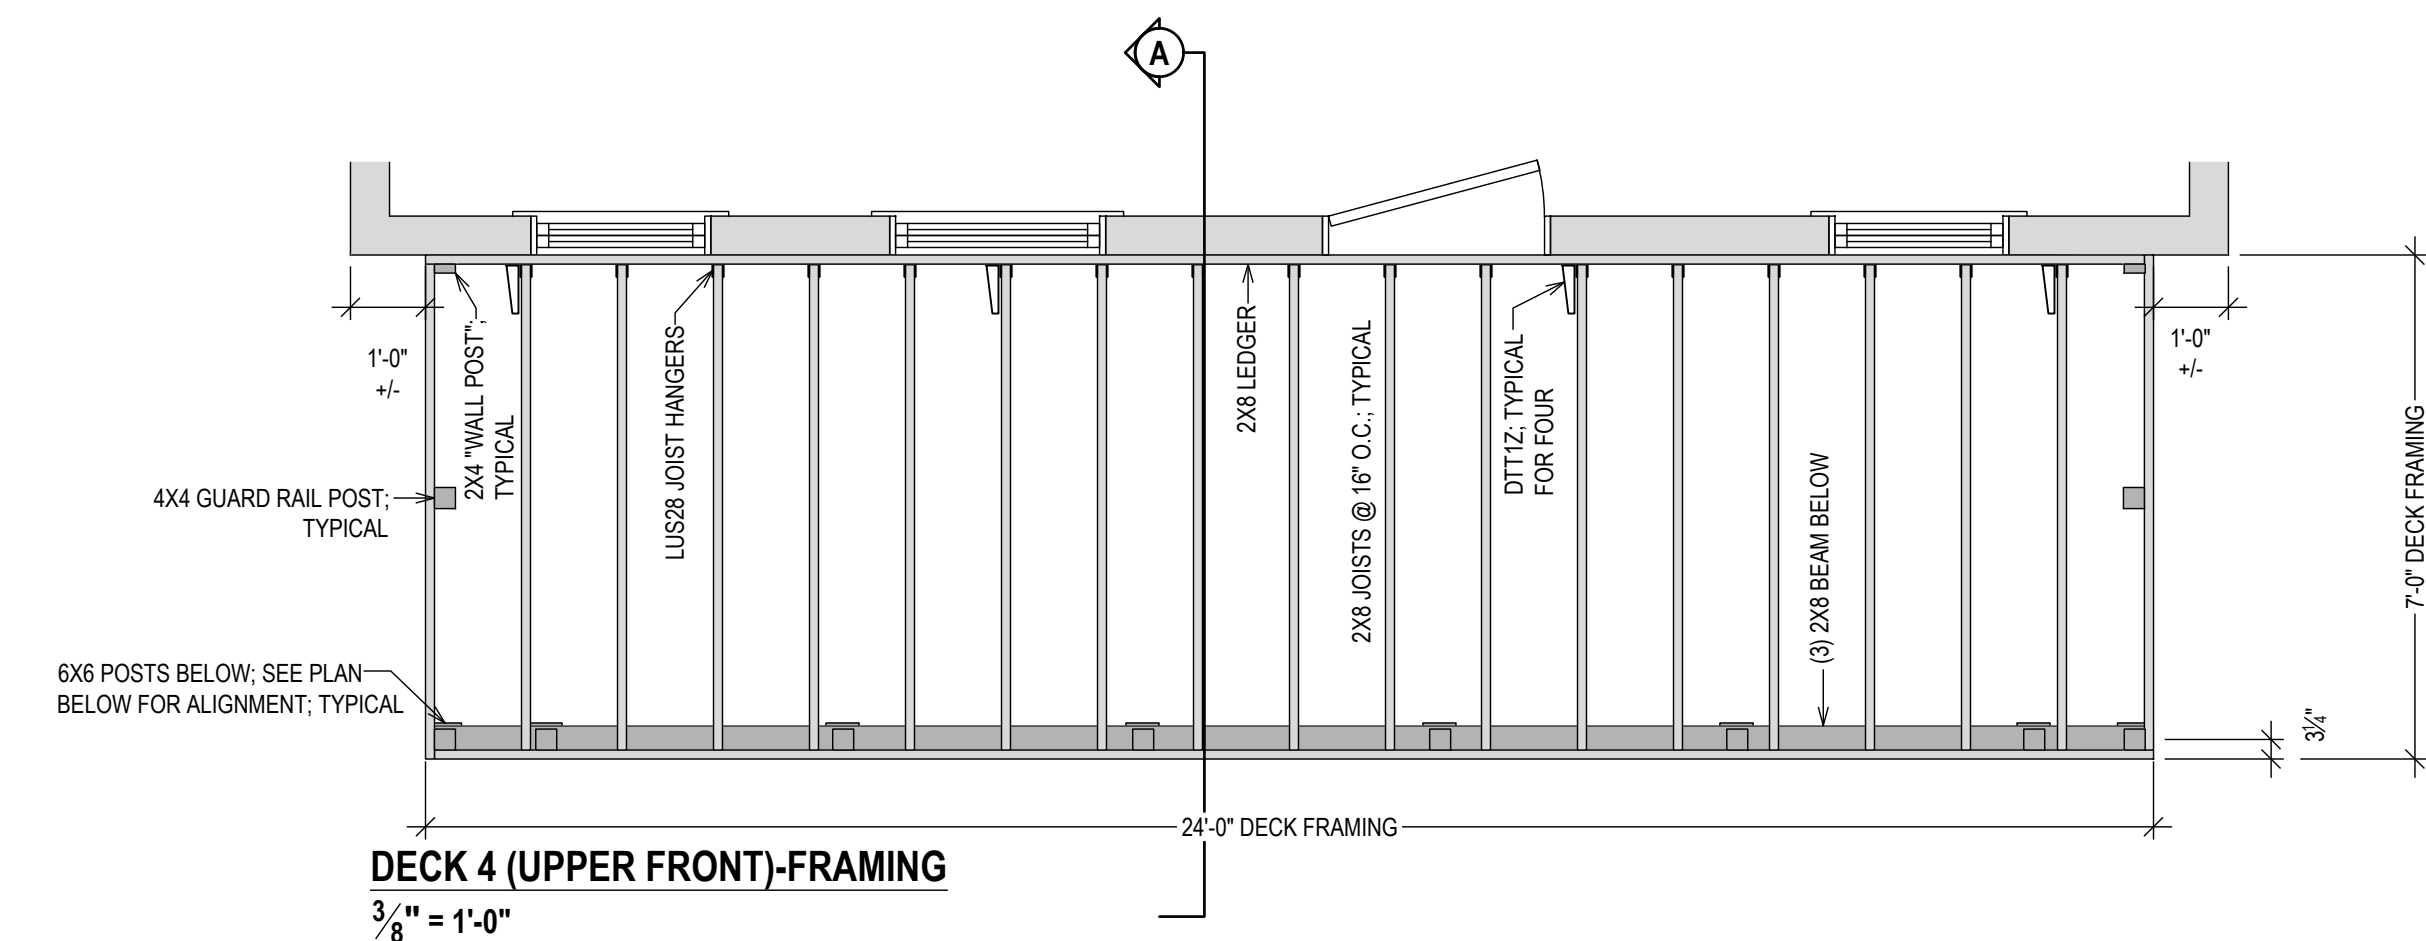


DECK 3 (LOWER FRONT)-FRAMING
3/8" = 1'-0"

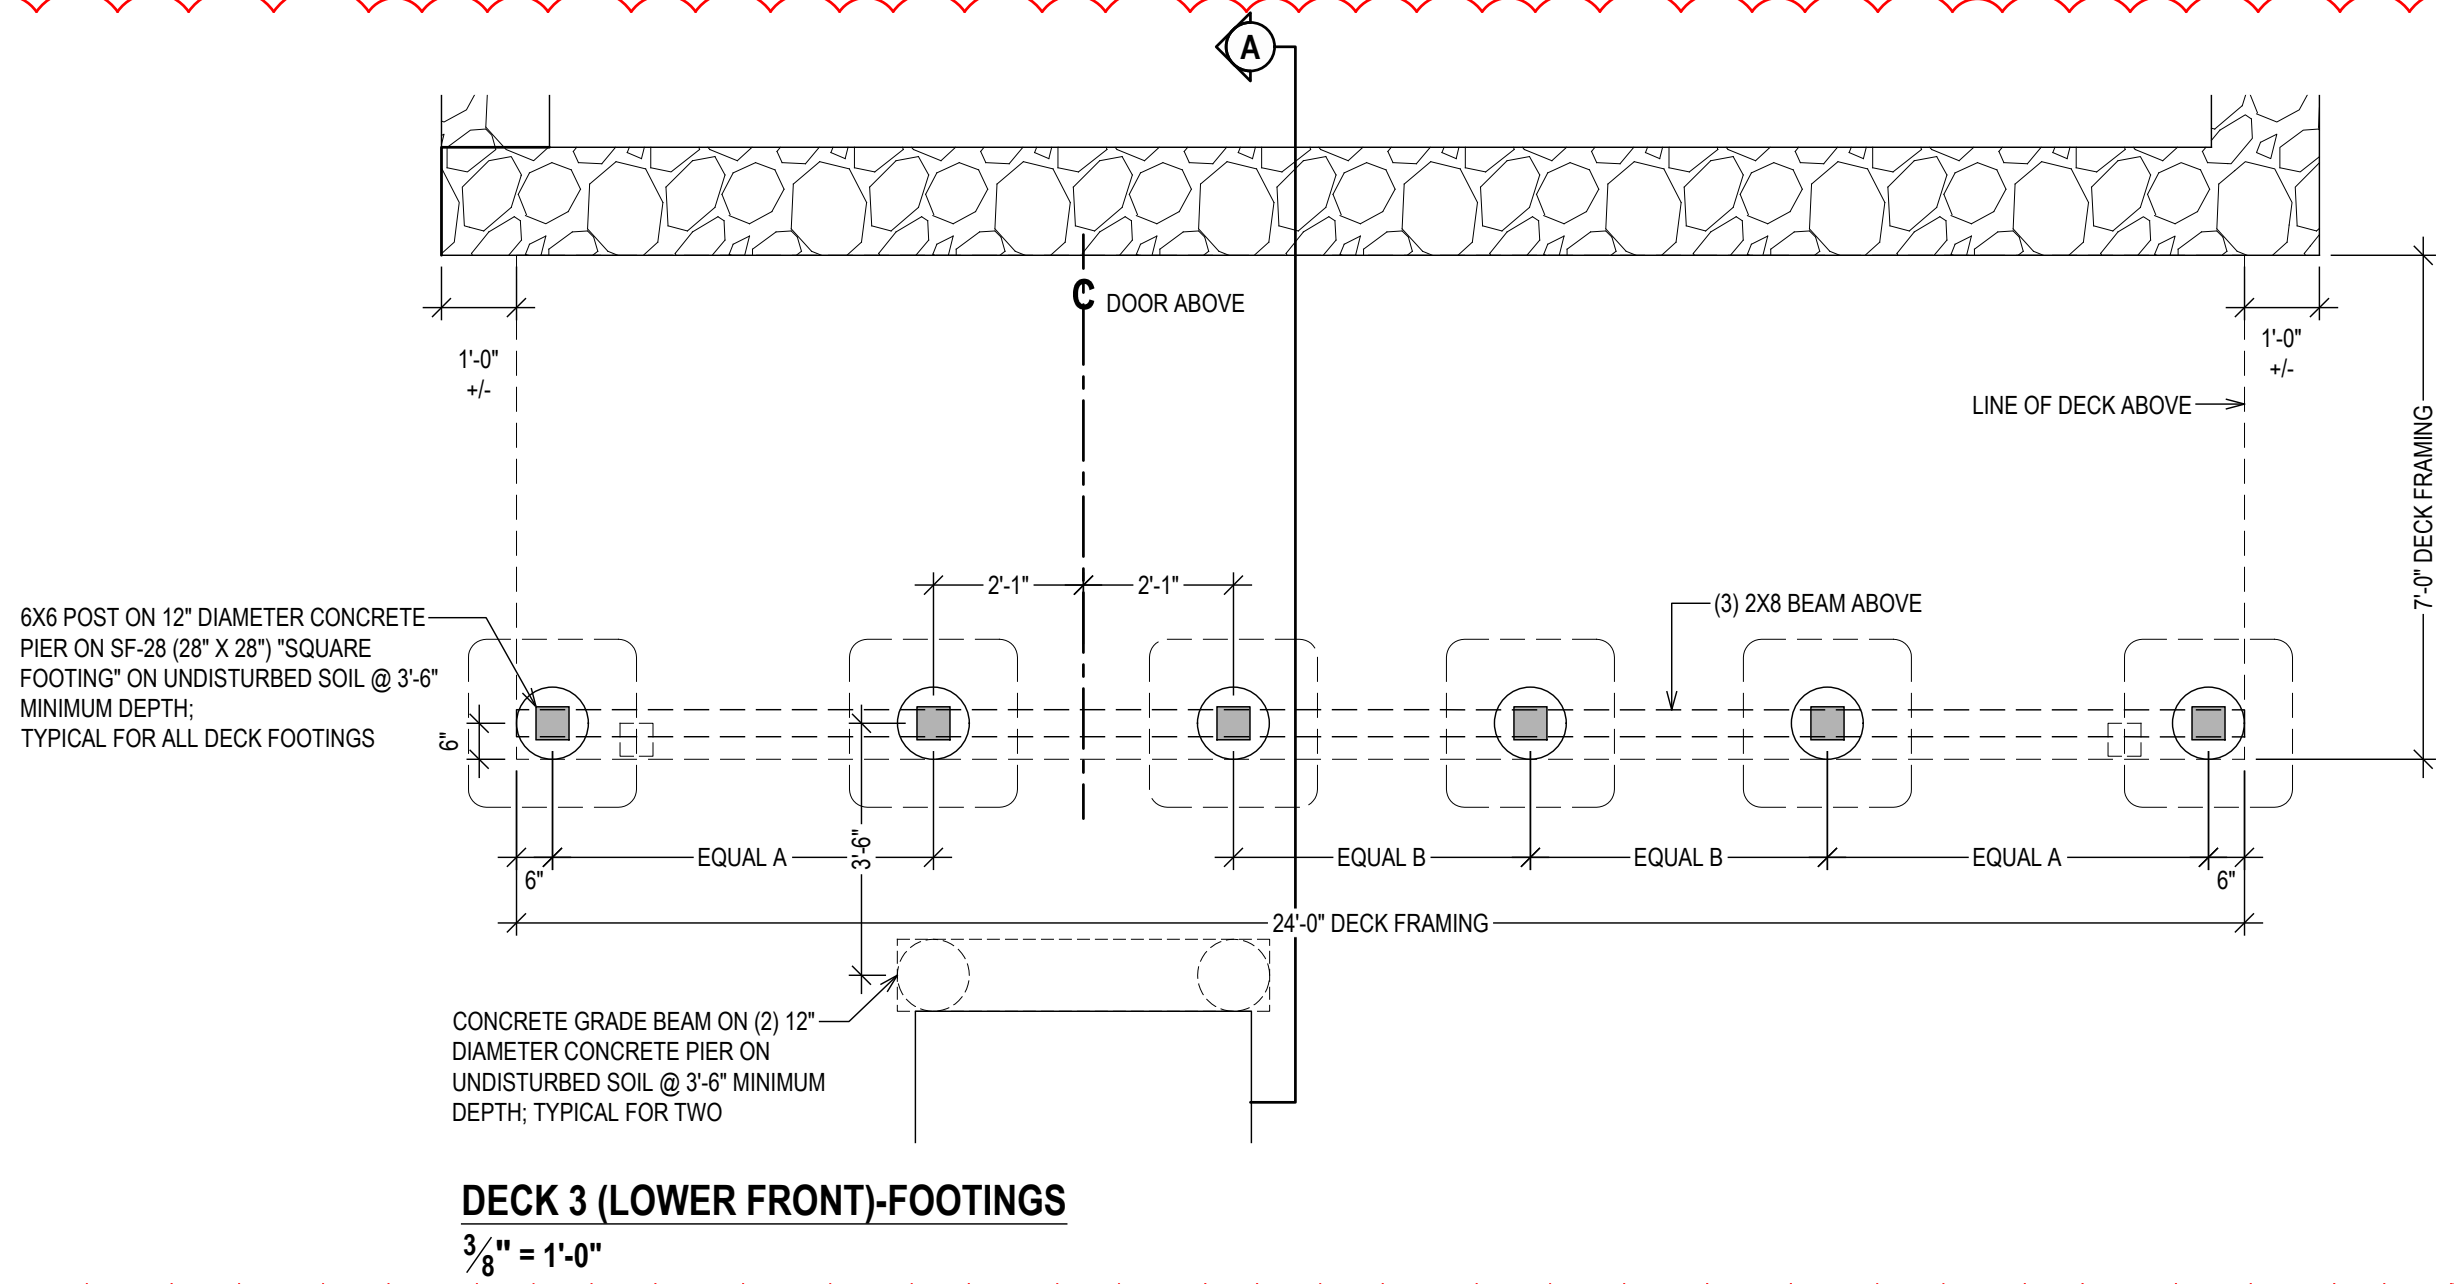


DECK 3 (LOWER FRONT)-FOOTINGS
3/8" = 1'-0"

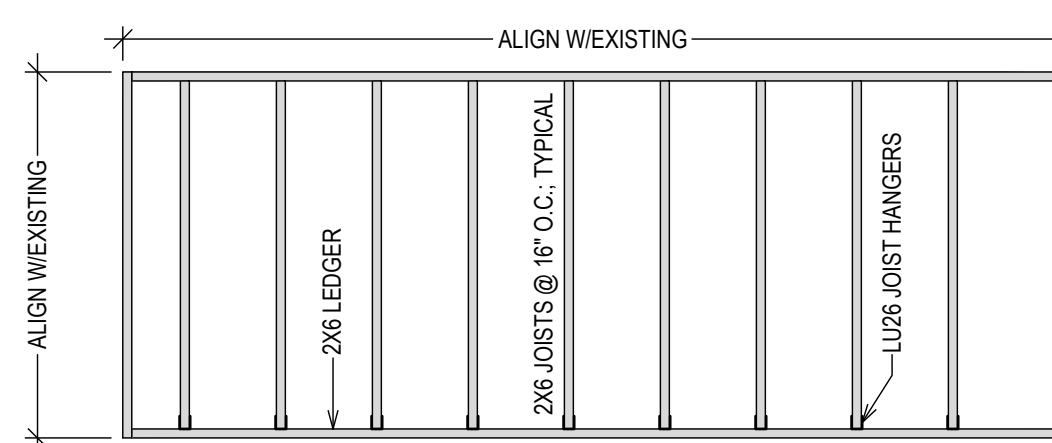

KITCHEN EXTENSION FLOOR FRAMING
STRUCTURE ON TOP OF DECK FRAMING, SEE DECK 2 (UPPER REAR) FRAMING PLAN
3/8" = 1'-0"

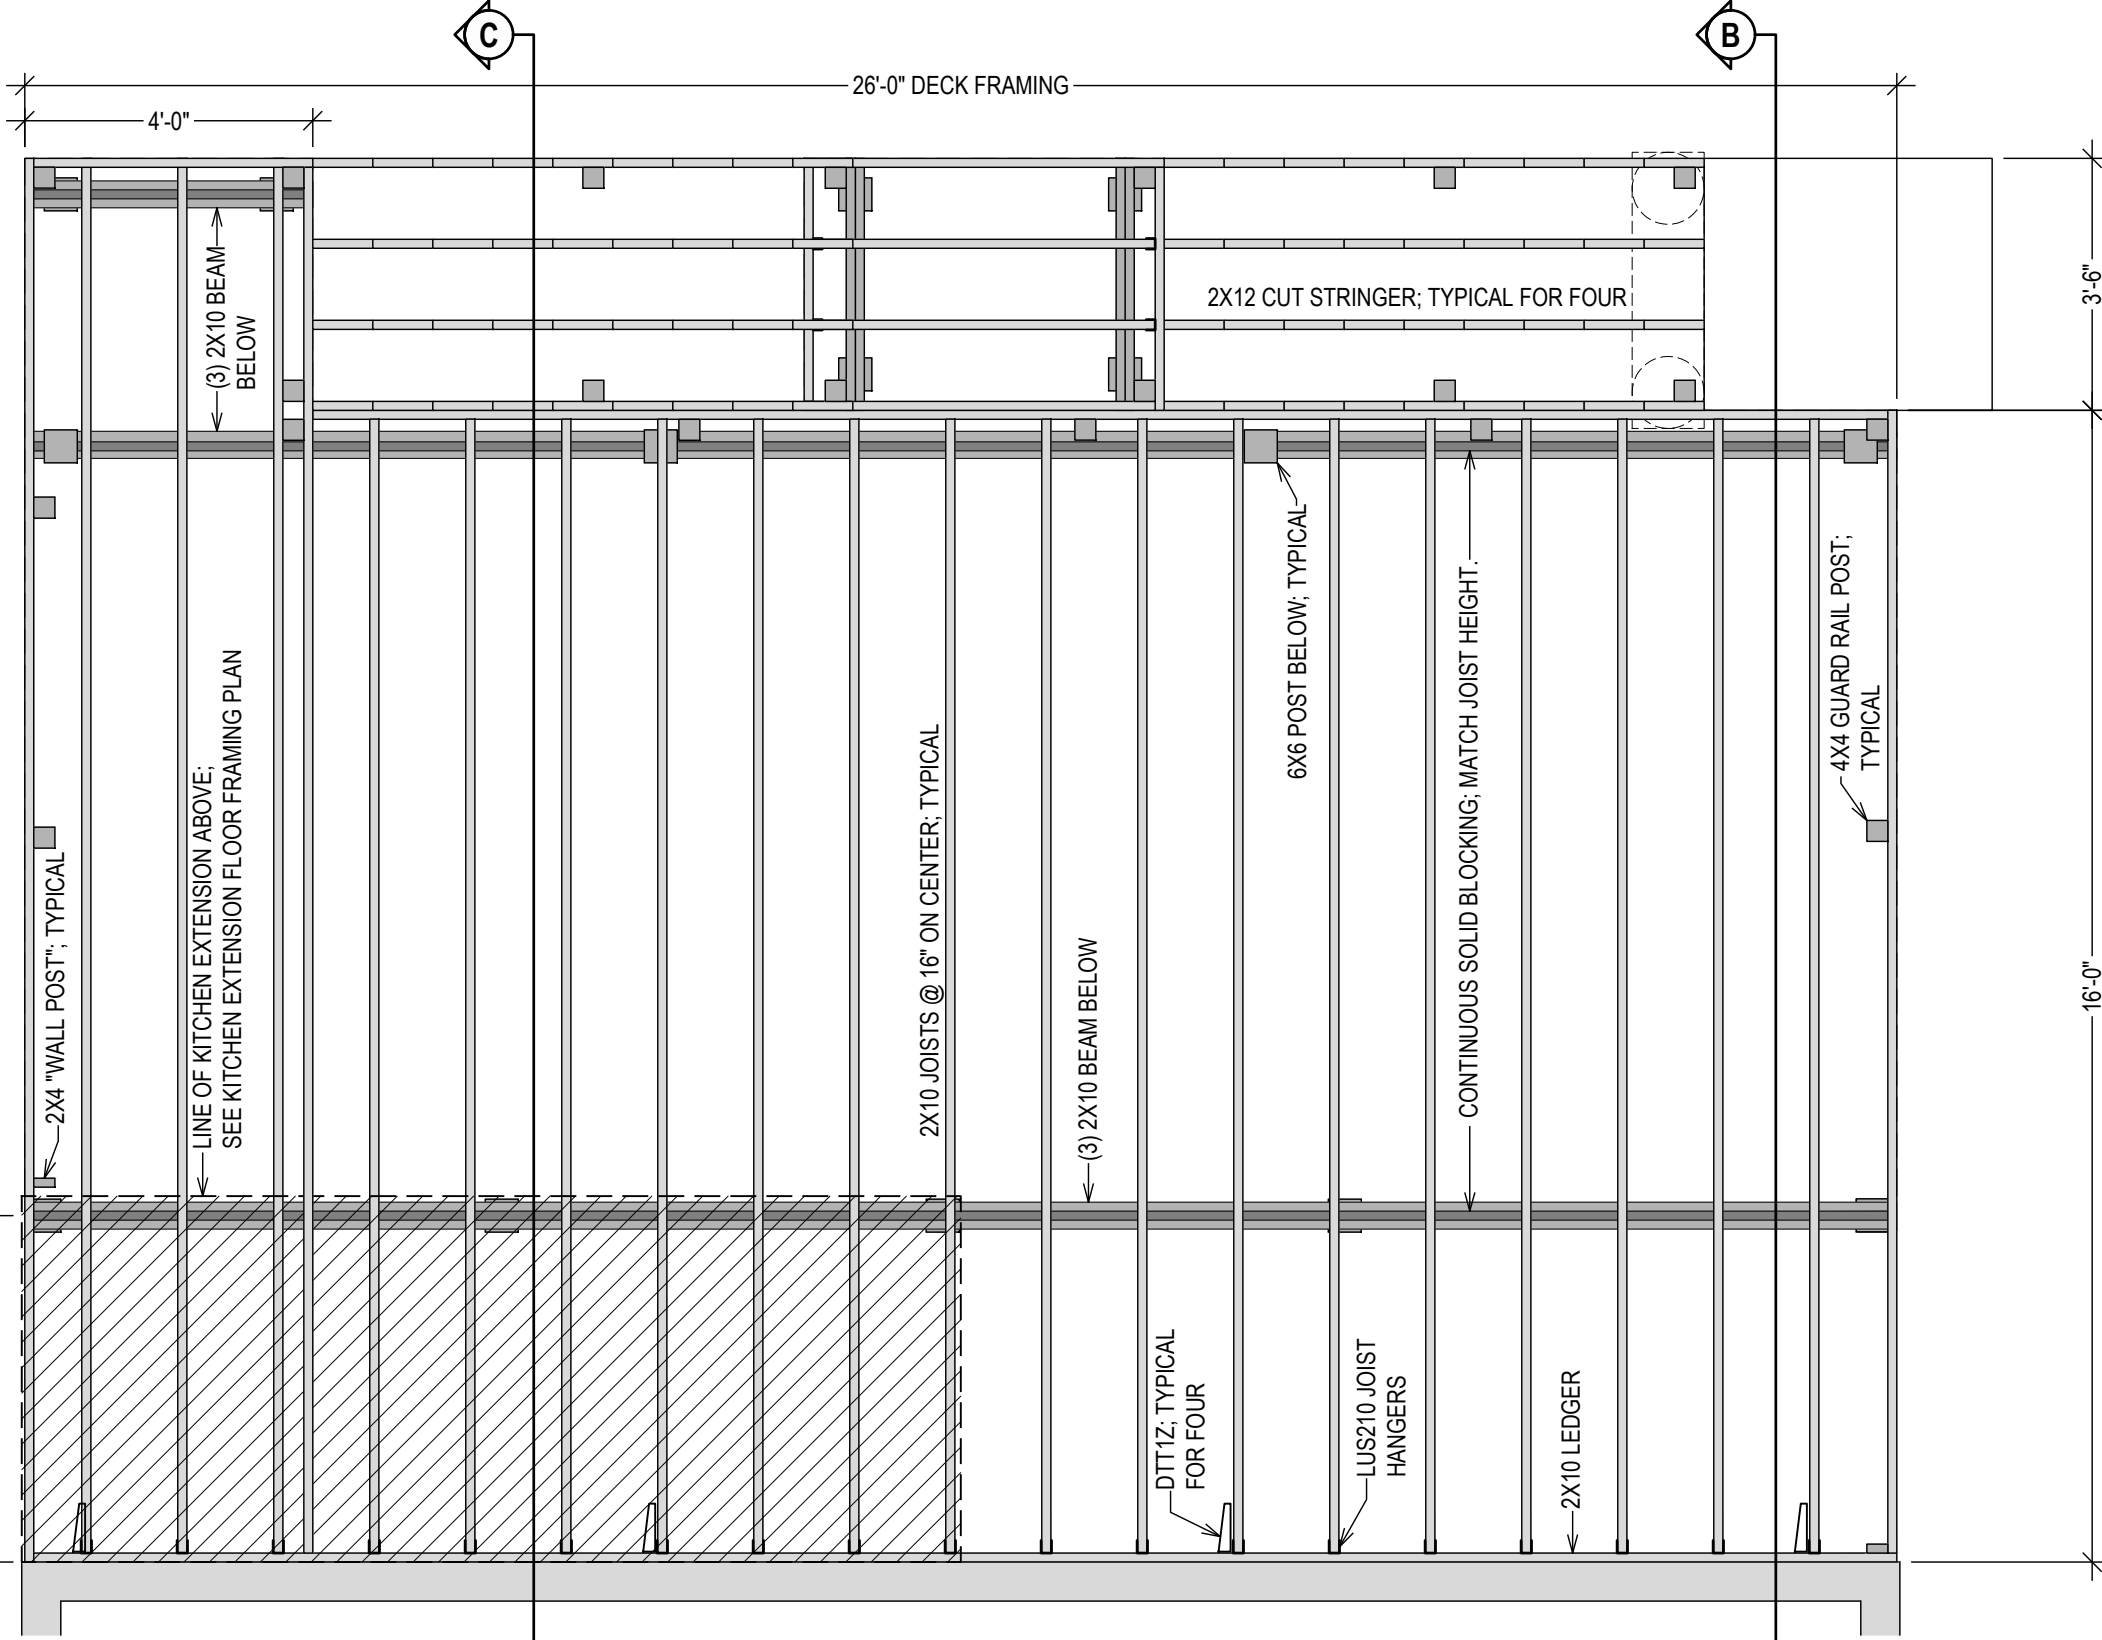

DECK 2 (UPPER REAR)-FRAMING
3/8" = 1'-0"

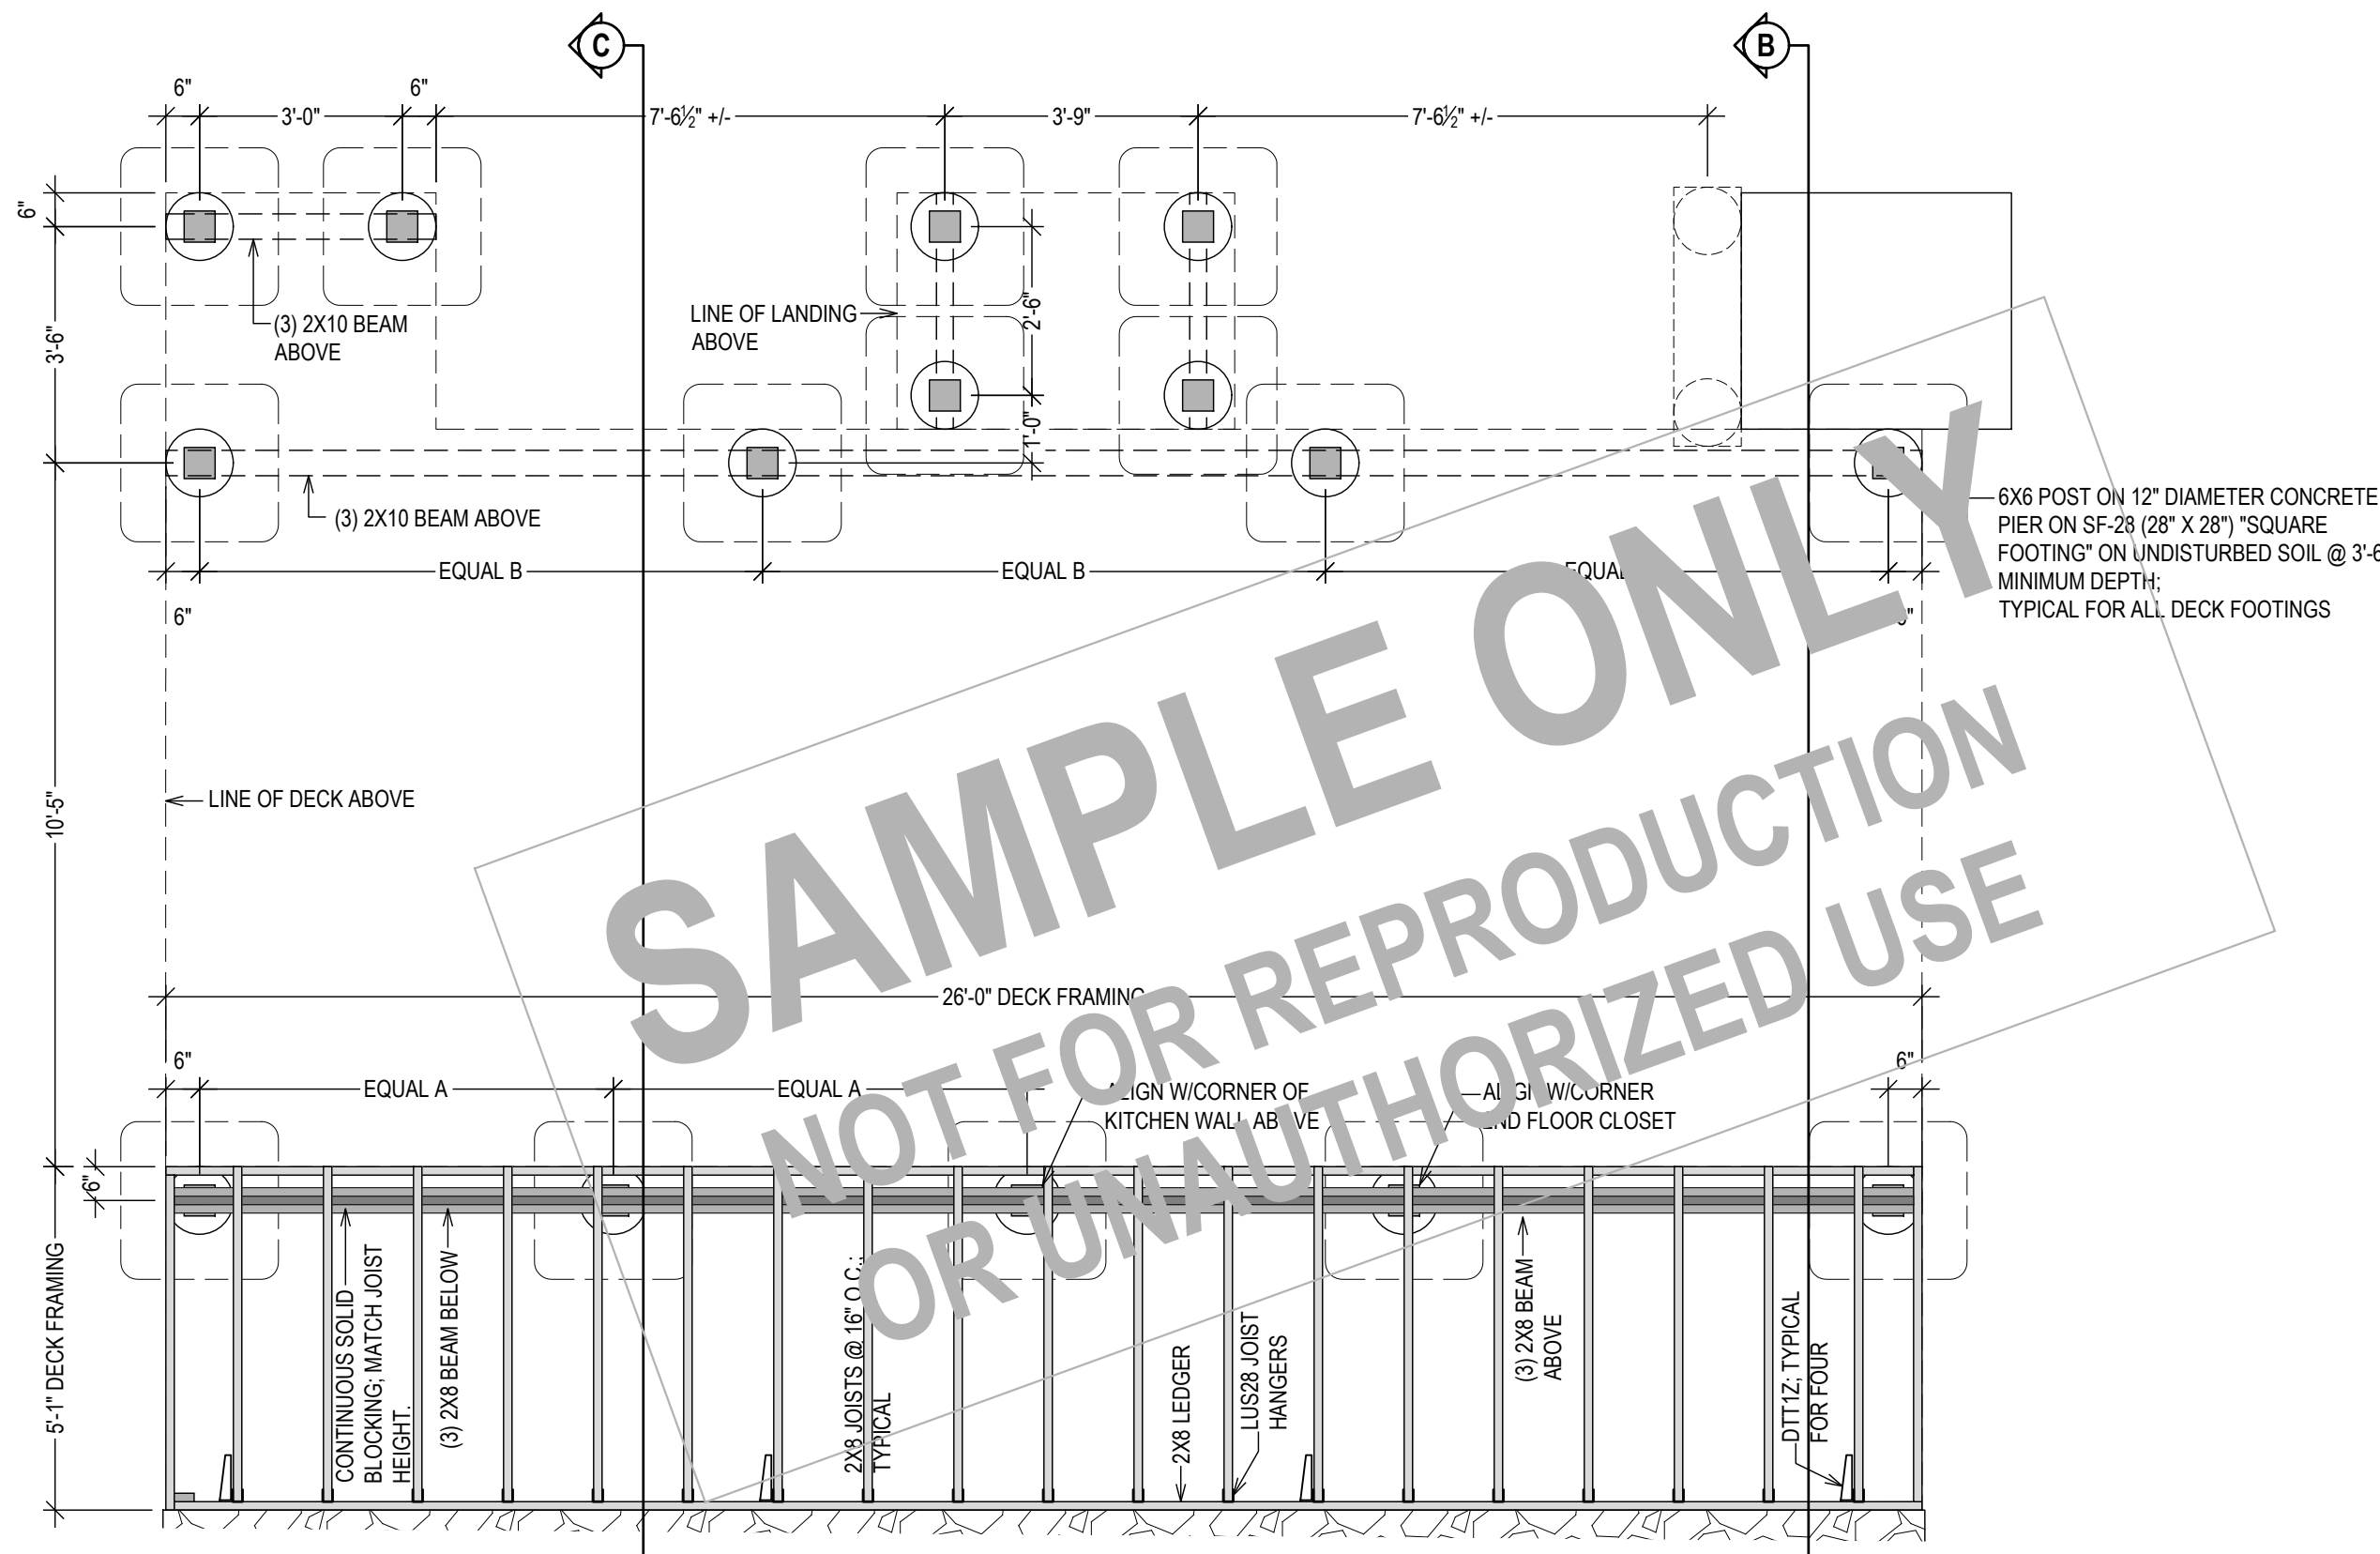

DECK 1 (LOWER REAR)-FRAMING
3/8" = 1'-0"

VERIFY ALL DIMENSIONS FOR
ALIGNMENT OF FOOTINGS,
PIERS AND POSTS

PROPERTY ADDRESS:

PORT CHESTER, NY 10573
(VILLAGE OF PORT CHESTER
BUILDING DEPARTMENT)

S-B-L:

CLIENT:
*** **

TEL: ***
EMAIL: ***

DATE: 05.15.2025
07.23.2025
08.15.2025
12.04.2025
ISSUE: PRELIMINARY
FOR PERMIT
FOR PERMIT
AMENDMENT

PROJECT NAME:
FLOOR PLAN ALTERATION

DRAWING NAME:
DECKS


DRAWING NUMBER:
A-05.1.1

DATE:
05.15.2025

SCALE:
AS NOTED


NOTE:
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PERMIT IS ISSUED, BASED ON THIS
DRAWING, BY THE VILLAGE OF PORT
CHESTER.

Oliver Engineering, P.C.
Design - Permit Applications - Legalizations
Code Compliance - Project Supervision
188 N22nd Ave. | Suite 101 | Port Chester, NY 10573
(914) 774-9878 | www.proeng.nyc | vc@proeng.nyc

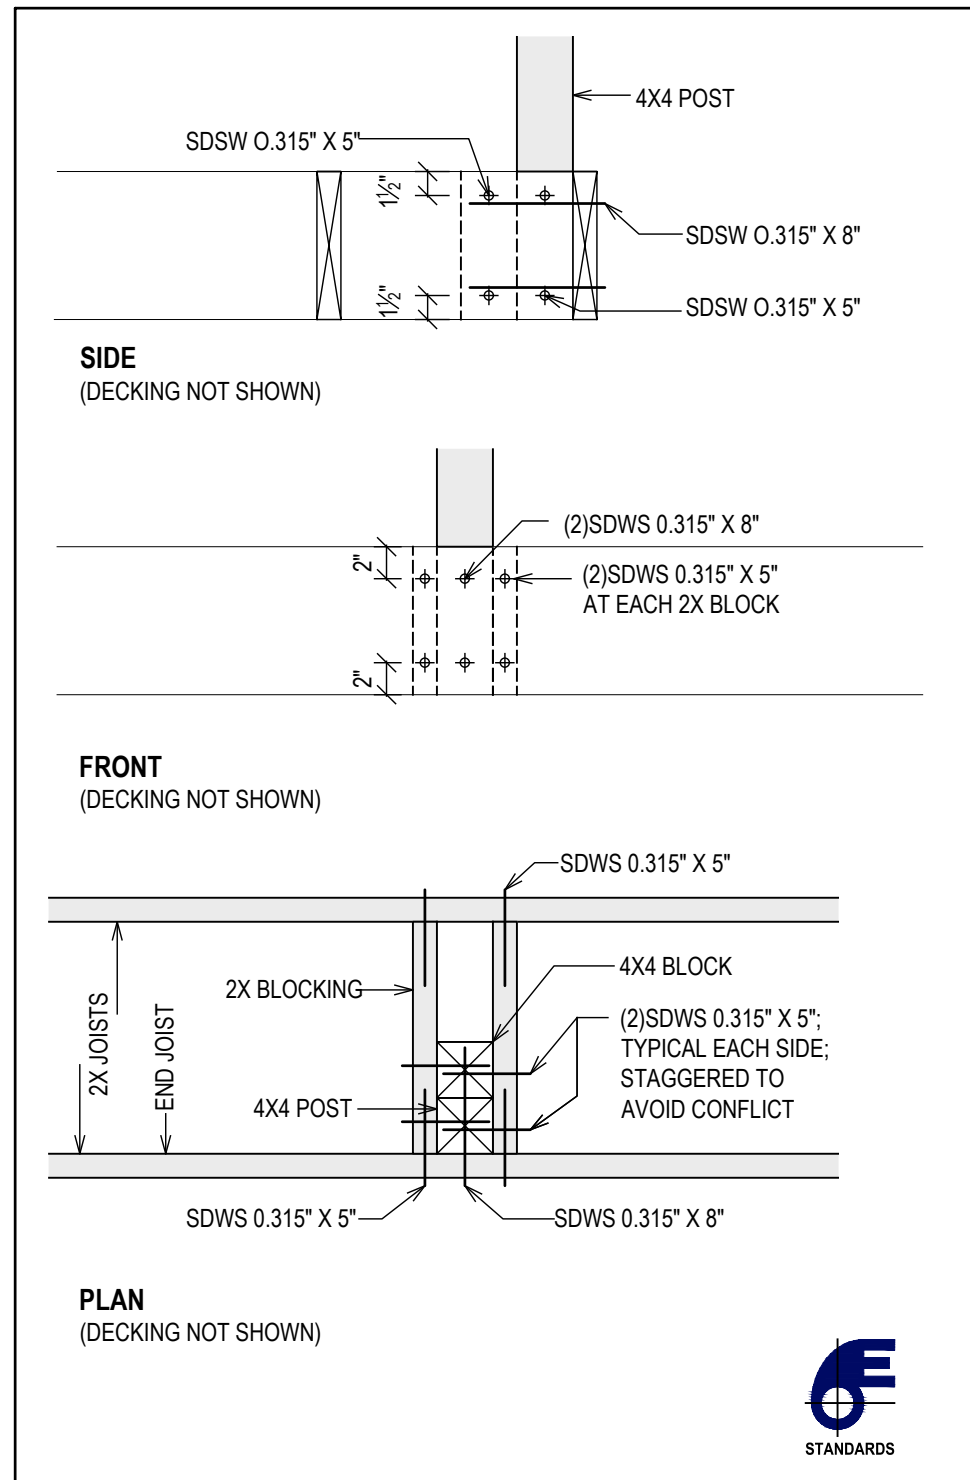


1. LINE POST ATTACHMENT (JOISTS PARALLEL)

1" = 1'-0"

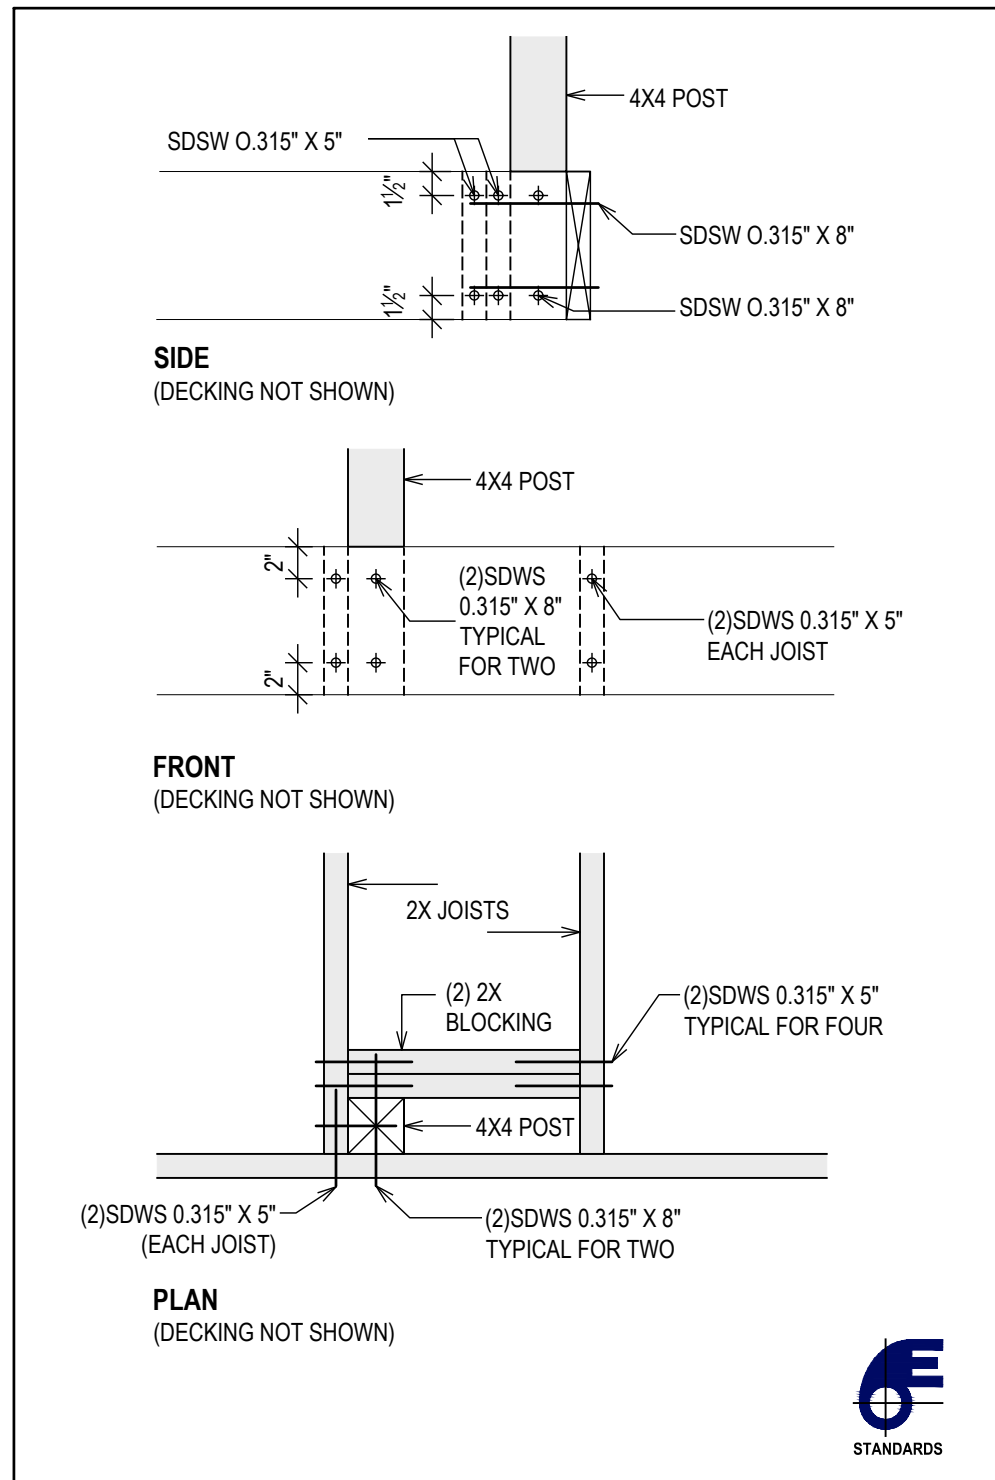


2. LINE POST ATTACHMENT

1" = 1'-0"

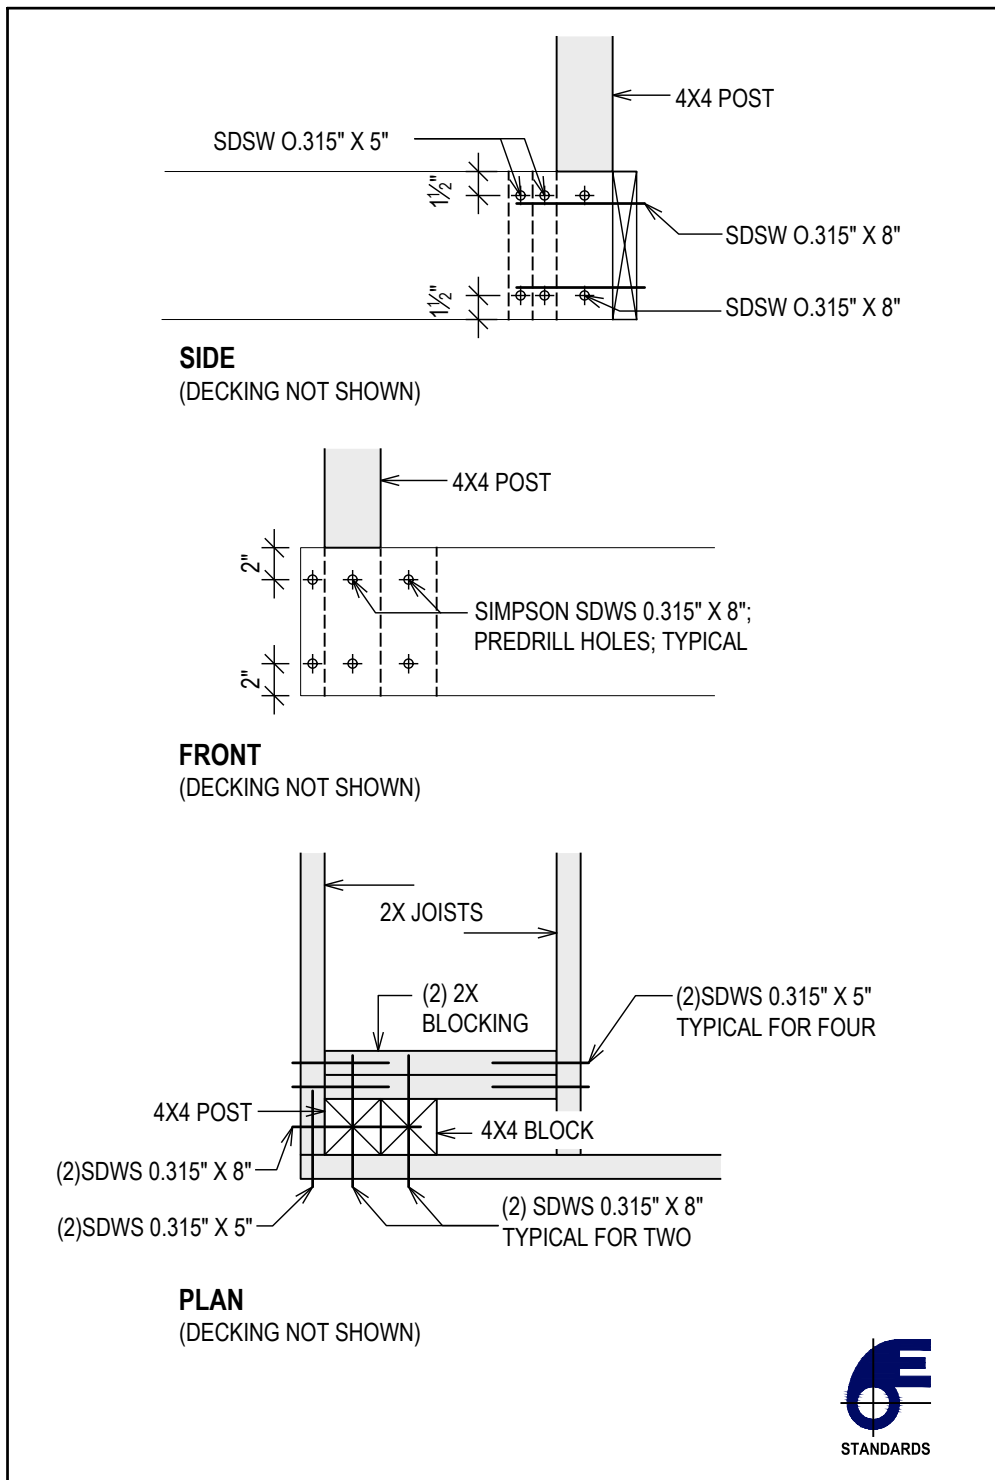

3. CORNER POST ATTACHMENT

1" = 1'-0"

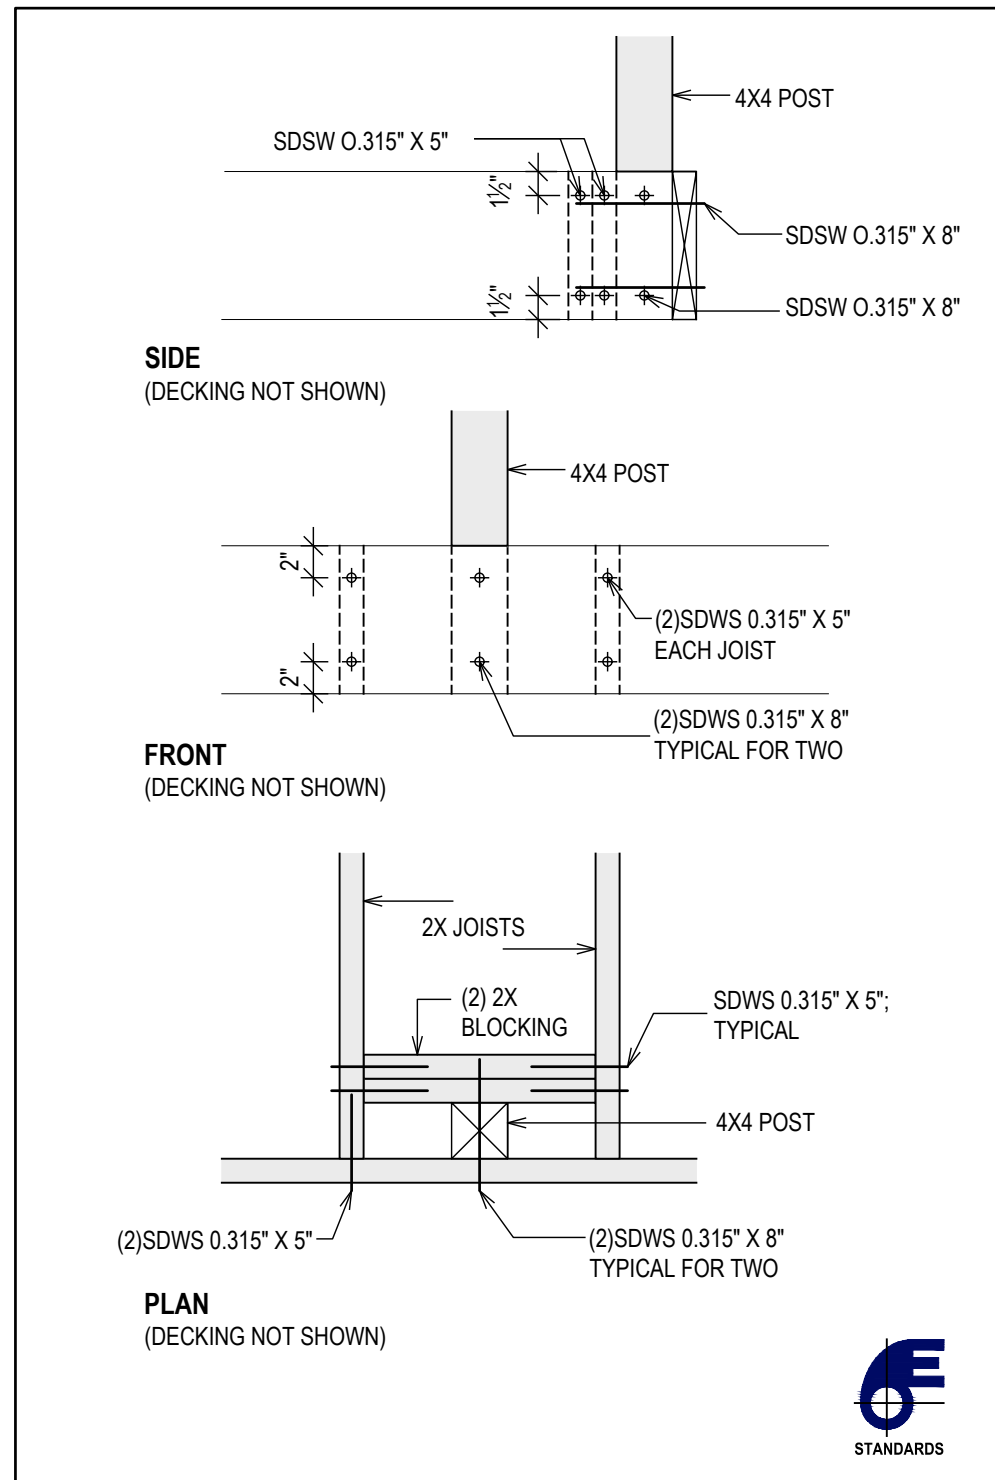

4. POST BETWEEN JOISTS

1" = 1'-0"

GUARD RAILS:

HEIGHT:
GUARDS SHALL BE NOT LESS THAN 36" IN HEIGHT AS MEASURED VERTICALLY ABOVE THE ADJACENT WALKING SURFACE.
HEIGHT EXCEPTIONS:
GUARDS ON THE OPEN SIDES OF STAIRS SHALL HAVE A HEIGHT OF NOT LESS THAN 34" MEASURED VERTICALLY FROM A LINE CONNECTING THE NOSINGS.
WHERE THE TOP OF THE GUARD SERVES AS A HANDRAIL ON THE OPEN SIDES OF STAIRS, THE TOP OF THE GUARD SHALL BE NOT LESS THAN 34" AND NOT MORE THAN 38 INCHES AS MEASURED VERTICALLY FROM A LINE CONNECTING THE NOSINGS.
OPENINGS:
GUARDS SHALL NOT HAVE OPENINGS FROM THE WALKING SURFACE TO THE REQUIRED GUARD HEIGHT THAT ALLOW PASSAGE OF A SPHERE 4" IN DIAMETER.
EXCEPTIONS:
THE TRIANGULAR OPENINGS AT THE OPEN SIDE OF STAIR, FORMED BY THE RISER, TREAD AND BOTTOM RAIL OF A GUARD, SHALL NOT ALLOW PASSAGE OF A SPHERE 6" IN DIAMETER.
GUARDS ON THE OPEN SIDE OF STAIRS SHALL NOT HAVE OPENINGS THAT ALLOW PASSAGE OF A SPHERE 4 3/8" IN DIAMETER.

HAND RAILS:

HEIGHT:
HANDRAIL HEIGHT, MEASURED VERTICALLY FROM THE SLOPED PLANE ADJOINING THE TREAD NOSING SHALL BE NOT LESS THAN 34" AND NOT MORE THAN 38".
GRIP SIZE:
REQUIRED HANDRAILS SHALL BE OF ONE OF THE FOLLOWING TYPES (I OR II) OR PROVIDE EQUIVALENT GRASPABILITY.

TYPE I.
HANDRAILS WITH A CIRCULAR CROSS SECTION SHALL HAVE AN OUTSIDE DIAMETER OF NOT LESS THAN 1 1/2" AND NOT GREATER THAN 2". IF THE HANDRAIL IS NOT CIRCULAR, IT SHALL HAVE A PERIMETER OF NOT LESS THAN 4" AND NOT GREATER THAN 6" AND A CROSS SECTION OF NOT MORE THAN 2 1/2". EDGES SHALL HAVE A RADIUS OF NOT LESS THAN 0.01".
TYPE II.
HANDRAILS WITH A PERIMETER GREATER THAN 6 1/2" SHALL HAVE A GRASPABLE FINGER RECESS AREA ON BOTH SIDES OF THE PROFILE. THE FINGER RECESS SHALL BEGIN WITHIN 3/4" MEASURED VERTICALLY FROM THE TALLEST PORTION OF THE PROFILE AND HAVE A DEPTH OF NOT LESS THAN 3/4" WITHIN 1/2" BELOW THE WIDEST PORTION OF THE PROFILE. THIS REQUIRED DEPTH SHALL CONTINUE FOR NOT LESS THAN 3/4" TO A LEVEL THAT IS NOT LESS THAN 1 1/2" BELOW THE TALLEST PORTION OF THE PROFILE. THE WIDTH OF THE HANDRAIL ABOVE THE RECESS SHALL BE NOT LESS THAN 1 1/2" AND NOT MORE THAN 2 1/2". EDGES SHALL HAVE A RADIUS OF NOT LESS THAN 0.01".

CONTINUITY:
HANDRAILS SHALL BE CONTINUOUS FOR THE FULL LENGTH OF THE FLIGHT, FROM A POINT DIRECTLY ABOVE THE TOP RISER OF THE FLIGHT TO A POINT DIRECTLY ABOVE THE LOWEST RISER OF THE FLIGHT. HANDRAIL ENDS SHALL BE RETURNED OR SHALL TERMINATE IN NEWEL POSTS OR SAFETY TERMINALS.

EXCEPTIONS:
HANDRAIL CONTINUITY SHALL BE PERMITTED TO BE INTERRUPTED BY A NEWEL POST AT A TURN IN A FLIGHT WITH WINDERS, AT A LANDING, OR OVER THE LOWEST TREAD.

PLASTIC COMPOSITE MATERIALS:

PLASTIC COMPOSITE EXTERIOR DECK BOARDS, STAIR TREADS, GUARDS AND HANDRAILS SHALL COMPLY WITH THE REQUIREMENTS OF R507.2.2 OF THE RESIDENTIAL CODE AND OF ASTM D7032.

LABELING:
PLASTIC OR COMPOSITE EXTERIOR DECK BOARDS, STAIR TREADS, HANDRAILS AND GUARDS, OR THEIR PACKAGING, SHALL BEAR A LABEL THAT INDICATES COMPLIANCE WITH ASTM D7032 AND INCLUDES THE MAXIMUM ALLOWABLE SPAN DETERMINED IN ACCORDANCE WITH ASTM D7032.

INSTALLATION:
THEY SHALL BE INSTALLED IN ACCORDANCE WITH THE MANUFACTURER'S INSTRUCTIONS.

APPROVAL:
NEW POSTS (TRIM) AND RAILINGS TO BE COMPOSITE MATERIAL, COMPLIANT WITH THE ABOVE REQUIREMENTS, AND TO BE APPROVED BY OWNER PRIOR TO INSTALLATION.
RAILS TO BE TIMBERTECH CLASSIC COMPOSITE SERIES OR OTHER APPROVED BY OWNER.

EXTERIOR DECK STRUCTURE

LOADING:
DECKS SHALL BE DESIGNED FOR A LIVE LOAD OR 40 PSF.

FOOTINGS:
FOOTINGS SHALL BEAR ON UNDISTURBED EARTH WITH A MINIMUM BEARING CAPACITY OF 2,500 PSF AND AT A MINIMUM OF 42" BELOW GRADE; OR BEAR ON SOLID ROCK.
CONCRETE AND REBAR SHALL BE PER THE GENERAL NOTES ON SHEET C-01.

WOOD MATERIALS:
UNLESS OTHERWISE NOTED, ALL WOOD MATERIALS (NOTED HEREIN AS PT) SHALL BE NO. 2 GRADE PRESSURE-PRESERVATIVE-TREATED SOUTHERN PINE, HEM-FIR, OR OTHER APPROVED, OR BETTER LUMBER, PRESERVATIVE-TREATED IN ACCORDANCE WITH SECTION R317.


BEAMS:
BEAM PILES SHALL BE FASTENED TOGETHER WITH TWO ROWS OF 10D (3" x 0.128") NAILS MINIMUM AT 16" ON CENTER ALONG EACH EDGE OR AS NOTED.

THE ENDS OF BEAMS SHALL HAVE NOT LESS THAN 1 1/2" OF BEARING ON WOOD OR METAL AND NOT LESS THAN 3" OF BEARING ON CONCRETE OR MASONRY FOR THE ENTIRE WIDTH OF THE BEAM. WHERE MULTIPLE-SPAN BEAMS BEAR ON INTERMEDIATE POSTS, EACH PLY SHALL HAVE FULL BEARING ON THE POST.

JOISTS:
SPANS FOR WOOD DECK JOISTS, SHALL BE AS SHOWN IN THESE DRAWINGS; THE MAXIMUM JOIST SPACING MAY ALSO BE LIMITED BY THE DECKING MATERIALS.
EACH JOIST SHALL BE SECURED TO THE BEAM WITH A MINIMUM OF (3) 10D (3" x 0.128") TOE NAILS.
RIM JOISTS SHALL BE SECURED TO THE END OF EACH JOIST WITH NOT FEWER THAN THREE 10D (3" x 0.128") NAILS OR THREE NO. 10 X 3" LONG WOOD SCREWS.


DECKING:
WOOD DECKING SHALL BE ATTACHED TO EACH SUPPORTING MEMBER WITH NOT LESS THAN TWO 8D THREADED NAILS OR TWO NO. 8 WOOD SCREWS.
SPACING FOR JOISTS SUPPORTING PLASTIC COMPOSITE DECKING SHALL BE IN ACCORDANCE WITH SECTION R507.2 AND MANUFACTURER'S INSTRUCTIONS.

HARDWARE:
ALL HARDWARE AND FASTENERS USED IN EXTERIOR DECKING SHALL BE HOT-DIPPED GALVANIZED OR STAINLESS STEEL AND SHALL BE INSTALLED IN ACCORDANCE WITH THESE DRAWINGS AND THE MANUFACTURER'S INSTRUCTIONS.

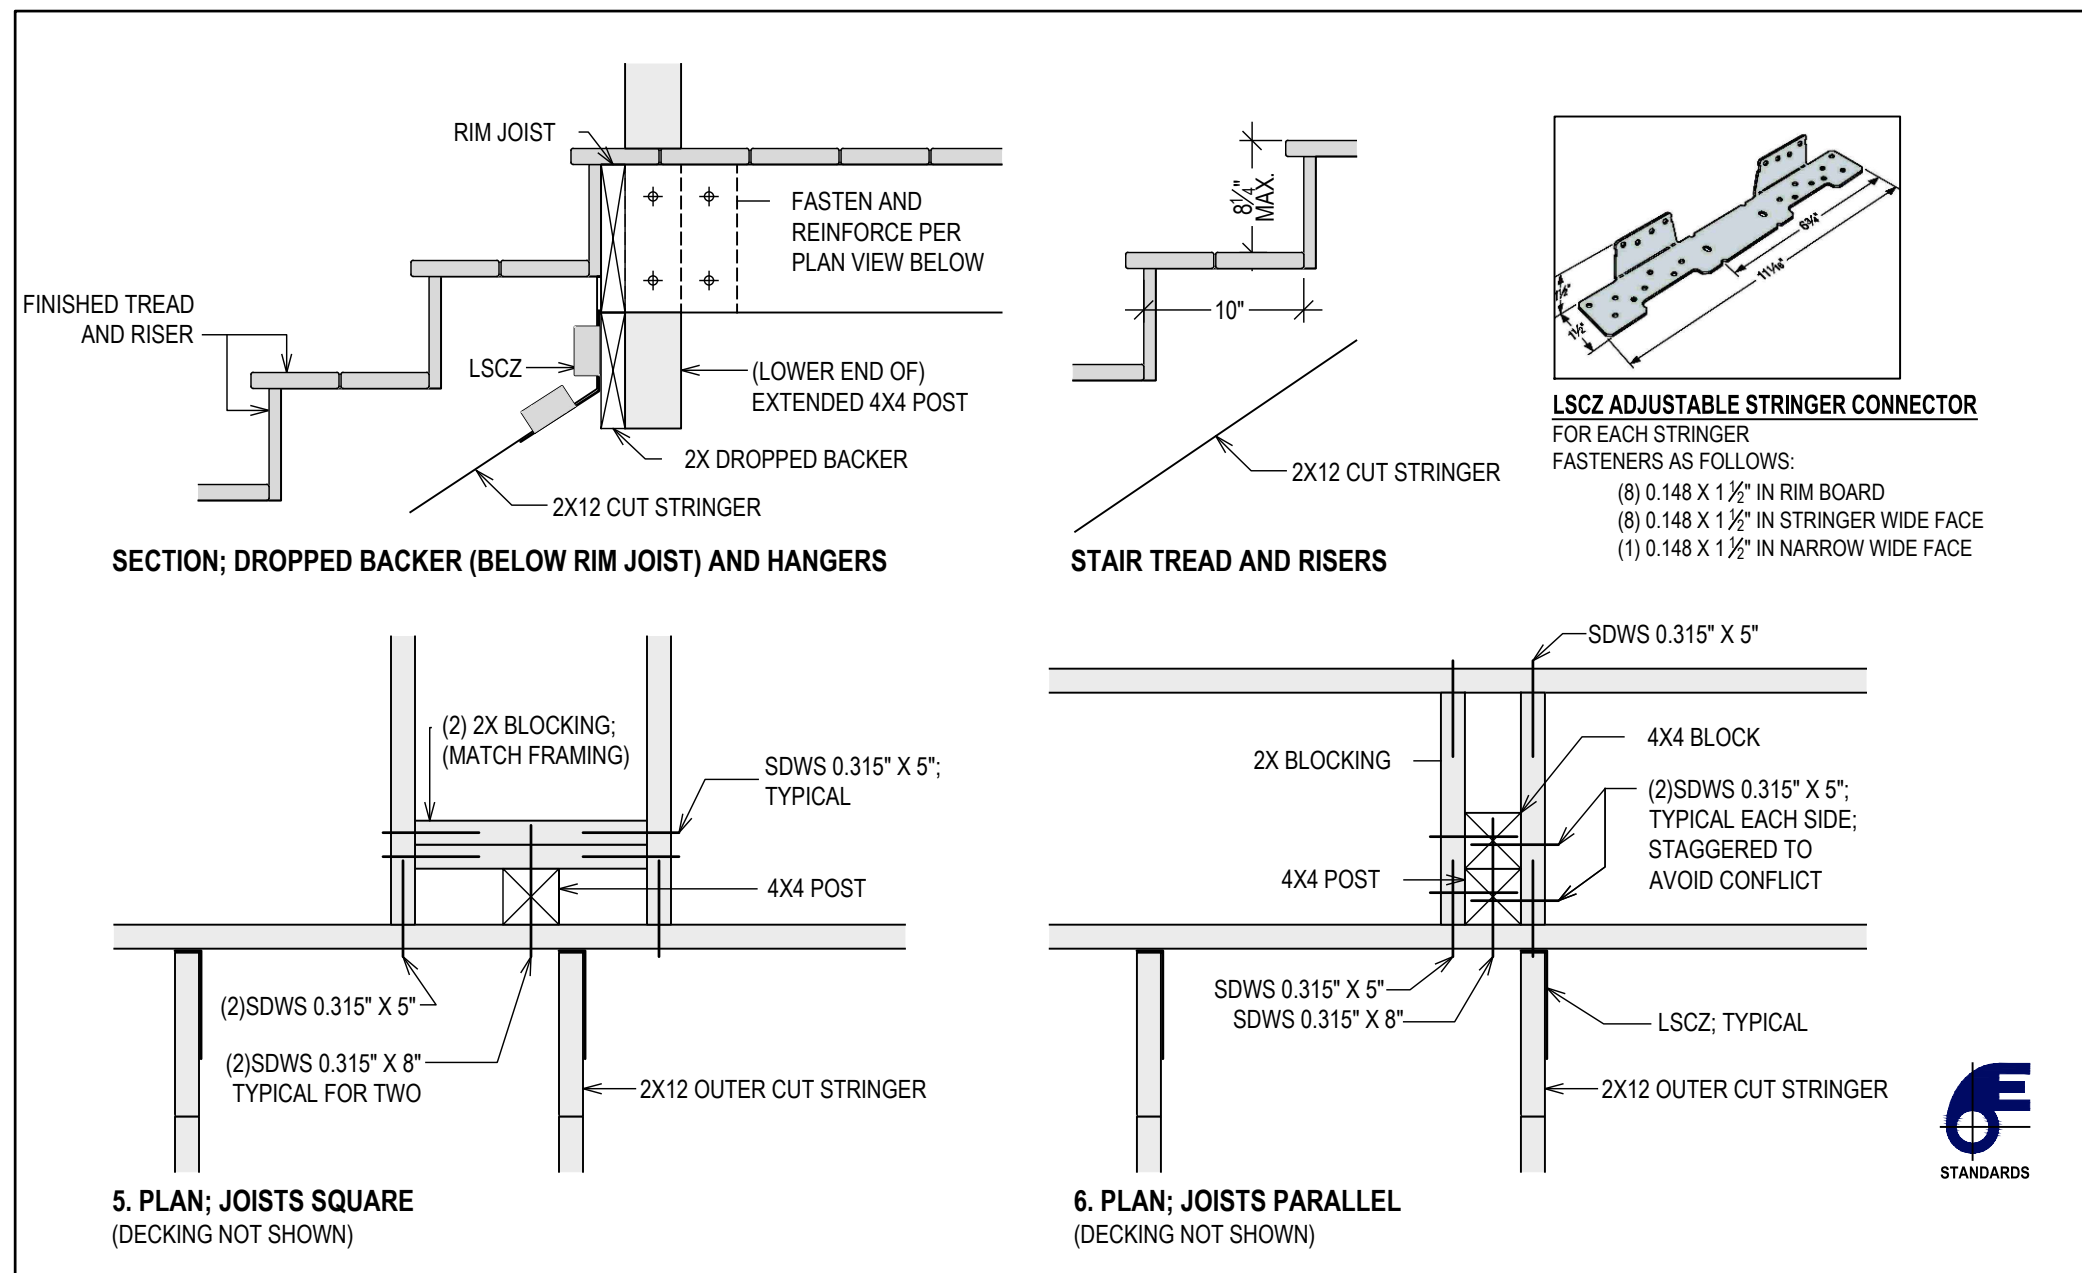

5. & 6. TOP OF STAIR POST & STRINGER ATTACHMENT


1" = 1'-0"

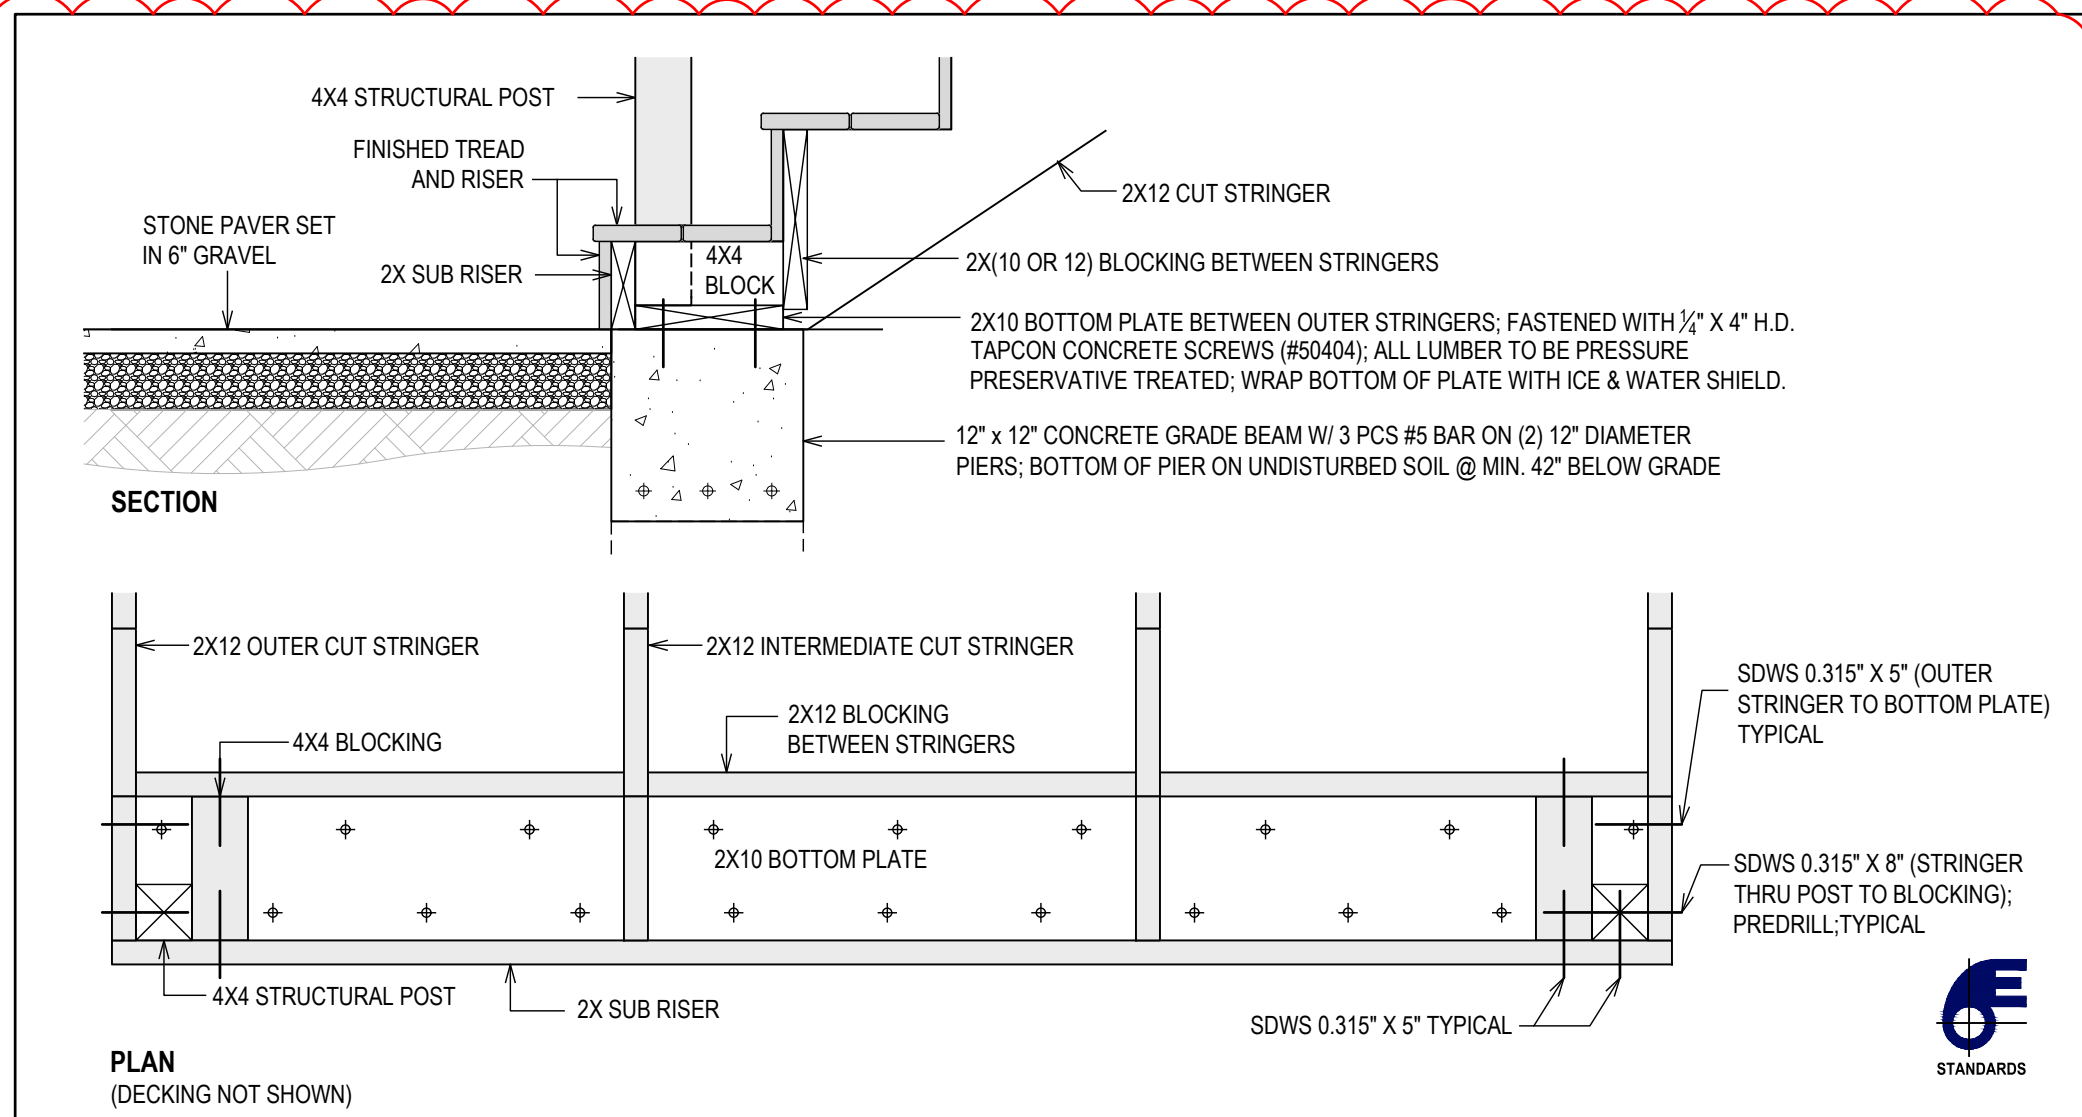

7. BOTTOM STAIR POST ATTACHMENT


1" = 1'-0"

THIS DRAWING IS AS A SAMPLE ONLY
PERSONAL (CLIENT) INFORMATION WITHHELD

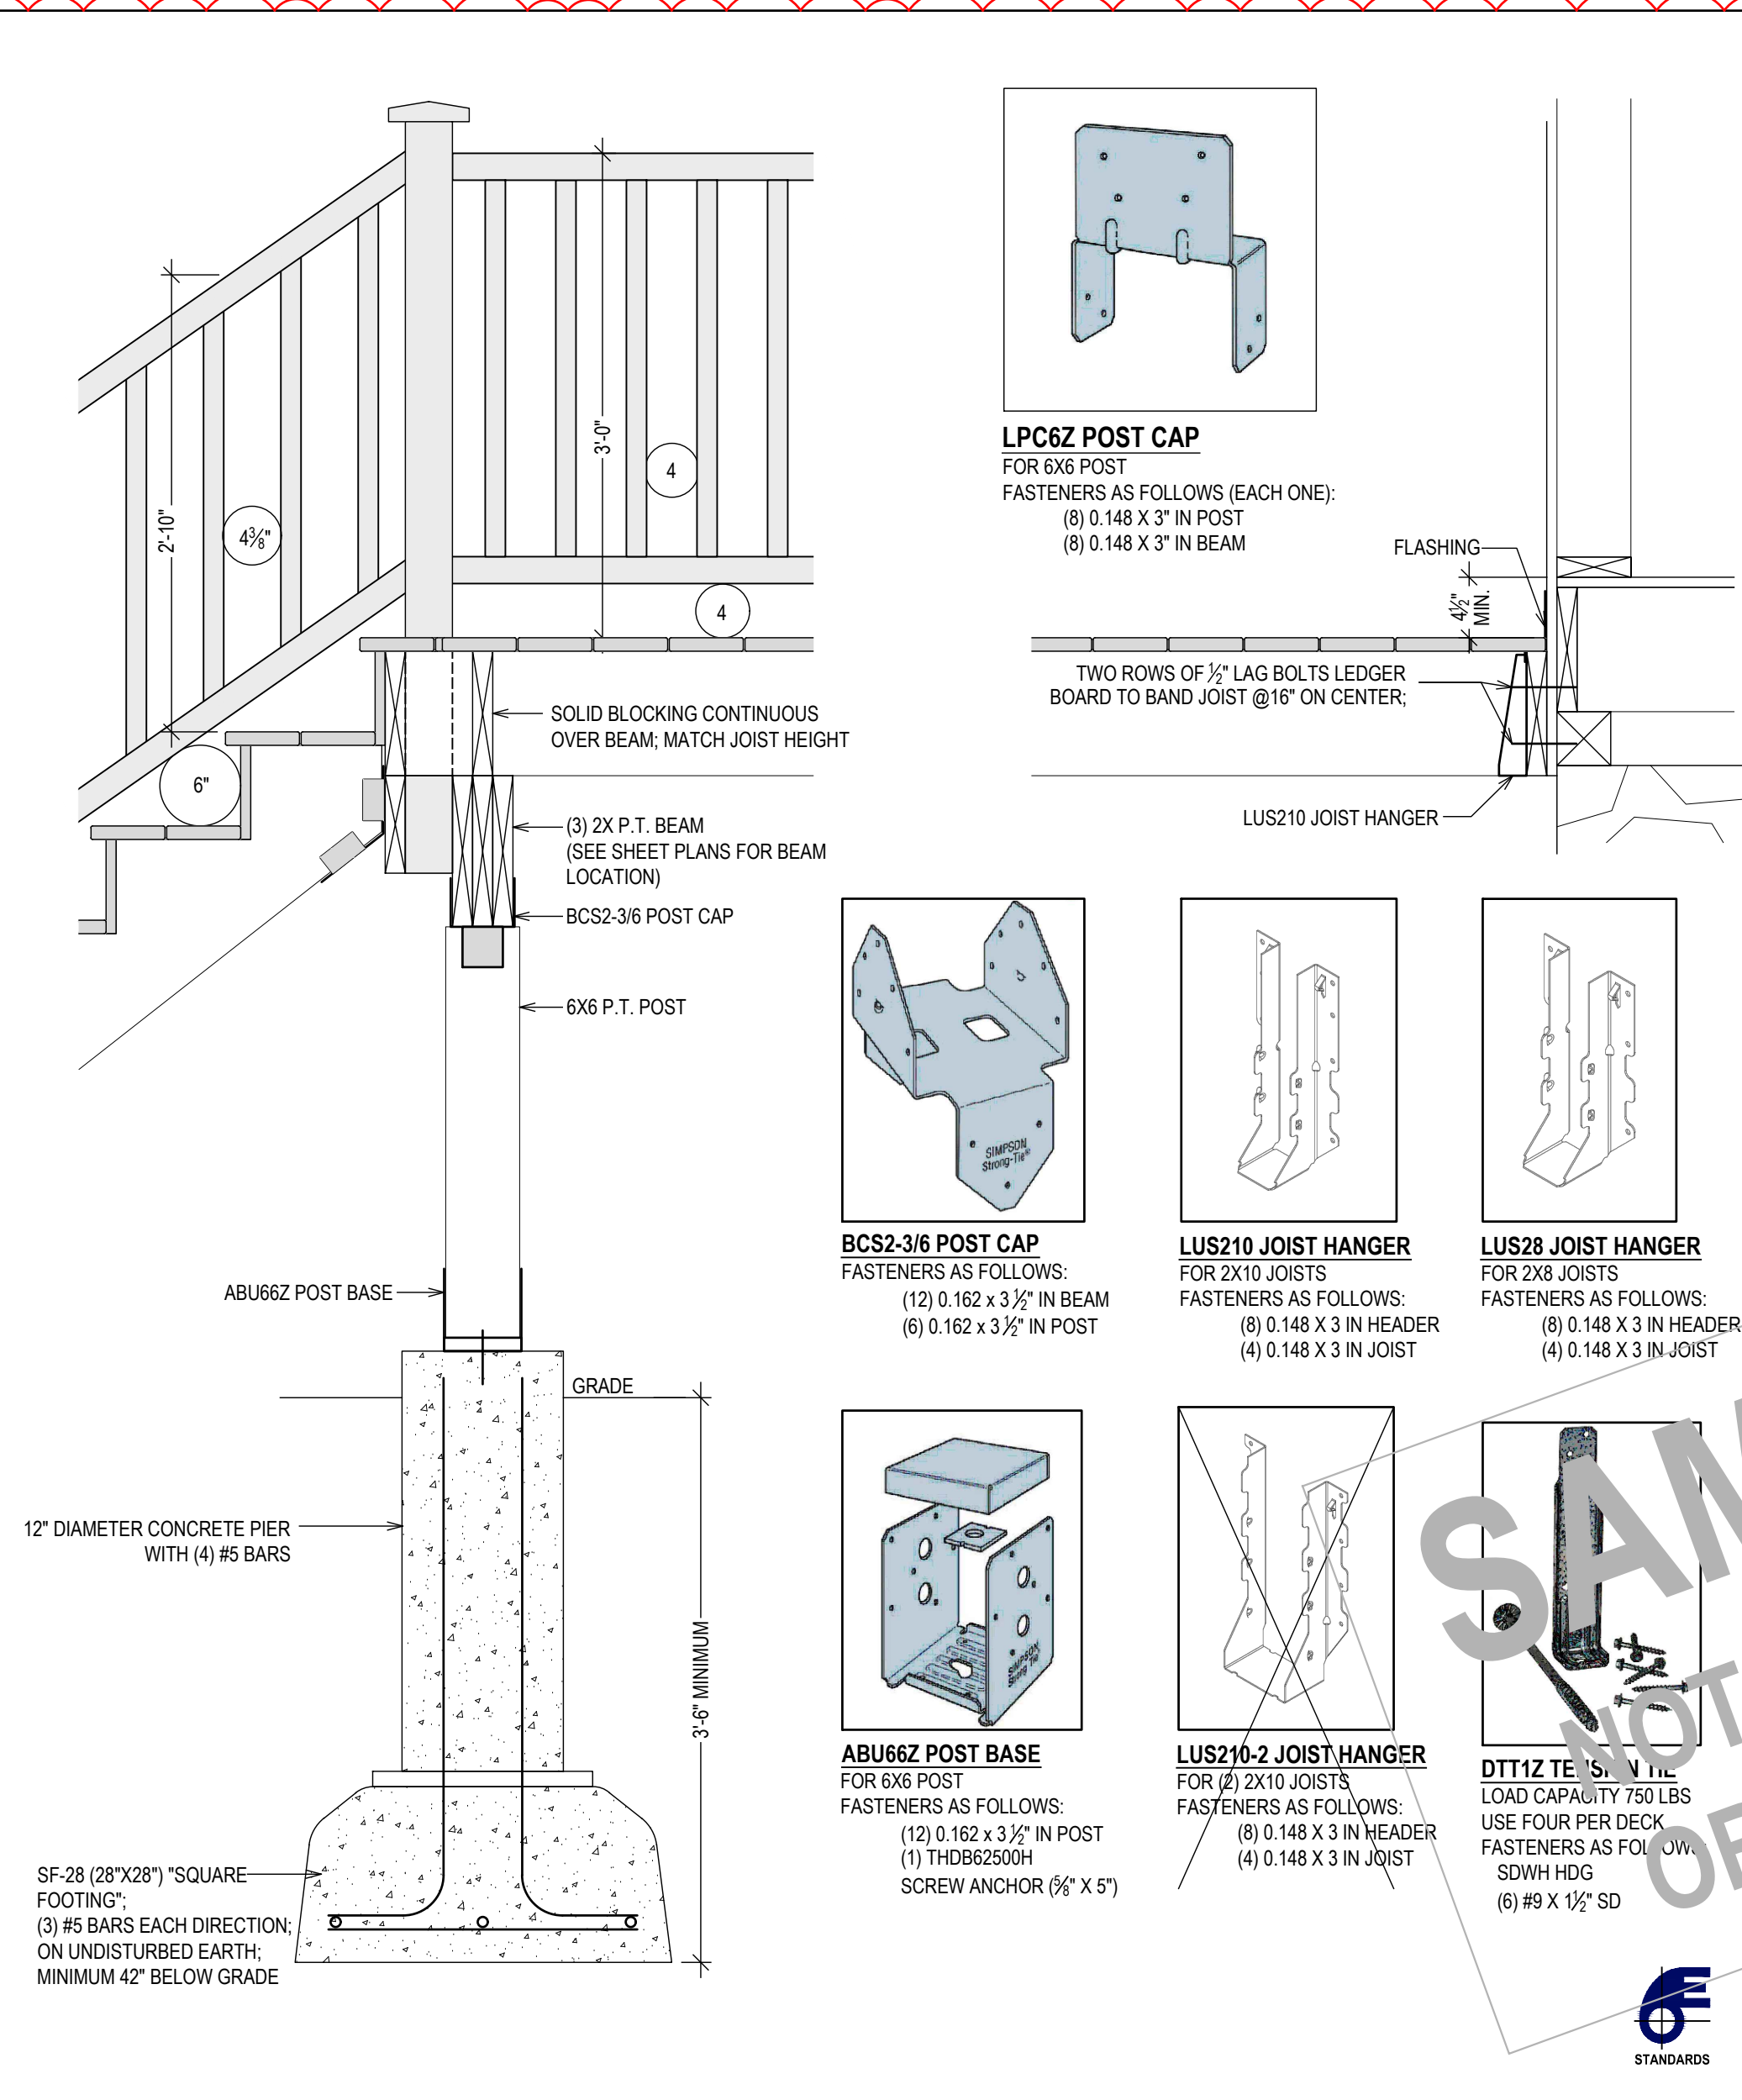

DECK SECTION: FOOTING, GUARD RAIL, STRUCTURE AND CONNECTIONS

1" = 1'-0"

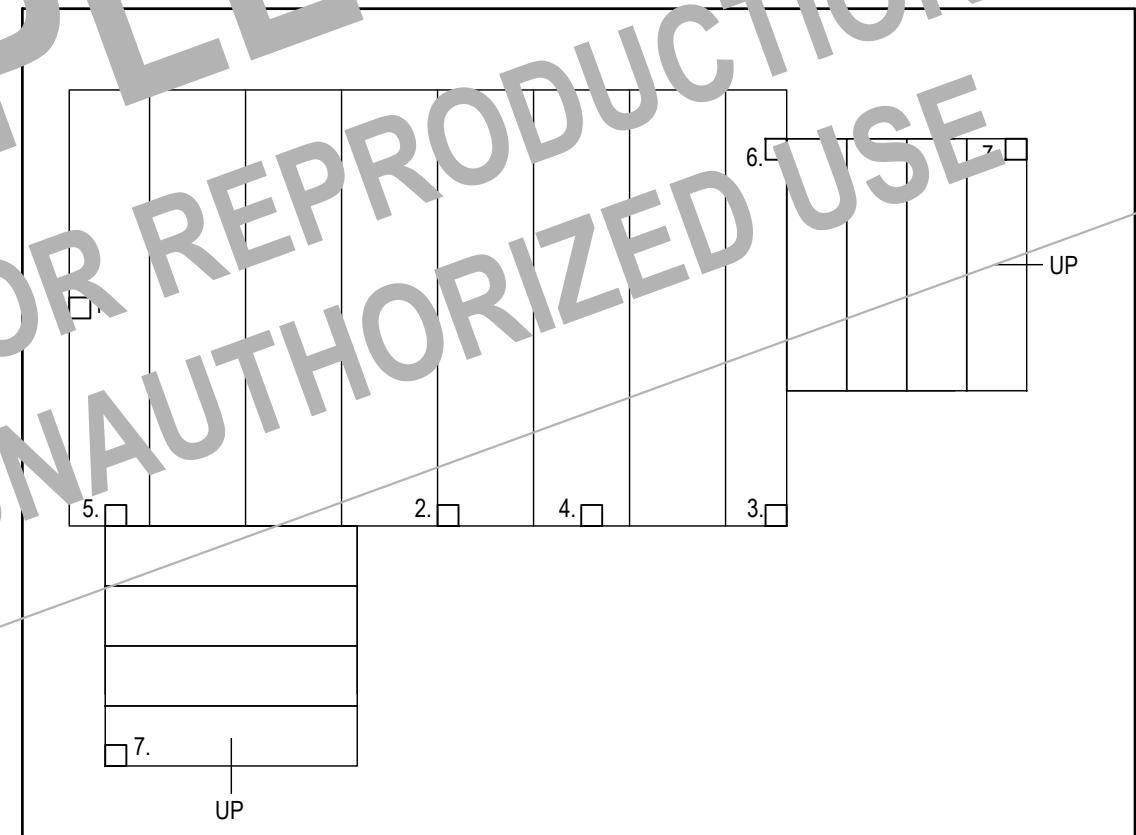

TYPICAL POST LOCATION CONNECTION DETAILS

(SEE DETAILS 1, THRU 7.)

PROPERTY ADDRESS:

PORT CHESTER, NY 10573
(VILLAGE OF PORT CHESTER
BUILDING DEPARTMENT)

S-B-L:

CLIENT:
*** **

TEL: ***

EMAIL:

DATE: 05.15.2025
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ISSUE: PRELIMINARY
FOR PERMIT
FOR PERMIT
AMENDMENT

PROJECT NAME:
FLOOR PLAN ALTERATION

DRAWING NAME:
TYPICAL DECK DETAILS

DRAWING NUMBER:
A-05.1.2


DATE:
05.15.2025

SCALE:
AS NOTED

NOTE:
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CONSTRUCTION IF (AND ONLY IF) A
PERMIT IS ISSUED, BASED ON THIS
DRAWING, BY THE VILLAGE OF PORT
CHESTER.

BATHROOM


1. BATHTUB & SHOWER SPACES:

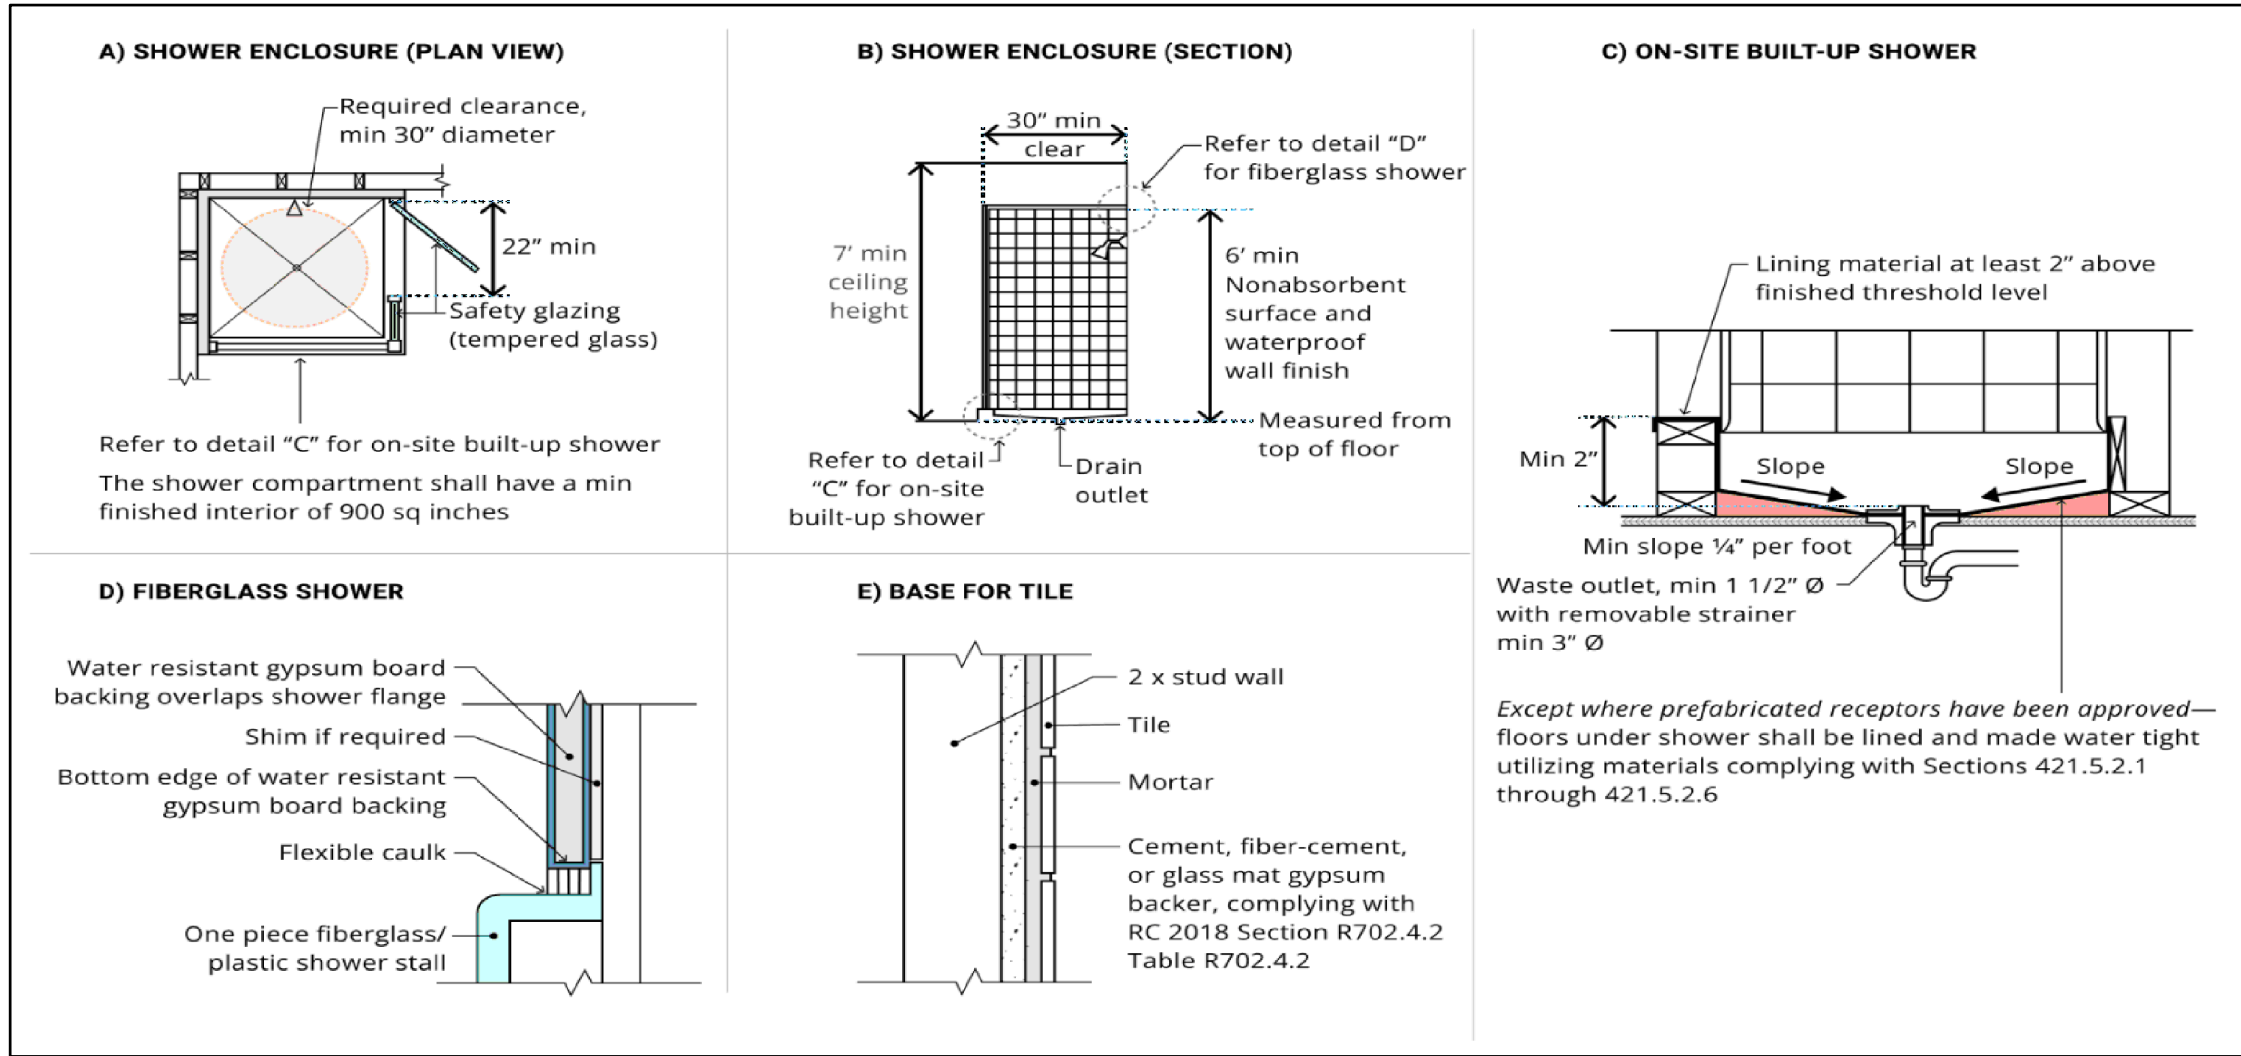

BATHTUB AND SHOWER FLOORS AND WALLS ABOVE BATHTUBS WITH INSTALLED SHOWER HEADS AND IN SHOWER COMPARTMENTS SHALL BE FINISHED WITH A NONABSORBENT SURFACE. SUCH WALL SURFACES SHALL EXTEND TO A HEIGHT OF NOT LESS THAN 6 FEET ABOVE THE FLOOR.


TYPICAL BATHROOM DETAILS
ALL CONFIGURATIONS MAY NOT APPLY

2. PLUMBING FIXTURE CLEARANCES:

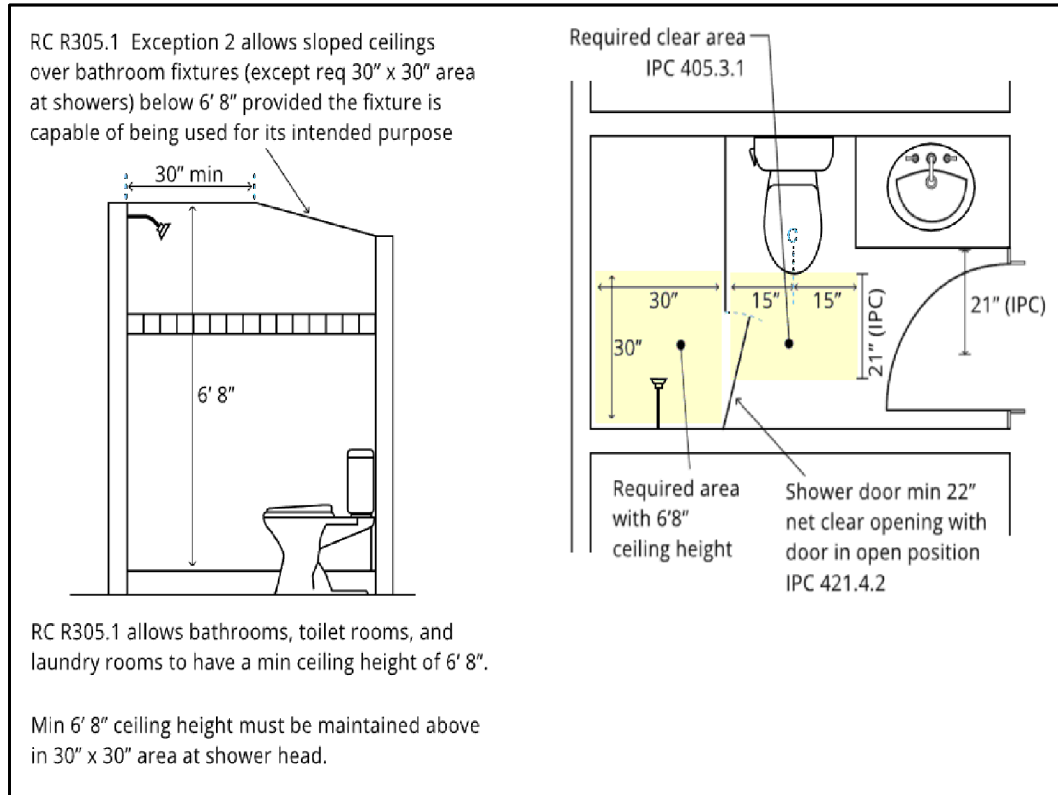

FIXTURE CLEARANCES (SECTION 405 OF THE PLUMBING CODE):
FIXTURE CLEARANCES SHOWN APPLY TO NON-ACCESSIBLE / ADA CONDITIONS. VERIFY WITH MULTIFAMILY HOUSING OR ACCESSIBLE FIXTURE CLEARANCE REQUIREMENTS WHEN FIXTURES ARE REQUIRED TO BE ACCESSIBLE.

WATER CLOSETS, URINALS, LAVATORIES AND BIDETS:
A WATER CLOSET, URINAL, LAVATORY OR BIDET SHALL NOT BE SET CLOSER THAN 15 INCHES FROM ITS CENTER TO ANY SIDE WALL, PARTITION, VANITY OR OTHER OBSTRUCTION. WHERE PARTITIONS OR OTHER OBSTRUCTIONS DO NOT SEPARATE ADJACENT WATER CLOSETS, URINALS, OR BIDETS, THE FIXTURES SHALL NOT BE SET CLOSER THAN 30 INCHES CENTER TO CENTER BETWEEN ADJACENT FIXTURES OR ADJACENT WATER CLOSETS, URINALS, OR BIDETS. THERE SHALL BE NOT LESS THAN A 21-INCH CLEARANCE IN FRONT OF A WATER CLOSET, URINAL, LAVATORY OR BIDET TO ANY WALL, FIXTURE OR DOOR. WATER CLOSET COMPARTMENTS SHALL BE NOT LESS THAN 30 INCHES IN WIDTH AND NOT LESS THAN 60 INCHES IN DEPTH FOR FLOOR-MOUNTED WATER CLOSETS AND NOT LESS THAN 30 INCHES IN WIDTH AND 56 INCHES IN DEPTH FOR WALL-HUNG WATER CLOSETS.

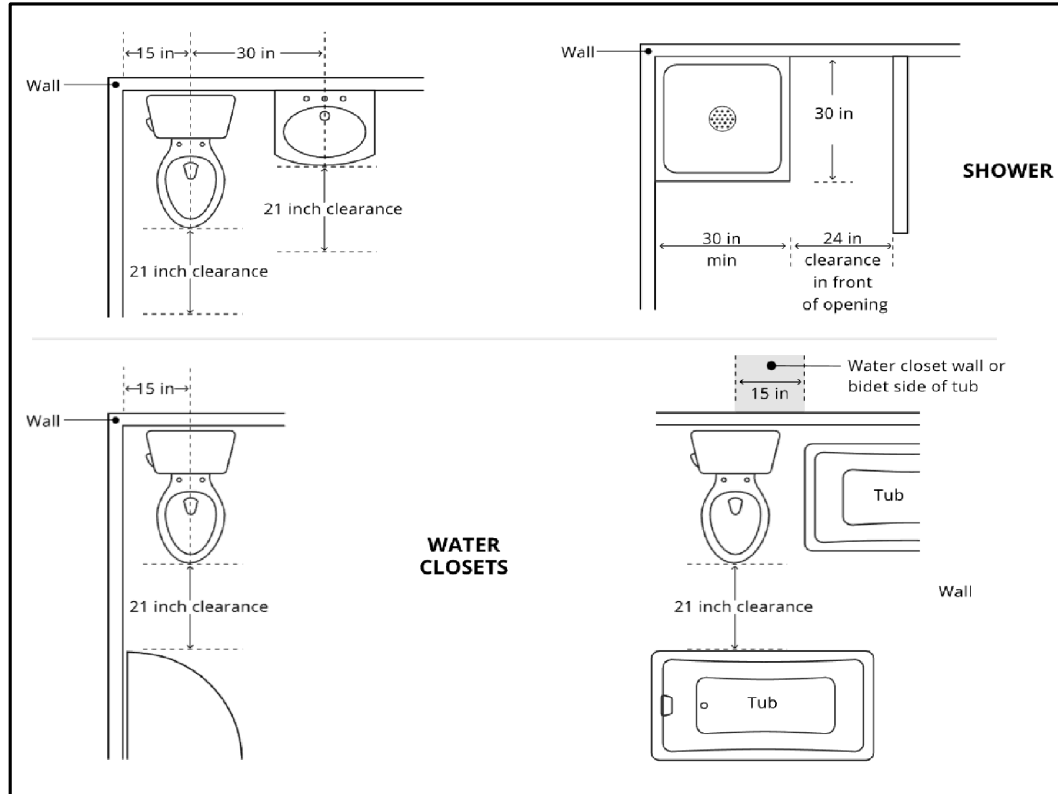

PLUMBING FIXTURE CLEARANCES:
PLUMBING FIXTURES REQUIRE MINIMUM AREAS IN FRONT TO PROVIDE SAFE USABILITY AND MAINTENANCE OF THE FIXTURE. SOME JURISDICTIONS MAY REQUIRE COMPLIANCE WITH PLUMBING CODES, WHICH MAY BE MORE STRINGENT THAN SHOWN IN THIS DIAGRAM. THESE CLEARANCES SHOULD NOT BE CONFUSED WITH THE CLEARANCES REQUIRED FOR DISABLED ACCESS.

THE LOCATION OF PIPING, FIXTURES OR EQUIPMENT SHALL NOT INTERFERE WITH THE OPERATION OF WINDOWS OR DOORS.

FIXTURE INSTALLATION:
FLOOR-OUTLET OR FLOOR-MOUNTED FIXTURES SHALL BE SECURED TO THE DRAINAGE CONNECTION AND TO THE FLOOR, WHERE SO DESIGNED, BY SCREWS, BOLTS, WASHERS, NUTS AND SIMILAR FASTENERS OF COPPER, COPPER ALLOY OR OTHER CORROSION RESISTANT MATERIAL. WALL-HUNG FIXTURES SHALL BE RIGIDLY SUPPORTED SO THAT STRAIN IS NOT TRANSMITTED TO THE PLUMBING SYSTEM. WHERE FIXTURES COME IN CONTACT WITH WALLS AND FLOORS, THE CONTACT AREA SHALL BE WATERTIGHT.

3. WALL COVERINGS:

WATER-RESISTANT GYPSUM BACKING BOARD (R702.3.7):
GYPSUM BOARD USED AS THE BASE OR BACKER FOR ADHESIVE APPLICATION OF CERAMIC TILE OR OTHER REQUIRED NONABSORBENT FINISH MATERIAL SHALL CONFORM TO ASTM C1178, C1278 OR C1396.

USE OF WATER-RESISTANT GYPSUM BACKING BOARD SHALL BE PERMITTED ON CEILINGS. WATER-RESISTANT GYPSUM BOARD SHALL NOT BE INSTALLED OVER A CLASS I OR II VAPOR RETARDER IN A SHOWER OR TUB COMPARTMENT. CUT OR EXPOSED EDGES, INCLUDING THOSE AT WALL INTERSECTIONS, SHALL BE SEALED AS RECOMMENDED BY THE MANUFACTURER.

LIMITATIONS: WATER-RESISTANT GYPSUM BACKING BOARD SHALL NOT BE USED WHERE THERE WILL BE DIRECT EXPOSURE TO WATER, OR IN AREAS SUBJECT TO CONTINUOUS HIGH HUMIDITY.

BACKER BOARDS FOR CERAMIC TILE (R702.4.2):
MATERIALS USED AS BACKERS FOR WALL TILE IN TUB AND SHOWER AREAS AND WALL PANELS IN SHOWER AREAS SHALL BE OF MATERIALS LISTED BELOW (PER TABLE R702.4.2) AND INSTALLED IN ACCORDANCE WITH THE MANUFACTURER'S RECOMMENDATIONS.

MATERIAL	STANDARD
GLASS MAT GYPSUM BACKING PANEL	ASTM C1178
FIBER-REINFORCED GYPSUM PANELS	ASTM C1278
NONASBESTOS FIBER-CEMENT BACKER BOARD	ASTM C1288 OR ISO 8336, CATEGORY C
NONASBESTOS FIBER MAT-REINFORCED CEMENTITIOUS BACKER UNITS	ASTM C1325

4. LIGHT AND VENTILATION

BATHROOMS
BATHROOMS, WATER CLOSET COMPARTMENTS AND OTHER SIMILAR ROOMS SHALL BE PROVIDED WITH AGGREGATE GLAZING AREA IN WINDOWS OF NOT LESS THAN 3 SQUARE FEET, ONE-HALF OF WHICH SHALL BE OPENABLE.

EXCEPTION:
THE GLAZED AREAS SHALL NOT BE REQUIRED WHERE ARTIFICIAL LIGHT AND A LOCAL EXHAUST SYSTEM ARE PROVIDED; MINIMUM LOCAL EXHAUST RATES SHALL BE DETERMINED IN ACCORDANCE WITH SECTION M1505. EXHAUST AIR FROM THE SPACE SHALL BE EXHAUSTED DIRECTLY TO THE OUTDOORS.

MECHANICAL VENTILATION (M1505):
EXHAUST AIR FROM BATHROOMS AND TOILET ROOMS SHALL NOT BE RECIRCULATED WITHIN A RESIDENCE OR CIRCULATED TO ANOTHER DWELLING UNIT AND SHALL BE EXHAUSTED DIRECTLY TO THE OUTDOORS.


EXHAUST AIR FROM BATHROOMS, TOILET ROOMS AND KITCHENS SHALL NOT DISCHARGE INTO AN ATTIC, CRAWL SPACE OR OTHER AREAS INSIDE THE BUILDING. EXHAUST EQUIPMENT SERVING SINGLE DWELLING UNITS SHALL BE LISTED AND LABELED AS PROVIDING THE MINIMUM REQUIRED AIRFLOW IN ACCORDANCE WITH ANSI/AMCA 210-ANSI/ASHRAE 51.

LOCAL EXHAUST SYSTEMS SHALL BE DESIGNED TO HAVE THE CAPACITY TO EXHAUST THE MINIMUM AIRFLOW RATE DETERMINED AS FOLLOWS:
BATHROOMS-TOILET ROOMS MECHANICAL EXHAUST CAPACITY OF 50 CFM INTERMITTENT, OR 20 CFM CONTINUOUS

5. SAFETY GLAZING:


GLAZING AND WET SURFACES (R308.4.5):
GLAZING IN WALLS, ENCLOSURES OR FENCES CONTAINING OR FACING HOT TUBS, SPAS, WHIRLPOOLS, SAUNAS, STEAM ROOMS, BATHTUBS, SHOWERS AND INDOOR OR OUTDOOR SWIMMING POOLS WHERE THE BOTTOM EXPOSED EDGE OF THE GLAZING IS LESS THAN 60 INCHES MEASURED VERTICALLY ABOVE ANY STANDING OR WALKING SURFACE SHALL BE CONSIDERED TO BE A HAZARDOUS LOCATION. THIS SHALL APPLY TO SINGLE GLAZING AND ALL PANES IN MULTIPLE GLAZING.

EXCEPTION: GLAZING THAT IS MORE THAN 60 INCHES, MEASURED HORIZONTALLY AND IN A STRAIGHT LINE, FROM THE WATER'S EDGE OF A BATHTUB, HOT TUB, SPA, WHIRLPOOL OR SWIMMING POOL.



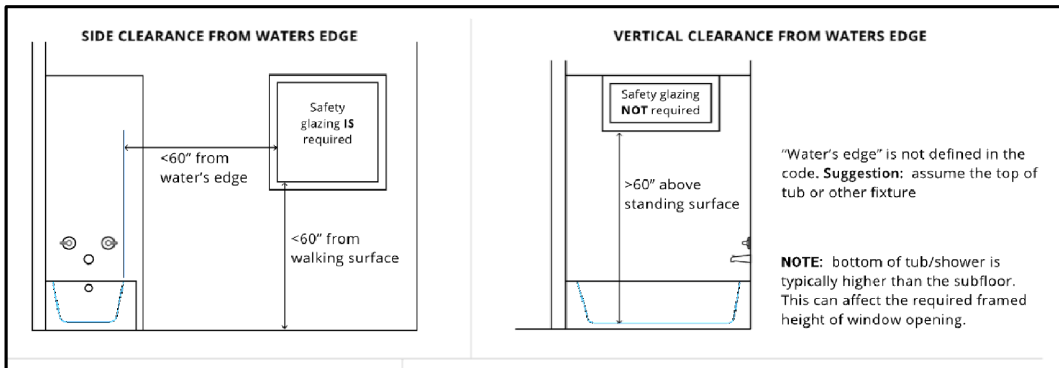


IDENTIFICATION OF SAFETY GLAZING (R308.1):
EXCEPT AS INDICATED IN SECTION R308.1.1 EACH PANE OF GLAZING INSTALLED IN HAZARDOUS LOCATIONS AS DEFINED IN SECTION R308.4 SHALL BE PROVIDED WITH A MANUFACTURER'S DESIGNATION SPECIFYING WHO APPLIED THE DESIGNATION, THE TYPE OF GLASS AND THE SAFETY GLAZING STANDARD WITH WHICH IT COMPLIES, AND THAT IS VISIBLE IN THE FINAL INSTALLATION. THE DESIGNATION SHALL BE ACID ETCHED, SANDBLASTED, CERAMIC-FIRED, LASER ETCHED, EMBOSSED, OR BE OF A TYPE THAT ONCE APPLIED CANNOT BE REMOVED WITHOUT BEING DESTROYED. A LABEL SHALL BE PERMITTED IN LIEU OF THE MANUFACTURER'S DESIGNATION.


EXCEPTIONS: FOR OTHER THAN TEMPERED GLASS, MANUFACTURER'S DESIGNATIONS ARE NOT REQUIRED PROVIDED THAT THE BUILDING OFFICIAL APPROVES THE USE OF A CERTIFICATE, AFFIDAVIT OR OTHER EVIDENCE CONFIRMING COMPLIANCE WITH THIS CODE.

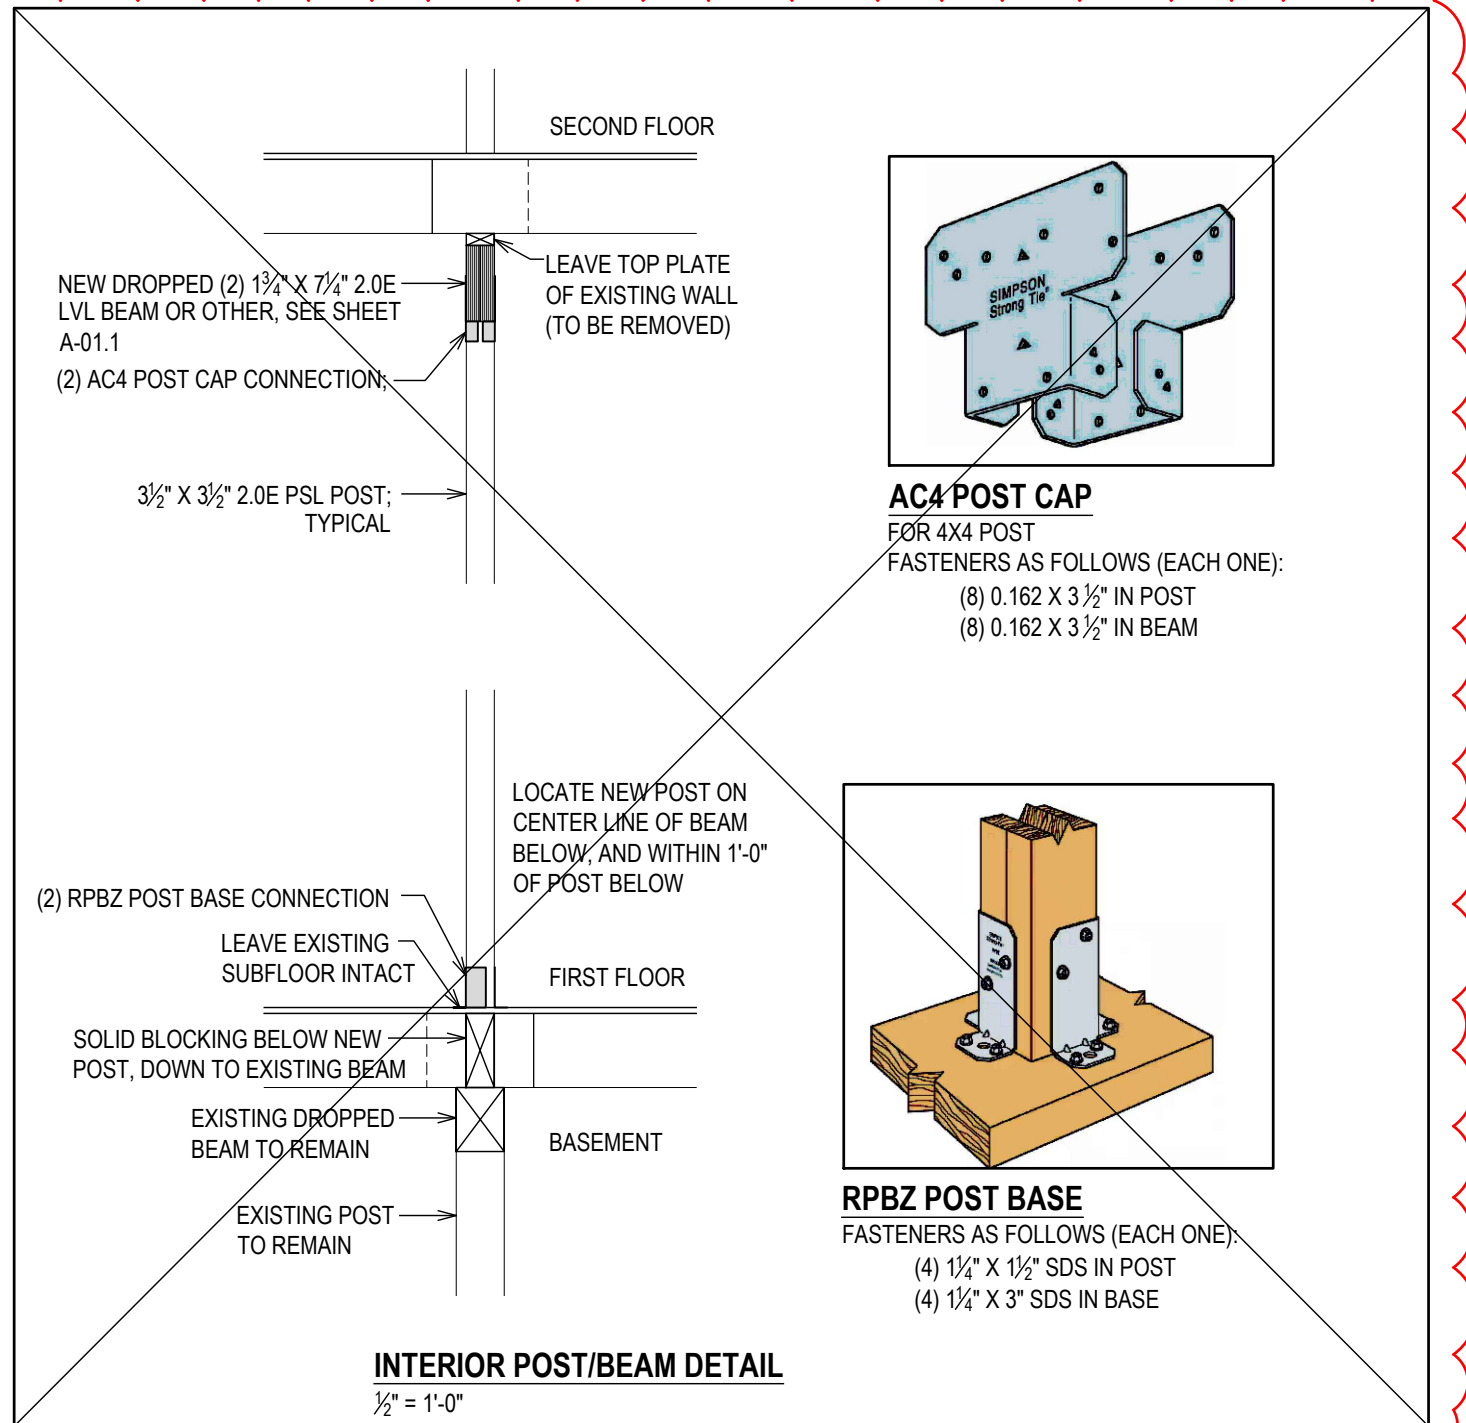

2

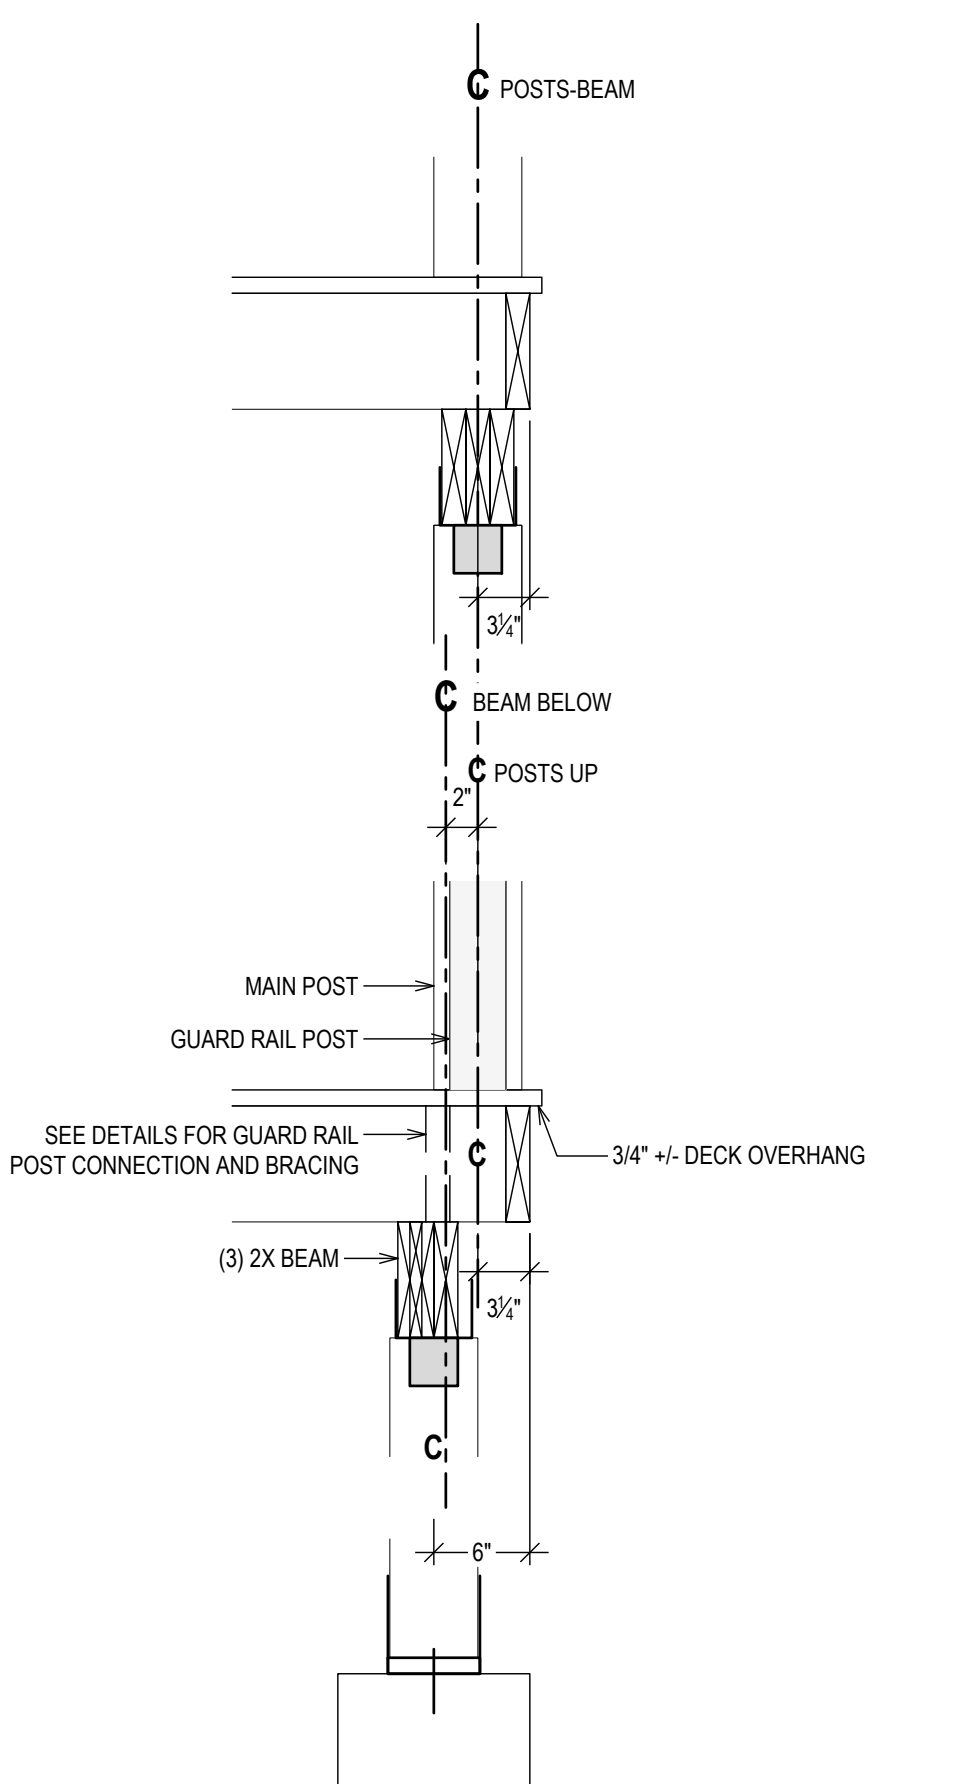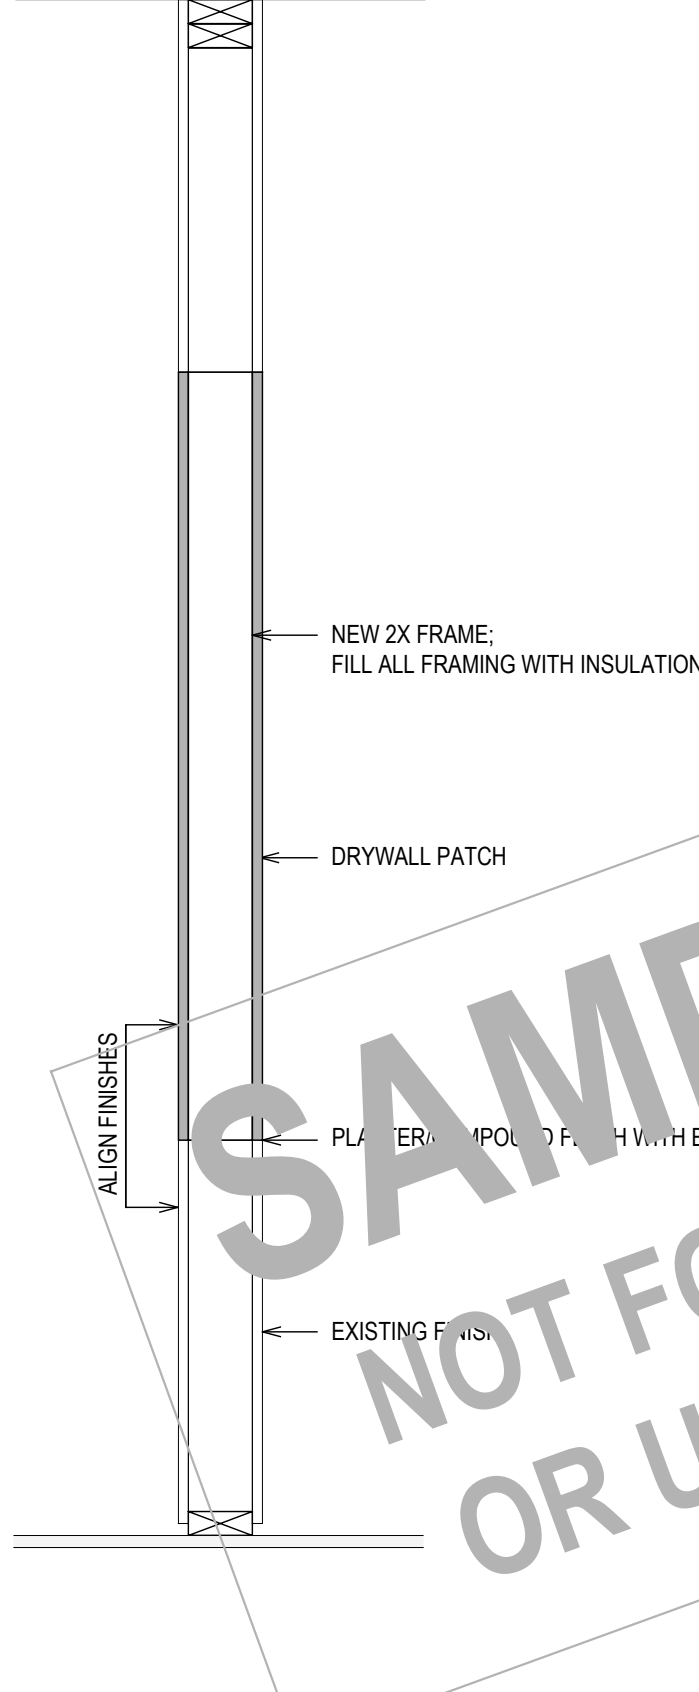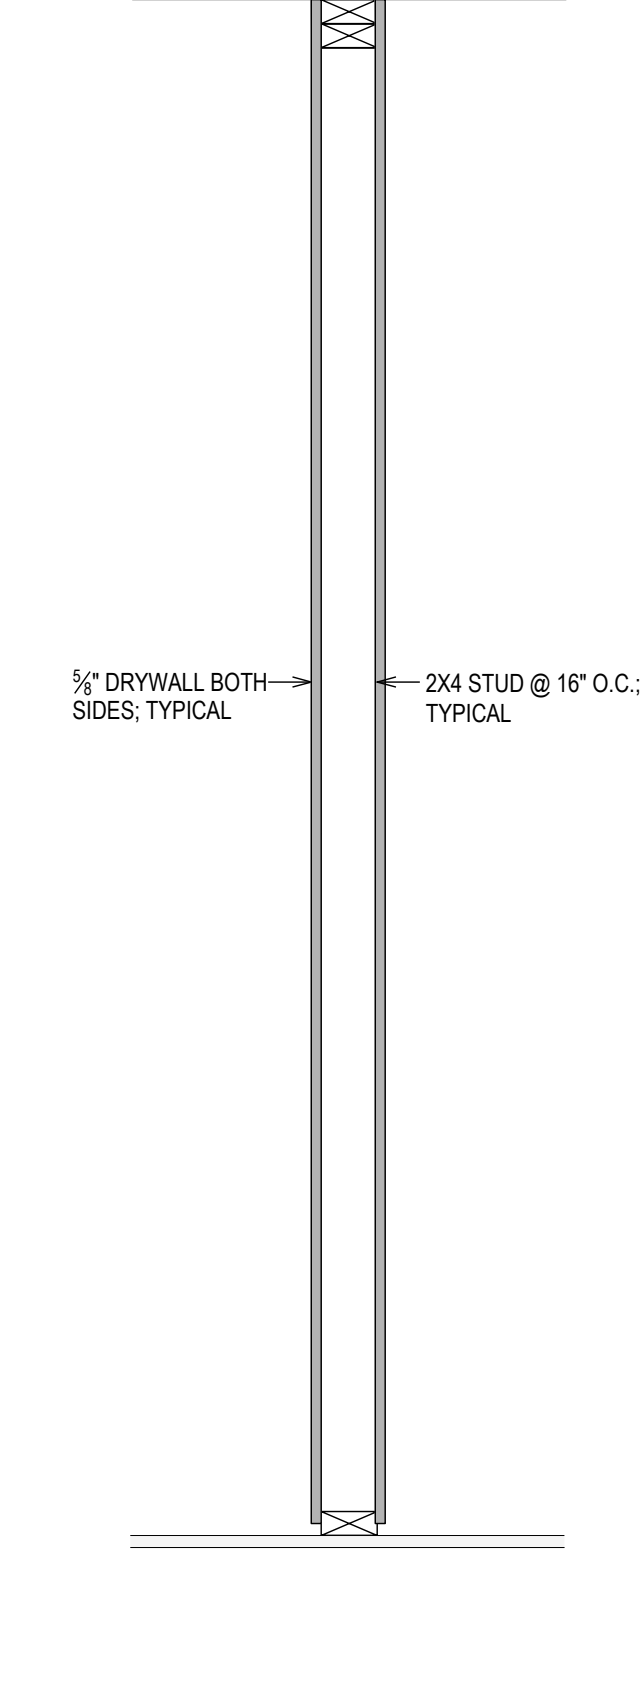

POST/BEAM DETAIL
1" = 1'-0"

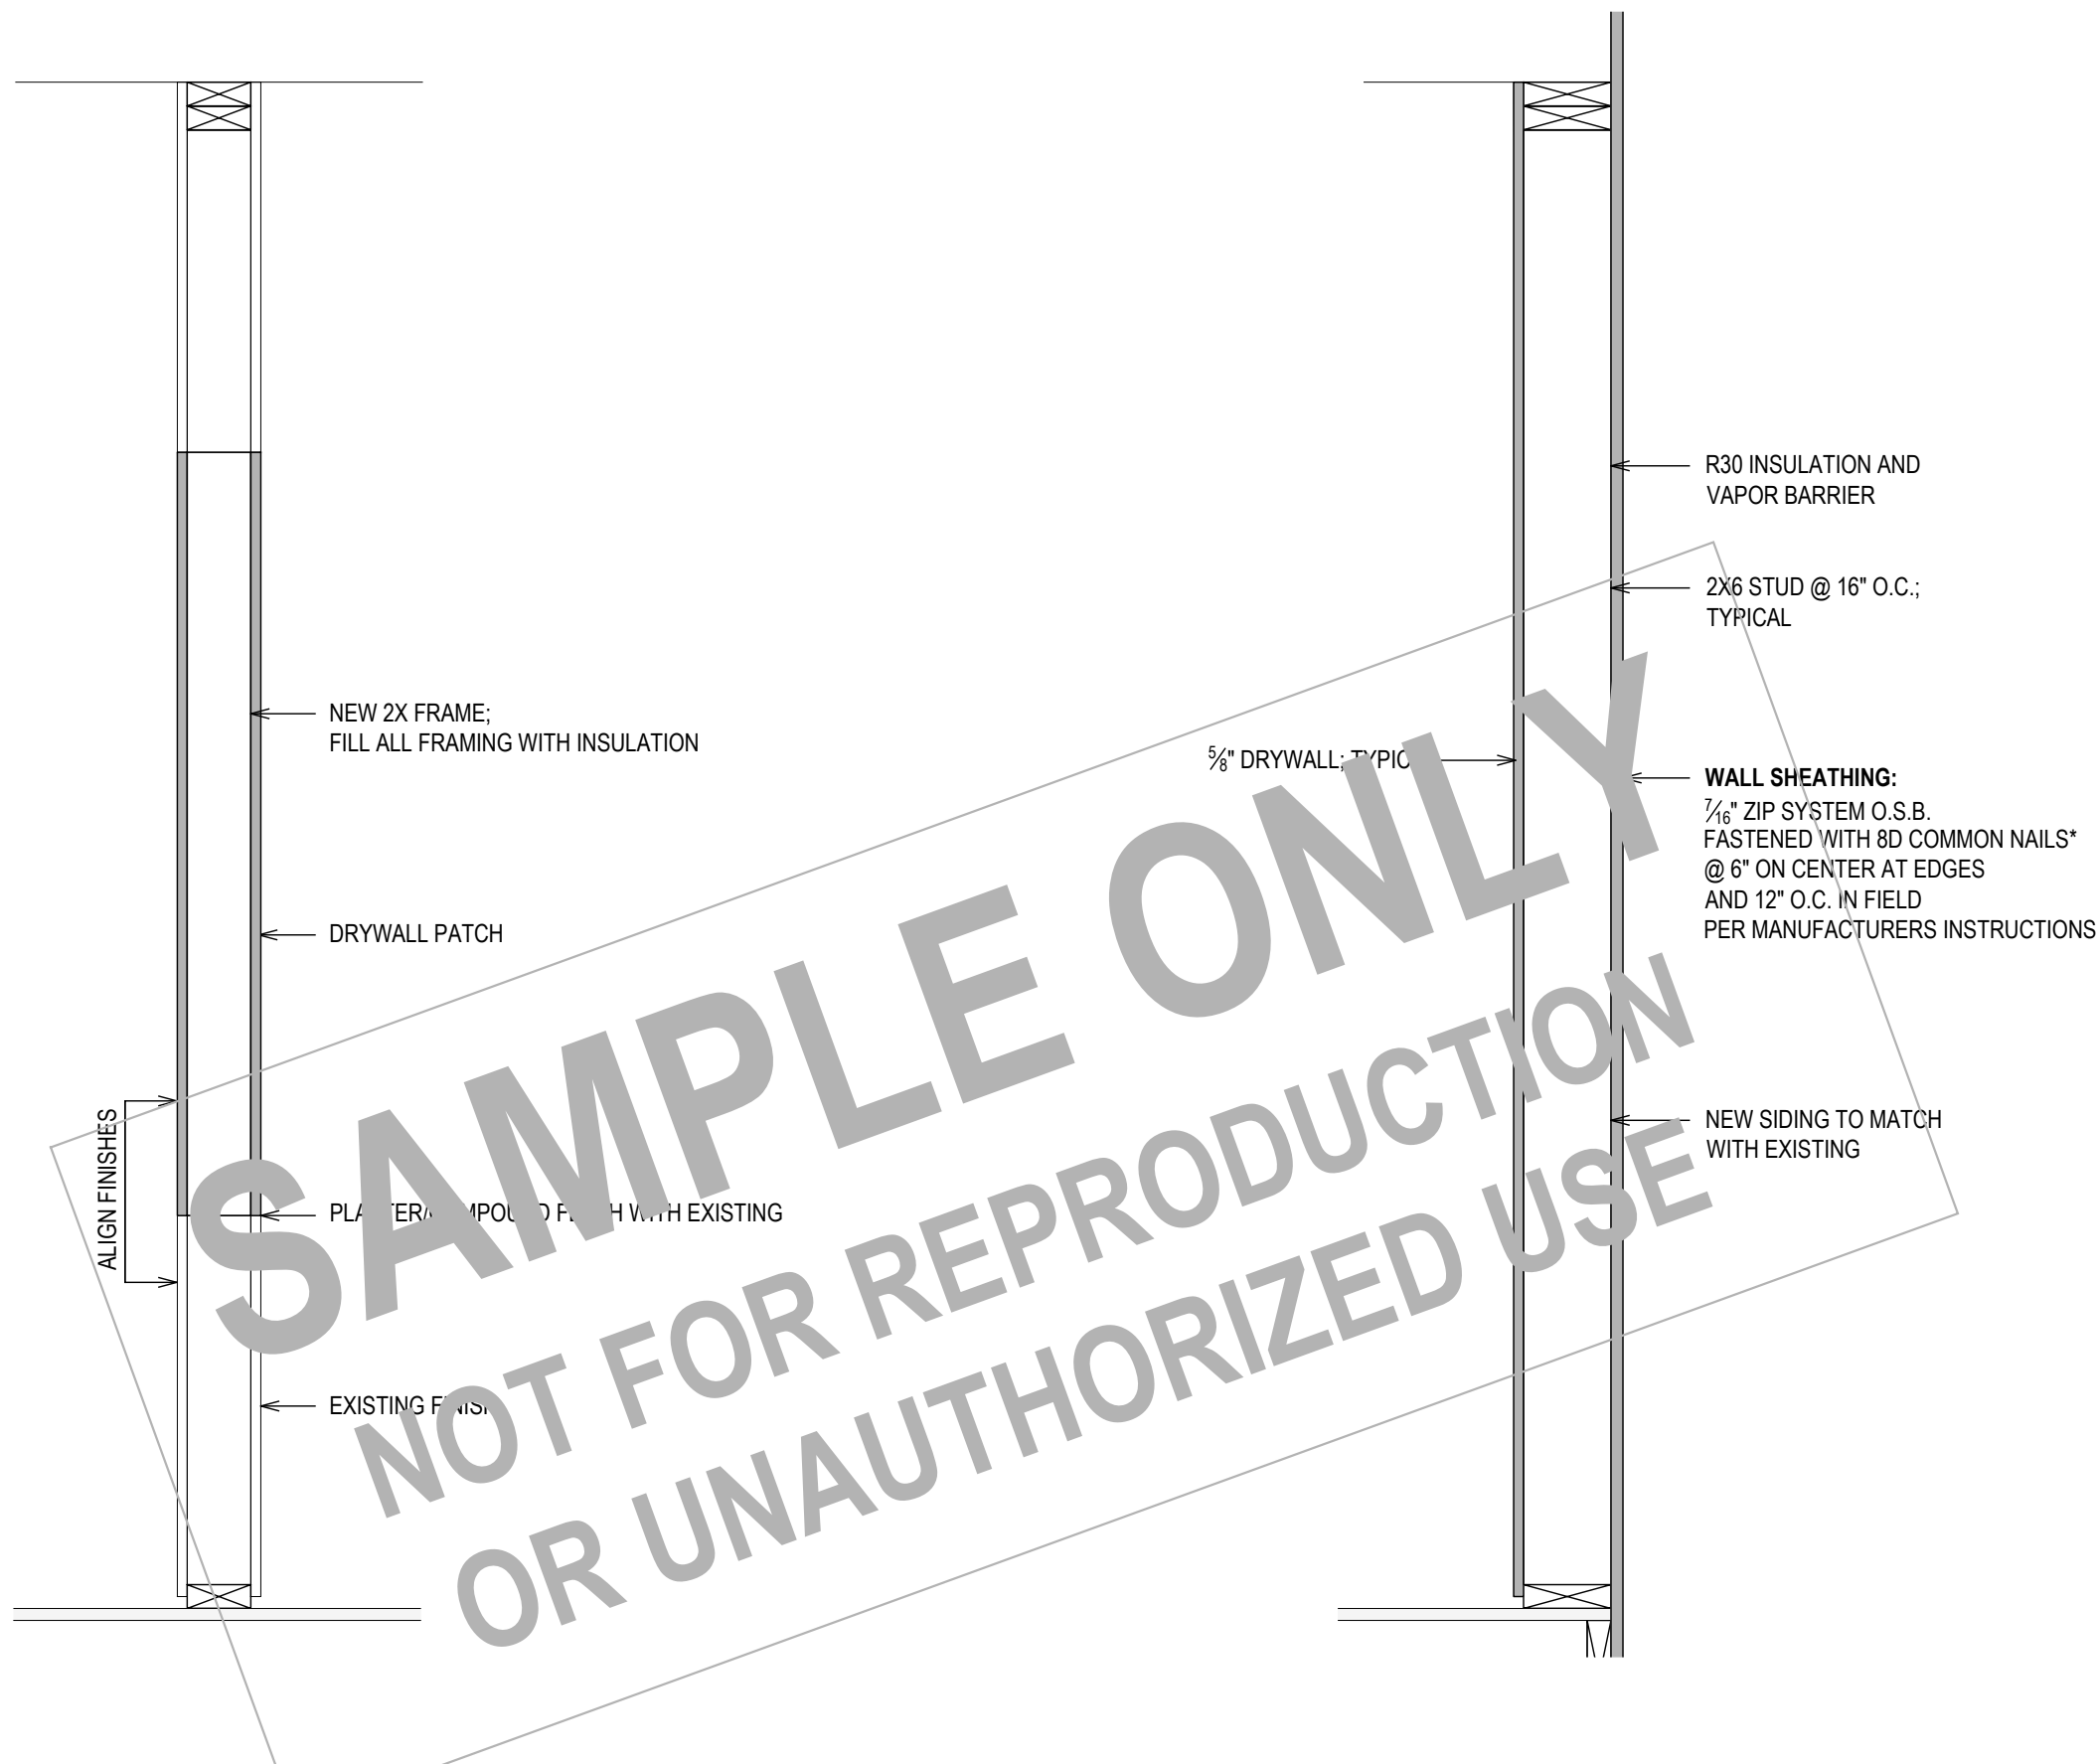

NEW EXTERIOR WALL, TYPICAL
1" = 1'-0"

PROPERTY ADDRESS:

PORT CHESTER, NY 10573
(VILLAGE OF PORT CHESTER BUILDING DEPARTMENT)

S-B-L:

CLIENT:

*** ***

TEL:

EMAIL:

DATE:

05.15.2025

07.23.2025

08.15.2025

12.04.2025

⚠

ISSUE:

PRELIMINARY

FOR PERMIT

FOR PERMIT

AMENDMENT

PROJECT NAME:

FLOOR PLAN ALTERATION

DRAWING NAME:

TYPICAL DETAILS

DRAWING NUMBER:

A-06.1

DATE:

05.15.2025

SCALE:


AS NOTED

NOTE:


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Oliver Engineering, P.C.
Design - Permit Applications - Legalizations
Code Compliance - Project Supervision
188 N 2nd St, Port Chester, NY 10573
(914) 774-5878 | www.proeng.nyc | vc@proeng.nyc

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BASEMENT ELECTRICAL PLAN (NO WORK THIS AREA)
1/4" = 1'-0"

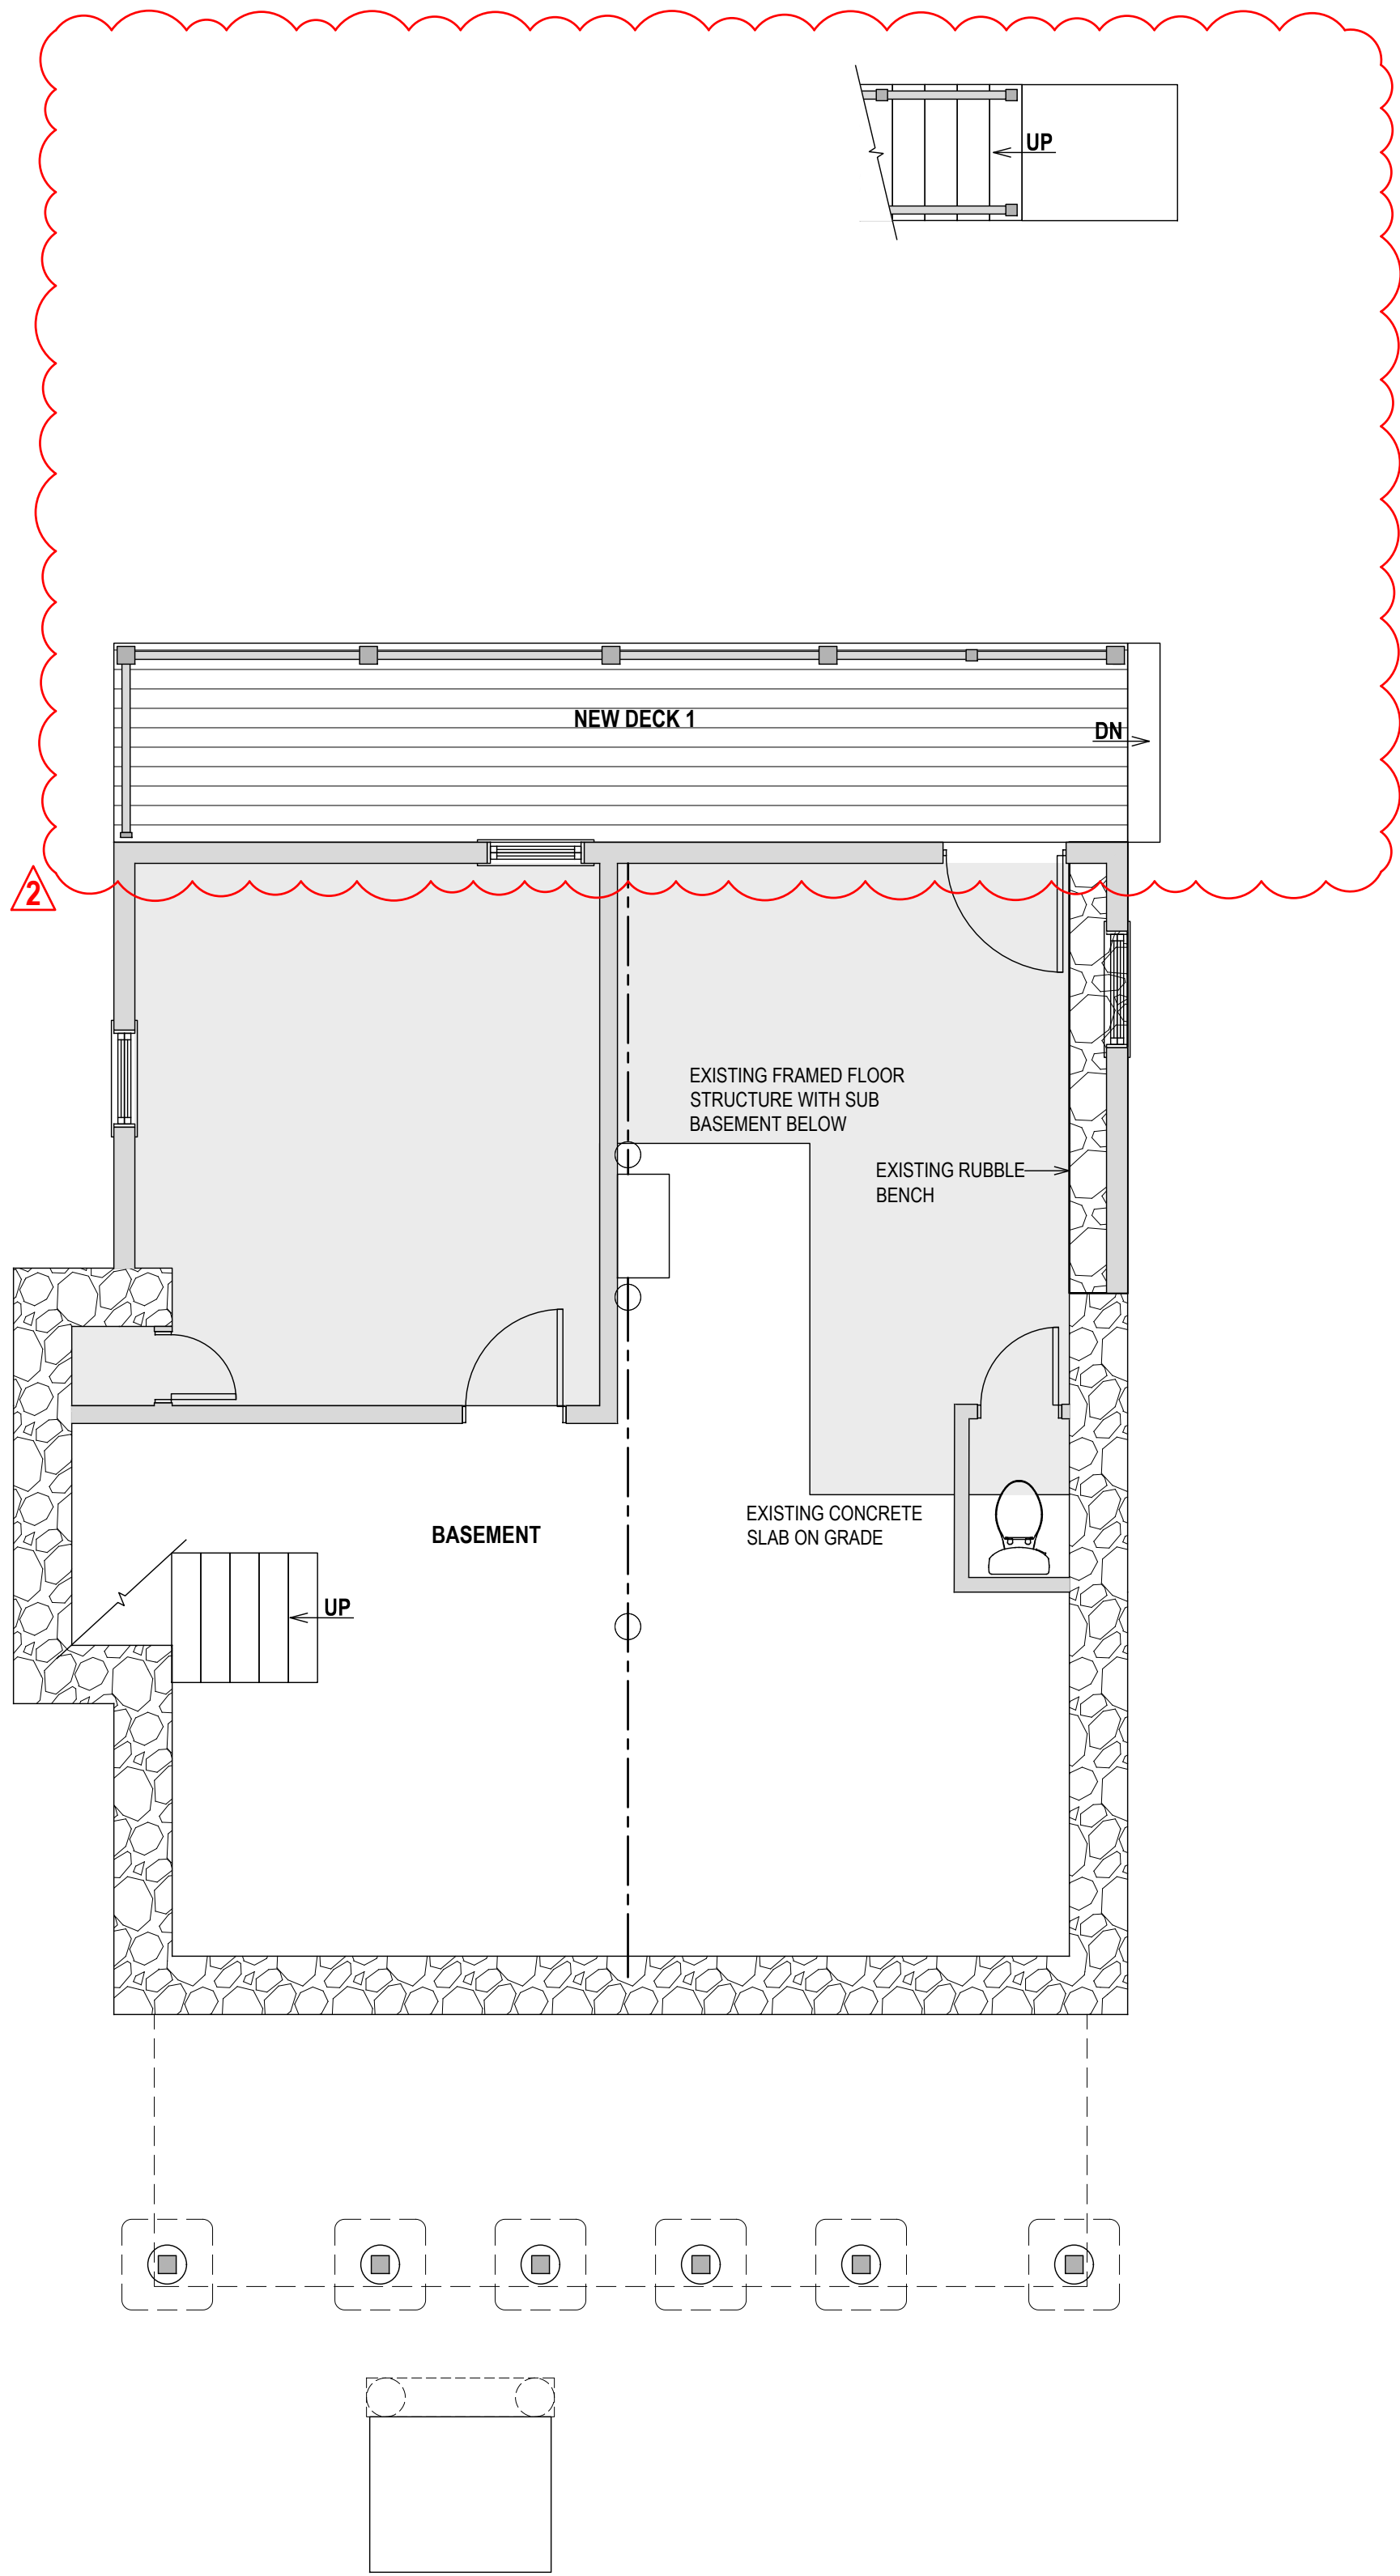

FIRST FLOOR ELECTRICAL PLAN
1/4" = 1'-0"

- LEGEND:**
- \$ SINGLE POLE SWITCH
 - \$3 SWITCH 3-WAY
 - Ⓜ GFI GFI OUTLET
 - ⊕ RECESSED FIXTURE
 - Ⓜ RECESSED LIGHT/FAN FIXTURE; VENT ALL EXHAUST FAN TO EXTERIOR
 - ⊗ PENDANT/CHANDELIER
 - Ⓢ CARBON MONOXIDE DETECTOR
 - Ⓢ SMOKE DETECTOR

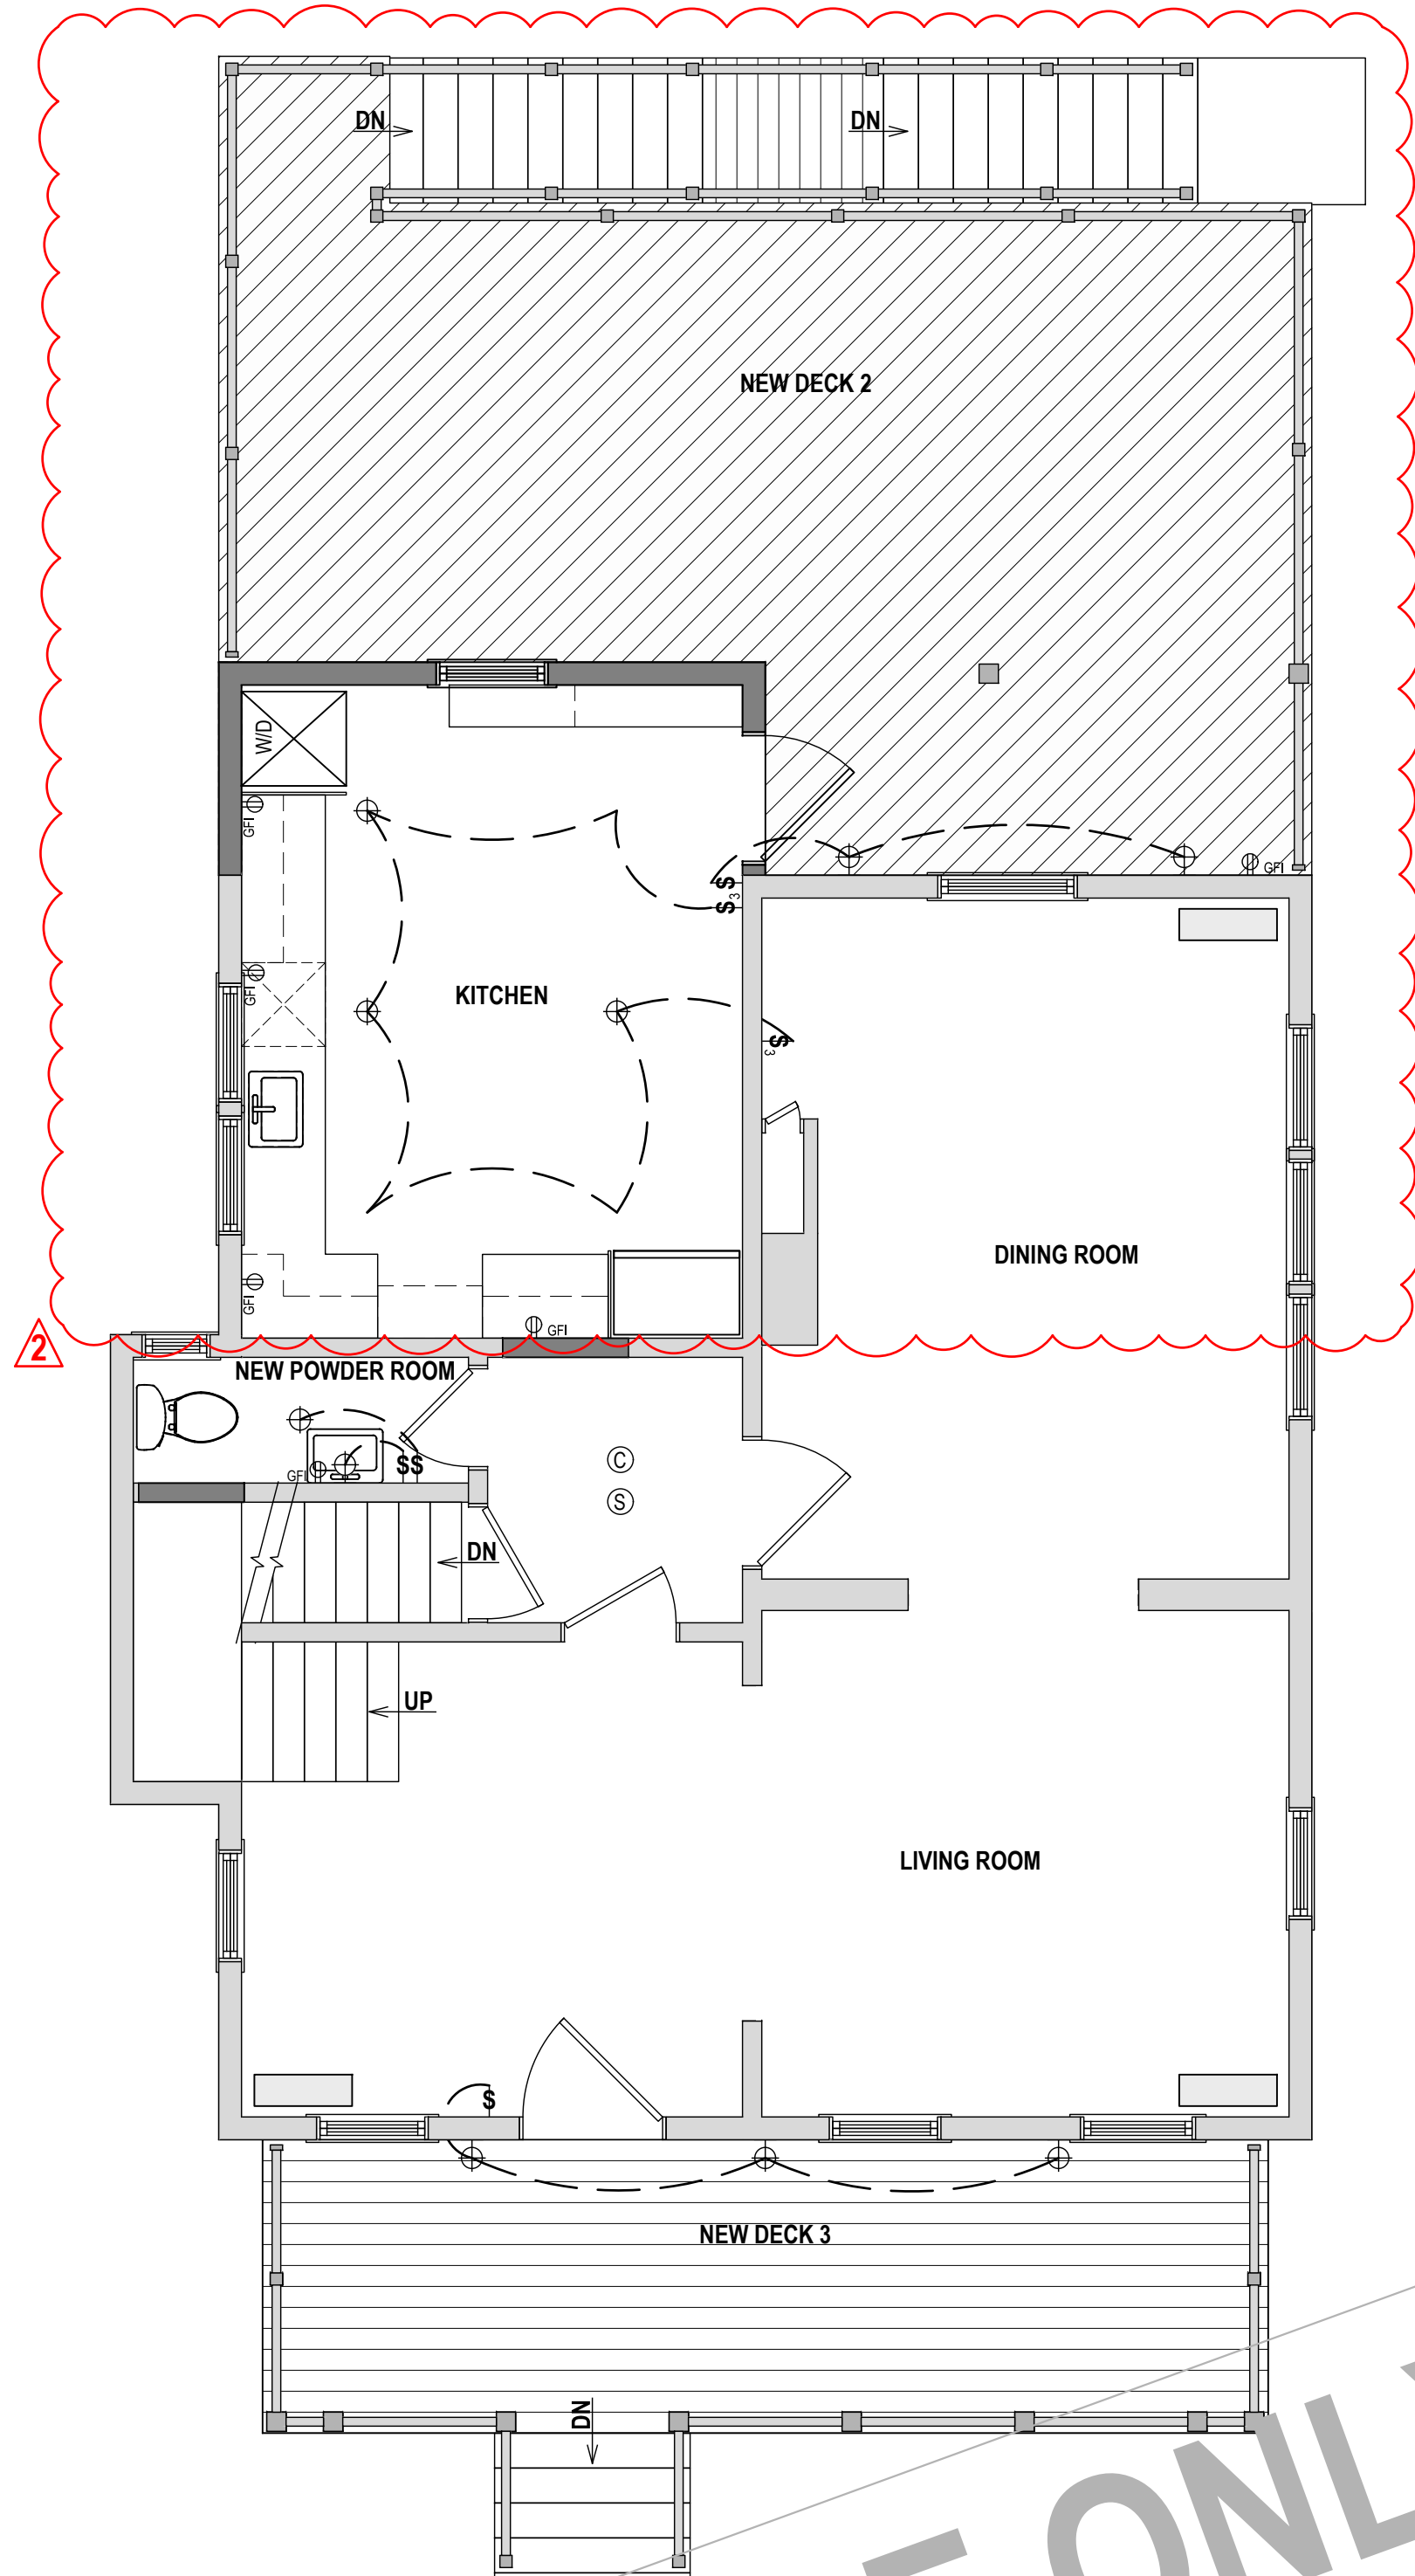PROPERTY ADDRESS:

PORT CHESTER, NY 10573
(VILLAGE OF PORT CHESTER
BUILDING DEPARTMENT)

S-B-L:

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DATE: 05.15.2025 ISSUE: PRELIMINARY
07.23.2025 FOR PERMIT
08.15.2025 FOR PERMIT
12.04.2025 AMENDMENT

PROJECT NAME:
FLOOR PLAN ALTERATION

DRAWING NAME:
ELECTRICAL 01

DRAWING NUMBER:
E-01

DATE:
05.15.2025
SCALE:
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