

LOCATION **GOOGLE MAPS**



SATELLITE VIEW GOOGLE EARTH

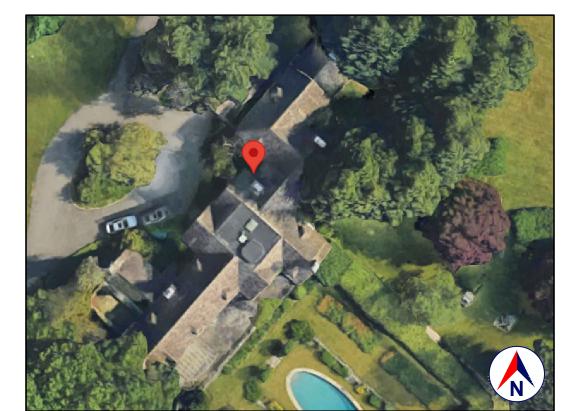

TAX MAP & TOO **WESTCHESTER COUNTY GIS**

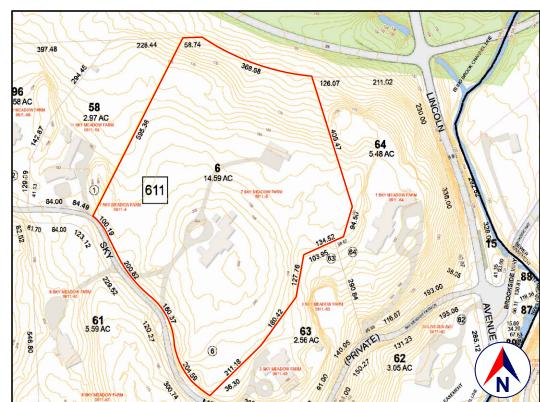

EXTERIOR VIEW

THIS DRAWING IS AS A SAMPLE ONLY * PERSONAL (CLIENT) INFORMATION WITHHELD

1.0 GENERAL REQUIREMENTS:

1.1 DESIGN INTENT:

THESE (STRUCTURAL) DRAWINGS ADDRESS ONLY THE STRUCTURAL INTEGRITY, BASED ON THE STIPULATED LOADS, OF THE PROPOSED CONSTRUCTION.

THESE DRAWINGS SHOULD ONLY BE USED IN CONJUNCTION WITH THE ARCHITECTURAL AND OTHER

IT IS THE OVERALL INTENT OF (ALL OF THE DRAWINGS) TO CALL FOR COMPLETE AND FINISHED WORK, IN COMPLIANCE WITH THE NOTED CODES, AND TESTED AND GUARANTEED AND READY FOR

THESE (STRUCTURAL) DRAWINGS ARE NOT INTENDED TO ADDRESS: ZONING: DRAINAGE: GRADING: OR

OTHER SITE ISSUES. THESE (STRUCTURAL) DRAWINGS ARE NOT INTENDED TO ADDRESS: BUILDING PLANNING; DIMENSIONAL COORDINATION; THERMAL OR MOISTURE PROTECTION; EGRESS; FIRE PROTECTION; MECHANICAL; HEAT, LIGHT AND VENTILATION; GENERAL BUILDING; OR ANY OTHER OTHER

NON-STRUCTURAL ISSUES. REFER TO THE ARCHITECTURAL CONSULTANTS DRAWINGS FOR ALL SUCH ISSUES.

THE ENGINEER HAS NOT BEEN ENGAGED TO SUPERVISE ANY WORK AND DOES NOT HAVE CONTROL OR CHARGE OF, AND SHALL NOT BE RESPONSIBLE FOR, CONSTRUCTION MEANS, METHODS. TECHNIQUES, SEQUENCES, OR PROCEDURES, FOR SAFETY PRECAUTIONS AND PROGRAMS IN CONNECTION WITH THE WORK, FOR THE ACTS OR OMISSIONS OF THE CONTRACTOR, SUBCONTRACTOR, OR ANY OTHER PERSONS PERFORMING ANY OF THE WORK, OR FOR THE FAILURE OF ANY OF THEM TO CARRY OUT THE WORK IN ACCORDANCE WITH THE CONTRACT DOCUMENTS.

1.2 SCOPE AND CLASSIFICATION:

***. PURCHASE

THIS IS A PROPOSED ALTERATION LEVEL 2, AS DEFINED IN THE EXISTING RESIDENTIAL CODE, SECTION 603.1 (MAY INCLUDE THE RECONFIGURATION OF SPACE, THE ADDITION OR ELIMINATION OF ANY DOOR OR WINDOW, THE RECONFIGURATION OR EXTENSION OF ANY SYSTEM, OR THE INSTALLATION OF ANY ADDITIONAL EQUIPMENT), AND SHALL COMPLY WITH THE PROVISIONS OF CHAPTERS 7 AND 8 OF THAT

REFER TO ARCHITECTURAL DRAWINGS

CONSTRUCTION TYPE: TYPE V-B, AS DEFINED IN TABLE 601 YEAR BUILT: 1927 (PER ZILLOW) OCCUPANCY CLASSIFICATION: DETACHED ONE-FAMILY DWELLING STRUCTURE

1.3 COMPLIANCE:

ARCHITECTURAL REVIEW:

ALL WORK SHALL BE IN COMPLIANCE WITH:

- THE 2020 RESIDENTIAL CODE OF NEW YORK STATE (2018 IRC WITH AMENDMENTS) AND ALL OTHER CODES REFERENCED THEREIN; PER R101.1, THIS CODE IS PART OF THE NEW YORK STATE UNIFORM FIRE PREVENTION AND BUILDING CODE (THE "UNIFORM CODE")
- THE 2020 EXISTING BUILDING CODE OF NEW YORK STATE (2018 IEBC WITH AMENDMENTS) • PART IV: GENERAL LEGISLATION; CHAPTER 103: BUILDING CONSTRUCTION AND CHAPTER 105:
- BUILDING ENFORCEMENT; OF THE CODE OF THE TOWN/VILLAGE OF HARRISON.
- ALL OTHER REFERENCED CODES AND ALL OTHER CODES AND REGULATIONS, LOCAL, STATE AND FEDERAL, THAT APPLY.

1.4 AUTHORITY HAVING JURISDICTION:

COMPLIANCE WITH THE INTENT AND PURPOSE OF THE CODE.

THE AUTHORITY HAVING JURISDICTION, AS DEFINED IN [NY] 103.1 OF THE BUILDING CODE, AND WHICH SHALL PROVIDE FOR ADMINISTRATION AND ENFORCEMENT OF THE UNIFORM CODE AND ENERGY CODE BY LOCAL LAW, ORDINANCE, OTHER APPROPRIATE REGULATION, OR COMBINATION THEREOF, IS THE TOWN/VILLAGE OF HARRISON.

THE DULY APPOINTED BUILDING OFFICIAL OF THE TOWN/VILLAGE OF HARRISON IS AUTHORIZED TO ENFORCE THE PROVISIONS OF THE CODE.

THE BUILDING OFFICIAL MAY ADOPT POLICIES AND PROCEDURES IN ORDER TO CLARIFY THE APPLICATION OF THE PROVISIONS OF THE CODE. SUCH POLICIES AND PROCEDURES SHALL BE IN

PER 301.4, THE ACTUAL WEIGHTS OF MATERIALS AND CONSTRUCTION SHALL BE USED FOR DETERMINING DEAD LOAD; THE FOLLOWING APPROXIMATIONS (IN PSF) ARE USED FOR THIS PROJECT:

USE	PSF
FRAMED WALL ASSEMBLY:	15
ROOF /CEILING ASSEMBLY:	20
FLOOR ASSEMBLY:	15
ALL OF THE LOADS LISTED MAY NOT APPLY TO THE CURRENT PROJECT.	

2.2 LIVE LOAD:

USE SF OTHI UNINHABITABLE SPACE WITHOUT STORAGE: 10 (<42" UNINHABITABLE ATTICS W/LIMITED STORAGE: 20 HABITABLE ATTICS & ATTICS W/FIXED STAIRS: 30	I PSF):
UNINHABITABLE ATTICS W/LIMITED STORAGE: 20	ER
	'H, 24"W)
HABITABLE ATTICS & ATTICS W/FIXED STAIRS: 30	,
TINDITABLE ATTITUDE WATER OF TAILOU.	
EXTERIOR BALCONIES & DECKS: 40	
FIRE ESCAPES: 40	
GUARDS & HANDRAILS: 200 (CONC	ENTRATED
GUARD IN-FILL COMPONENTS: 50 (HOF	RIZONTAL)
PASSENGER VEHICLE GARAGE: 50 (&2,0	00LB/20SI)
ROOMS OTHER THAN SLEEPING ROOMS: 40	,
SLEEPING ROOMS: 40	
STAIRS: 40 (& 30	0LB/4SI)
ROOF, PER 301.6 (INC. SNOW): 30	,

*SOME OF THE LOADS LISTED ABOVE MAY BE HIGHER THAN THOSE REQUIRED PER CODE. ALL OF THE LOADS LISTED MAY NOT APPLY TO THE CURRENT PROJECT.

2.3 WIND LOAD:

TAX ID: ***

WIND LOADS SHALL BE BASED ON THE ULTIMATE DESIGN WIND SPEED LISTED IN TABLE 301.2(1) AND ADJUSTED FOR HEIGHT AND EXPOSURE): 120 MPH. WIND LOADS WILL BE ALLOWED FOR IN: THE DESIGN LOAD PERFORMANCE REQUIREMENTS FOR WALL COVERINGS, ROOF COVERINGS, WINDOWS, SKYLIGHTS AND DOORS.

COMPONENT AND CLADDING LOADS WILL BE PER TABLE R301.2(2)

2.4 ALLOWABLE LIVE LOAD DEFLECTION: THE ALLOWABLE LIVE LOAD DEFLECTION OF ALL STRUCTURAL MEMBERS, SHALL BE PER TABLE R301.7

AND AS FOLLOWS:	LINO, OFFICE DE FERTADE
STRUCTURAL MEMBER	ALLOWABLE DEFLECTION
RAFTERS HAVING SLOPES GRATER THAN 3:12 WHIT FINISHED	
CEILING NOT ATTACHED TO RAFTERS	L/180
INTERIOR WALLS AND PARTITIONS	H/180
FLOORS	L/360
CEILING WITH BRITTLE FINISHES (INCLUDING PLASTER AND STUCCO)	L/360
CEILING WITH FLEXIBLE FINISHES (INCLUDING GYPSUM BOARD)	L240
ALL OTHER STRUCTURAL MEMBERS	L/240
EXTERIOR WALLS-WIND LOAD WITH PLASTER OR STUCCO FINISHES	L/360
EXTERIOR WALLS-WIND LOAD WITH OTHER BRITTLE FINISHES	H/240
EXTERIOR WALLS-WIND LOADS WITH FLEXIBLE FINISHES	H/120
LINTELS SUPPORTING MASONRY VENEER WALLS	L/600

2.5 CLIMATIC AND GEOGRAPHIC CRITERIA:

CLIMATIC AND DESIGN CRITERIA FOR THE TOWN/VILLAGE OF HARRISON ARE PER TABLE R301.2(1) AND AS FOLLOWS:

PER 2020 RESIDENTIAL CODE OF NEW YORK STATE, TABLE 301.2(1) (WIND) EXPOSURE CATEGORY: B CLIMATE ZONE:							ZONE: 4A						
GROUND SNOW LOAD	WIND SPEED MPH		SPECIAL	WINDBORNE DEBRIS ZONE	SEISMIC DESIGN CATEGORY	SUBJE	FROST LINE DEPTH	FROM		ICE BARRIER UNDERLMNT. REQUIRED	FLOOD HAZARDS	AIR FREEZING INDEX	MEAN ANNUAL TEMP
30 PSF	100-110	NO	NO	NO	С	SEVERE	3'-6"	MOD/HEAVY	15°	YES	MINIMAL	615	52.5°

3.0 CONTRACTOR'S RESPONSIBILITIES:

- PROVIDE ALL LABOR, MATERIALS AND EQUIPMENT NECESSARY FOR A COMPLETE AND FINISHED
- PROVIDE ALL NECESSARY SHORING AND BRACING FOR ALL BUILDING COMPONENTS IN ORDER TO ADEQUATELY PROTECT AGAINST ANY FAILURES.
- OBTAIN AND PAY FOR ALL REQUIRED PERMITS UNLESS OTHERWISE STIPULATED.
- PRIOR TO THE SUBMISSION OF ANY BID, AND BEFORE PROCEEDING WITH ANY WORK, VISIT THE SITE AND VERIFY AND FAMILIARIZE HIM/HERSELF WITH ALL SITE DIMENSIONS AND CONDITIONS, WITH SITE WORKING CONDITIONS, HOURS OF LEGAL OPERATION, METHODS AND ROUTES OF ACCESS, AND THE EXISTENCE AND EXTENT OF ANY OTHER RESTRICTIONS, AND BE RESPONSIBLE FOR THE VERIFICATION OF ALL SUCH CONDITIONS AND DIMENSIONS WHICH PERTAIN TO THE
- BRING ALL DISCREPANCIES IN CONDITIONS AND DIMENSIONS, BETWEEN THE APPROVED DRAWINGS AND ACTUAL FIELD CONDITIONS. TO THE IMMEDIATE ATTENTION OF THE OWNER, AND RECEIVE
- DIRECTION IN WRITING, BEFORE PROCEEDING WITH THE AFFECTED WORK. VERIFY THE AVAILABILITY, LOCATION LAYOUT AND CONDITION OF UTILITIES, INCLUDING SEWER,
- WATER, GAS AND ELECTRIC LINES, PRIOR TO THE SUBMISSION OF ANY BID. • PRIOR TO THE COMMENCEMENT OF ANY WORK, VERIFY THE CONDITION OF ALL ADJOINING
- STRUCTURES WHICH MAY BE AFFECTED, AND PROVIDE ADEQUATE PROTECTION TO ANY STRUCTURE THAT MIGHT BE OTHERWISE AFFECTED. IN THE EVENT THAT DAMAGE IS CAUSED TO ANY STRUCTURE, FINISH, OR OTHER ELEMENT,
- RESTORE SUCH ELEMENTS TO THEIR ORIGINAL CONDITION. • HAVE CONTROL OVER AND SUPERVISE, COORDINATE AND DIRECT THE WORK, INCLUDING THAT OF
- HIS SUBCONTRACTORS, AND SHALL BE SOLELY RESPONSIBLE FOR CONSTRUCTION MEANS, METHODS, TECHNIQUES, SEQUENCES AND PROCEDURES, AND FOR JOBSITE SAFETY.
- IF APPLICABLE, PROVIDE WEATHER PROTECTION, IN AN EFFECTIVE AND TIMELY MANNER, TO PROTECT THE PREMISES, PERSONNEL, MATERIALS AND INSTALLED WORK.
- BE A HOME IMPROVEMENT CONTRACTOR WITH A CURRENT LICENSE ISSUED BY THE WESTCHESTER COUNTY DEPARTMENT OF CONSUMER AFFAIRS.
- BE CERTIFIED AS A LEAD SAFE FIRM BY THE EPA PER 40 CFR 745.226. CARRY LIABILITY INSURANCE TO THE LIMITS REQUIRED BY THE AUTHORITY HAVING JURISDICTION AND ISSUE CERTIFICATE(S) OF INSURANCE AS REQUIRED BY THE HOMEOWNER AND/OR THAT
- CARRY WORKMAN'S COMPENSATION AND DISABILITY INSURANCE AS REQUIRED THE LAW AND ISSUE CERTIFICATE(S) AS REQUIRED BY THE HOMEOWNER AND/OR THE AUTHORITY HAVING

4.0 BUILDING PERMIT

NO PERSON OR ENTITY SHALL COMMENCE, PERFORM, OR CONTINUE ANY WORK THAT MUST CONFORM WITH THE UNIFORM CODE AND/OR ENERGY CODE UNLESS:

- 1. SUCH PERSON OR ENTITY HAS APPLIED TO THE TOWN/VILLAGE OF HARRISON FOR A BUILDING
- 2. THE TOWN/VILLAGE OF HARRISON HAS ISSUED A BUILDING PERMIT AUTHORIZING SUCH WORK, 3. SUCH BUILDING PERMIT HAS NOT BEEN REVOKED OR SUSPENDED, AND
- 4. SUCH BUILDING PERMIT HAS NOT EXPIRED.

THE BUILDING PERMIT IS REQUIRED TO BE VISIBLY DISPLAYED AT THE WORKSITE AND TO REMAIN

VISIBLE UNTIL THE PROJECT, AND ALL REQUIRED INSPECTIONS, HAVE BEEN COMPLETED. THE APPROVED DRAWINGS MUST BE KEPT AT THE WORKSITE AND BE AVAILABLE FOR REVIEW AT THE TIME OF ANY REQUIRED INSPECTIONS.

5.0 CONSTRUCTION INSPECTIONS:

IT SHALL BE THE DUTY OF THE HOLDER OF THE BUILDING PERMIT, OR THEIR DULY AUTHORIZED AGENT, TO NOTIFY THE BUILDING OFFICIAL WHEN WORK IS READY FOR INSPECTION:

BUILDING DEPARTMENT OF THE TOWN/VILLAGE OF HARRISON 1 HEINEMANN PLACE

HARRISON,	NY 10528
TEL:	(914) 670-3058
EMAIL:	rgermani@harrison-ny.gov
WERSITE:	www.harrison-ny.gov/huild

ANY PERSON OR ENTITY PERFORMING WORK FOR WHICH A BUILDING PERMIT HAS BEEN ISSUED SHALL KEEP SUCH WORK ACCESSIBLE AND EXPOSED UNTIL THE WORK HAS BEEN INSPECTED AND ACCEPTED BY THE AUTHORITY HAVING JURISDICTION. OR ITS AUTHORIZED AGENT. AT EACH ELEMENT OF THE CONSTRUCTION PROCESS THAT IS APPLICABLE TO THE WORK.

BUILDING PERMIT HOLDERS SHALL BE REQUIRED TO NOTIFY THE BUILDING OFFICIAL OF THE TOWN/VILLAGE OF HARRISON WHEN CONSTRUCTION WORK IS READY FOR INSPECTION. THE BUILDING OFFICIAL SHALL MAKE THE REQUIRED INSPECTIONS OR SHALL HAVE THE AUTHORITY TO ACCEPT WRITTEN REPORTS OF INSPECTION BY APPROVED AGENCIES OR INDIVIDUALS.

REQUIRED INSPECTIONS FOR THIS PROJECT MAY INCLUDE THE FOLLOWING, AS APPLICABLE, OR AS SPECIFIED IN THE CODE ENFORCEMENT PROGRAM OF THE TOWN/VILLAGE OF HARRISON:

- WORKSITE PRIOR TO THE ISSUANCE OF A PERMIT
- PLUMBING*
- ELECTRICAL* MECHANICAL
- FRAMING (SUBSEQUENT TO THE INSPECTION & APPROVAL OF PLUMBING, ELECTRICAL & MECHANICAL)
- FIRE RESISTANT CONSTRUCTION
- FIRE RESISTANT PENETRATIONS
- ENERGY CODE COMPLIANCE
- A FINAL INSPECTION AFTER ALL WORK AUTHORIZED BY THE BUILDING PERMIT HAS BEEN
- ANY OTHER INSPECTIONS AS REQUIRED BY THE TOWN/VILLAGE OF HARRISON.

A SCHEDULE OF REQUIRED INSPECTIONS IS AVAILABLE FROM THE BUILDING DEPARTMENT OF THE TOWN/VILLAGE OF HARRISON.

*THE WORK APPLICABLE TO SOME OF THE ABOVE INSPECTIONS (FOR INSTANCE PLUMBING AND ELECTRICAL) SHALL BE COMPLETED UNDER A SEPARATE PERMIT, FILED BY THE RELEVANT LICENSED

AFTER INSPECTION, THE WORK OR A PORTION THEREOF SHALL BE NOTED AS SATISFACTORY AS COMPLETED, OR THE BUILDING PERMIT HOLDER SHALL BE NOTIFIED AS TO THE MANNER IN WHICH THE WORK FAILS TO COMPLY WITH APPLICABLE CODES, INCLUDING A CITATION OF THE SPECIFIC CODE PROVISION OR PROVISIONS THAT HAVE NOT BEEN MET.

IT SHALL BE THE DUTY OF THE PERMIT HOLDER TO ASCERTAIN THE RESULTS OF REQUIRED

CONSTRUCTION WORK NOT IN COMPLIANCE WITH APPLICABLE CODES SHALL BE REQUIRED TO REMAIN EXPOSED UNTIL IT HAS BEEN BROUGHT INTO COMPLIANCE WITH THE CODES, RE-INSPECTED, AND FOUND SATISFACTORY AS COMPLETED.

STATEMENT OF DESIGN PROFESSIONAL:

4. THESE PLANS HAVE BEEN PREPARED IN CONFORMANCE WITH THE 2020 RESIDENTIAL CODE OF THE STATE OF NEW YORK.

VINCENT COAKLEY, P.E. (STAMP AFFIXED AND SIGNED)

EXCAVATION SAFETY:

THE CONTRACTOR SHALL COMPLY WITH THE TRENCHING AND EXCAVATION REQUIREMENTS OF 29 CFR 1926.651 AND 1926.652 OR COMPARABLE OSHA-APPROVED STATE PLAN REQUIREMENTS. TRENCHES 5 FEET DEEP OR GREATER REQUIRE A PROTECTIVE SYSTEM UNLESS THE EXCAVATION IS MADE ENTIRELY IN STABLE ROCK.

THE CONTRACTOR SHALL HAVE A COMPETENT PERSON INSPECT EXCAVATIONS DAILY AND AS CONDITIONS CHANGE TO ENSURE ELIMINATION OF EXCAVATION HAZARDS. A COMPETENT PERSON IS AN INDIVIDUAL WHO IS CAPABLE OF IDENTIFYING EXISTING AND PREDICTABLE HAZARDS OR WORKING CONDITIONS THAT ARE HAZARDOUS, UNSANITARY, OR DANGEROUS TO WORKERS, SOIL TYPES AND PROTECTIVE SYSTEMS REQUIRED, AND WHO IS AUTHORIZED TO TAKE PROMPT CORRECTIVE MEASURES TO ELIMINATE THESE HAZARDS AND

EXCAVATION - LOCATING UTILITIES - CALL 811: NEW YORK STATE LAW (16 NYCRR PART 753) REQUIRES ALL EXCAVATORS TO PLACE A LOCATION REQUEST WITH DIG SAFELY NEW YORK AT LEAST TWO (2) FULL WORKING DAYS, BUT NO MORE THAN 10 WORKING DAYS BEFORE BEGINNING AN EXCAVATION PROJECT IN ORDER TO ENSURE ALL UNDERGROUND UTILITY LINES ARE PROPERLY MARKED BY THEIR OWNERS.

A LOCATION REQUEST MAY BE PLACED, AND THE PROCESS OF MARKING UNDERGROUND UTILITIES MAY BE TRACKED, BY USING THE ONLINE LOCATION REQUEST PROGRAM, EXACTIX. OR, THE EXCAVATOR MAY CALL 811 TO PLACE THE LOCATION REQUEST.

- NOTIFY: NOTIFY 811 ONLINE WITH EXACT OR BY CALLING 811. WAIT: AT LEAST TWO DAYS FOR UTILITIES TO RESPOND (NOT INC. THE DAY YOU CALL). CONFIRM: CHECK ALL UTILITIES HAVE RESPONDED.
- RESPECT: ADHERE TO UTILITY MARKS AND FLAGS. DIG WITH CAUTION: DIG CAREFULLY AROUND BURIED UTILITIES.

DEMOLITION

THE CONTRACTOR SHALL: DEMOLISH AND REMOVE ALL ELEMENTS NOTED IN THE DRAWINGS FOR DEMOLITION, AND AS

REQUIRED FOR THE COMPLETION OF ALL WORK SHOWN ON THESE DRAWINGS. ALLOW NO DEBRIS TO ACCUMULATE; HAUL AWAY FROM SITE ALL DEBRIS AT CONTRACTOR'S EXPENSE; REMOVE ALL DEBRIS ON A REGULAR BASIS AND MAINTAIN JOBSITE IN A CLEAN AND TIDY CONDITION. FULLY PROTECT ALL STRUCTURES, BUILDING ELEMENTS, EQUIPMENT, APPLIANCES AND FINISHES THAT ARE TO REMAIN FROM DAMAGE CAUSED BY ANY OF THE CONTRACTOR'S ACTIVITIES.

PROTECT ALL ADJACENT AREAS, AND ALL NEIGHBORING PROPERTY, FROM DAMAGE, INJURY AND DISCOMFORT CAUSED BY DUST. PROTECT ALL PUBLIC PROPERTIES AND PREMISES FROM DAMAGE AND PREVENT ANY ACCUMULATION

OF DEBRIS, DUST OR RUBBISH IN ANY PUBLIC AREA. ASSUME FULL RESPONSIBILITY FOR ANY DAMAGE CAUSED TO EXISTING ELEMENTS AND MAKE REPAIRS REQUIRED WITHOUT ADDITIONAL COST TO THE OWNER.

CONDUCT ALL DEMOLITION OPERATIONS IN SUCH A MANNER AS TO PREVENT UNAUTHORIZED ENTRY OF ANY PERSONS AT ANY TIME; POST APPROPRIATE SIGNAGE AS REQUIRED. LOCATE ALL UTILITY AND DRAINAGE LINES PRIOR TO COMMENCEMENT OF DEMOLITION AND PROTECT ALL ACTIVE LINES AS REQUIRED. IDENTIFY CLEARLY ANY WORK THAT MAY RESULT IN THE INTERRUPTION OF ANY SERVICES WITHIN THE AREA OF WORK OR IN ANY ADJACENT SPACE OR PROPERTY AND COORDINATE SUCH INTERRUPTIONS WITH ALL INVOLVED PARTIES. NOTIFY THE OWNER, UTILITY COMPANIES, FIRE DEPARTMENT, ALARM COMPANIES, ETC.... OF ANY

CONCRETE:

REGULATIONS.

STRUCTURAL CONCRETE AND CONCRETING PRACTICES SHALL CONFORM WITH THE LATEST EDITION OF ACI 318, BUILDING CODE REQUIREMENTS FOR STRUCTURAL CONCRETE, ISSUED AND MAINTAINED BY THE AMERICAN CONCRETE INSTITUTE, AND AS NOTED BELOW.

ALL ACI REQUIREMENTS FOR HOT AND COLD WEATHERING CONCRETE MUST BE ADHERED TO.

CONCRETE SHALL HAVE A MINIMUM. COMPRESSIVE STRENGTH AT 28 DAYS AS FOLLOWS UNLESS OTHERWISE NOTED ON THE DRAWINGS: FOUNDATION WALLS, BUTTRESSES, SLAB ON GRADE: 4000 PSI, NORMAL WEIGHT **FOOTINGS AND PIERS:** 4000 PSI, NORMAL WEIGHT

WORK AFFECTING THEIR SYSTEMS AS REQUIRED BY ALL APPLICABLE CODES, RULES, AND

CONCRETE ON METAL DECK: 4000 PSI, NORMAL WEIGHT 4000 PSI, NORMAL WEIGHT ALL OTHER CONCRETE: ALL EXPOSED CONCRETE SHALL HAVE AN AIR ENTRAINING AGEN

MINIMUM CONCRETE COVER SHALL BE AS FOLLOWS, UNLESS NOTED OTHERWISE ON THE DRAWINGS:

COLUMNS: ALL CONCRETE EXPOSED TO WEATHER OR EARTH: ALL CONCRETE PLACED AGAINST EARTH:

WALLS:

REINFORCING STEEL: DETAILS SHALL BE IN ACCORDANCE WITH ACI-315, DETAILS AND DETAILING OF CONCRETE

REINFORCEMENT UNLESS OTHERWISE NOTED ON THE DRAWINGS. ALL REINFORCING BARS SHALL CONFORM TO ASTM A615, GRADE 60 UNLESS REQUIRED TO BE WELDED AS SHOWN ON PLANS.

ALL REINFORCING BARS REQUIRED TO BE WELDED SHALL CONFORM TO ASTM A706, GRADE 50. WELDED WIRE FABRIC SHALL CONFORM TO ASTM A185. SUPPORT WIRE FABRIC WITH CHAIRS OR LIFTS DURING CONCRETE PLACEMENT TO INSURE PROPER

ALL REINFORCEMENT SHALL BE SECURELY HELD IN PLACE WHILE PLACING CONCRETE. IF REQUIRED, ADDITIONAL BARS OR STIRRUPS SHALL BE PROVIDED BY THE CONTRACTOR TO FURNISH SUPPORT FOR ALL BARS. REINFORCEMENT SHALL BE SECURED IN THE PROPER LOCATION IN THE FORMS WITH TIE WIRE OR OTHER BAR SUPPORT SYSTEM TO PREVENT DISPLACEMENT DURING THE CONCRETE

PLACEMENT OPERATION. WHERE NOT SPECIFICALLY INDICATED ON THE DRAWINGS, SPLICING & EMBEDMENTS SHALL BE IN ACCORDANCE TABLE R608.5.4(1) LAP SPLICE AND TENSION DEVELOPMENT LENGTHS.

STRUCTURAL STEEL:

8. Steel Pire:

9. PLATES & BARS (UP TC

10.PLATES & BARS (> 8"):

STRUCTURAL STEEL MEMBERS STRUCTURAL STEEL SHAPES SHALL CONFORM TO THE FOLLOWING SPECIFICATIONS:

1. W-SHAPES: ASTM A992 $(F_Y = 50-65 \text{ KSI. } F_U = 65 \text{ KS})$ ASTM A36 (F_Y = 36 KSI, = 58-80 KSI) 2. M-, S- & HP-SHAPES: 3. CHANNELS (C & MC): ASTM A36 I, F, 58-80 KSI) = 36 | F_U 8-80 KSI) 4. ANGLES (L): SAME ! THE M W-SI YES 5. STRUCTURAL TEES: 6. RECTANGULAR & SQUARE HSS: () RA. B (FY = 46 KS 30 KSI) 7. ROUND HSS: $(F_Y = 42 \text{ KSI}, F_U = 58 \text{ KSI})$

 $\frac{1}{3}$ G DE $\frac{1}{2}$ (F_Y = 35 KSI, F_U = 60 KSI)

 $(F_Y = 36 \text{ KSI}, F_U = 58-80 \text{ KSI})$

ASIM A36 $(F_Y = 32 \text{ KSI}, F_{IJ} = 58 \text{ SI})$

OR AWS A5.18, (GMAW PROCESS)

OR AWS A5.1 (SMAW PROCESS)

FASTENING PRODUCTS: FASTENING PRODUCTS SHALL CONFORM TO THE FOLLOWING SPL DIF OF TON

1. H.S. A325 BOLTS; >1"-1½" INC.: AST 1 A325 (F_U = 105 KSI) H.S. A325 BOLTS; 1/2" - 1" INC.: 2. H.S. A490 BOLTS; 1/2"\- 11/2" INC.: ASTM A490 (F₁ = 10 K 3. HEAVY-DUTY HEX NUTS; 1/4" - 4": ASTM 4563 4. HARDENED WASHERS;\1/4" - 4": 45 M F .36 5. H.S. A490 BOLTS: 1/2" - 11/2" INC.: $F_{1} = 100 \text{ (F}_{1} = 100 \text{ KSI)}$ 6. THREADED ROD: $_{\circ}$ STM A36 (F_Y = 36 KSI, F_U = 58-80 KSI) ANCHOR ROD: ASTM F1554, GR. 36 ($F_Y = 36$ KSI, $F_U = 58-80$ KSI) PER TABLE D1.1 TABLE 3.1 (MINIMUM F_{II} = 70KSI) 8. FILLER (WELD) MATERIAL: 9. WELDING ELECTRODES: E70XX RODS TO AWS A5.20 (FCA PROCESS)

WOOD FRAMING:

STRUCTURAL FLOOR MEMBERS SHALL CONFORM TO THE APPLICABLE PROVISIONS OF SECTION R502. ALL FLOOR FRAMING, INCLUDING JOISTS, LEDGERS, HEADERS AND BLOCKING, IS TO BE 2X DOUGLAS FIR-LARCH NO. 2 OR HEM-FIR NO. 2, FB=850 PSI, 1.4E OR BETTER. FLOOR FRAMING IS TO BE AT 16" (MAXIMUM) ON CENTER, OR AS OTHERWISE NOTED IN THE

DRAWINGS FLOOR SHEATHING SHALL BE AVANTECH T&G SUBFLOOR FASTENED WITH 8D COMMON NAILS @ 6" O.C. AND AVANTECH SUBFLOOR ADHESIVE PER MANUFACTURERS INSTRUCTIONS AND SHALL

CONFORM OF SECTION 502 OF THE RESIDENTIAL CODE.

WALL FRAMING:

LOAD BEARING WALLS SHALL CONFORM TO THE APPLICABLE PROVISIONS OF SECTION R602. ALL LOAD BEARING WOOD FRAMED PARTITIONS INCLUDING STUDS. TOP AND BOTTOM PLATE AND BLOCKING, IS TO BE 2X DOUGLAS FIR-LARCH NO. 2 OR HEM-FIR NO. 2, FB=850 PSI, 1.4E OR BETTER. WALL FRAMING IS TO BE AT 16" (MAXIMUM) ON CENTER, OR AS OTHERWISE NOTED IN THE DRAWINGS. AVOID NOTCHING (SEE CUTTING AND NOTCHING BELOW). PROVIDE SISTER STUDS AS REQUIRED.

BEARING STUDS NOT SUPPORTING FLOORS AND NONBEARING STUDS SHALL BE PERMITTED TO BE UTILITY GRADE LUMBER, PROVIDED THAT THE STUDS ARE SPACED AT 16" O.C. MINIMUM.

BOTTOM (SOLE) PLATE:

STUDS SHALL HAVE FULL BEARING ON A NOMINAL 2-BY (51 MM) OR LARGER PLATE OR SILL HAVING A WIDTH NOT LESS THAN TO THE WIDTH OF THE STUDS.

WOOD STUD WALLS SHALL BE CAPPED WITH A DOUBLE TOP PLATE INSTALLED TO PROVIDE OVERLAPPING AT CORNERS AND INTERSECTIONS WITH BEARING PARTITIONS. END JOINTS IN TOP PLATES SHALL BE OFFSET NOT LESS THAN 24 INCHES (610 MM). JOINTS IN PLATES NEED NOT OCCUR OVER STUDS. PLATES SHALL BE NOT LESS THAN 2-INCHES (51 MM) NOMINAL THICKNESS AND HAVE A WIDTH NOT LESS THAN THE WIDTH OF THE STUDS.

WALL SHEATHING SHALL BE MINIMUM 1/2" WOOD STRUCTURAL PANEL ,ZIP SYSTEM, PER MANUFACTURERS INSTRUCTIONS HARDIE PLANK LAP SIDING AND SHALL CONFORM OF SECTION 602 OF THE RESIDENTIAL CODE.

ROOF-CEILING CONSTRUCTION:

ROOF FRAMING SHALL CONFORM TO THE APPLICABLE PROVISIONS OF SECTION R802. ALL ROOF FRAMING, INCLUDING RAFTERS, COLLAR TIES, RAFTER TIES AND CEILING JOISTS, IS TO BE 2X . DOUGLAS FIR-LARCH NO. 2 OR HEM-FIR NO. 2. FB=850 PSI. 1.4E. OR BETTER. ROOF FRAMING IS TO BE AT 16" (MAXIMUM) ON CENTER, OR AS OTHERWISE NOTED IN THE DRAWINGS. ROOF SHEATHING SHALL BE ZIP SYSTEM 5/8" SHEATHING AND SHALL CONFORM PER SECTION 803 OF THE RESIDENTIAL CODE.

CUTTING, DRILLING AND NOTCHING FOR WIRES AND PIPES:


WOOD-FRAMED STRUCTURAL MEMBERS SHALL NOT BE DRILLED, NOTCHED OR ALTERED IN ANY MANNER EXCEPT AS PROVIDED IN SECTIONS R502.8, R602.6, R802.7 AND R802.7.1 OF THE RESIDENTIAL

TRUSS TYPE CONSTRUCTION

WHERE NOT SPECIFICALLY INDICATED ON THE DRAWINGS, SPLICING & EMBEDMENTS SHALL BE IN ACCORDANCE TABLE R608.5.4(1) LAP SPLICE AND TENSION DEVELOPMENT LENGTHS THE UTILIZATION OF TRUSS-TYPE CONSTRUCTION, PRE-ENGINEERED WOOD CONSTRUCTION AND/OR

TIMBER CONSTRUCTION IN RESIDENTIAL STRUCTURES IS SUBJECT TO THE REQUIREMENTS OF TITLE 19 OF THE NEW YORK CODES, RULES AND REGULATIONS (NYCRR), PART 1265: ANY PERSON UTILIZING TRUSS TYPE, PRE-ENGINEERED WOOD OR TIMBER CONSTRUCTION FOR THE ERECTION OF ANY NEW RESIDENTIAL STRUCTURE, FOR ANY ADDITION TO AN EXISTING RESIDENTIAL STRUCTURE. OR FOR ANY REHABILITATION OF AN EXISTING RESIDENTIAL STRUCTURE, SHALL, UPON APPLICATION FOR A BUILDING PERMIT WITH THE LOCAL GOVERNMENT HAVING JURISDICTION. INCLUDE ON THE PERMIT APPLICATION THAT TRUSS TYPE, PRE-ENGINEERED WOOD OR TIMBER CONSTRUCTION IS BEING UTILIZED, AND THAT THE PROPERTY OWNER OR THE PROPERTY OWNER'S REPRESENTATIVE SHALL COMPLETE A FORM PRESCRIBED BY THE STATE FIRE PREVENTION AND BUILDING CODE COUNCIL (HEREINAFTER REFERRED TO AS THE CODE COUNCIL) DESIGNATING THE STRUCTURE AS TRUSS TYPE, PRE-ENGINEERED WOOD OR TIMBER CONSTRUCTION AND FILE SUCH FORM WITH THE APPLICATION FOR A BUILDING PERMIT.

REQUIRED SIGN:

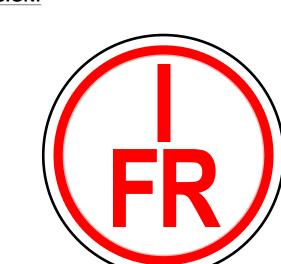

HOWEVER:

S-02.4

S-02.5

S-02.6.0

S-02.6.1

WORK AREA 4

WORK AREA 5

WORK AREA 6

WORK AREA 7

WORK AREA 8

WORK AREA 9

WORK AREA 6

AS A CONDITION OF THE RECEIPT OF A CERTIFICATE OF OCCUPANCY, A SIGN OR SYMBOL DESIGNED AND APPROVED BY THE CODE COUNCIL SHALL BE AFFIXED TO THE ELECTRIC BOX ATTACHED TO THE EXTERIOR OF THE RESIDENTIAL STRUCTURE; PR IDED.

HEAFFIXING THE SIGN OR SY OL TO THE EL IC BOX WOULD OBSCURE ANY METER ON THE ELECTRIC BOY OR IF 1 UTILY PROVIDING E STRIC SERVICE TO THE RESIDENTIAL STRUCTURE DOES NOT ALL THE SIN O. YMBOL TO BE A IXED TO THE ELECTRIC BOX, THE SIGN OR VALL STANTO E EXTERIOR WAS OF THE RESIDENTIAL STRUCTURE AT A POINT MEDIA). (AL CL THE FO BOX, AND:

VO ELEC' C BUIS AT INCHED TO THE EXTERIOR OF THE RESIDENTIAL STRUCTURE OR IF, IN THE "ION O" HE AUTHORITY HAVING JURISDICTION, THE ELECTRIC BOX ATTACHED TO THE THE BUILDING IS NOT LOCATED IN TO SE LIKELY TO BE SEEN BY FIREFIGHTERS OR OTHER FIRST RESPONDERS RESPONDED IN TO FIRE OTHER EMERGENCY AT THE RESIDENTIAL STRUCTURE, THE SIGN OF YMBC'. SH. L. BE FFIXED TO THE EXTERIOR OF THE STRUCTURE IN A LOCATION APPROVEL B' THE BUIL VINC OFFICIAL OF THE TOWN/VILLAGE OF HARRISON AS A FIF _ C. C. HEF EIL FRY ENCY AT THE RESIDENTIAL STRUCTURE.

E_	DRA VING Ic	DATE	(CURRENT) REVISIO
01	COVER SHEET	01.25.2024	01.17.2025
			A
01.1	BASEMENT	01.25.2024	09.09.2024
01.2	FIRST FLOOR PLAN	01.25.2024	09.09.2024
			~~~~
01.3	SECOND FLOOR PLAN	01.25.2024	01.17.2025
			A
02.1	WORK AREA 1	01.25.2024	09.09.2024
			~~~~
02.2	WORK AREA 2	01.25.2024	01.17.2025
			A
02.3	WORK AREA 3	01.25.2024	09.09.2024

01.25.2024

01.25.2024

01.25.2024

09.09.2024

01.25.2024

01.25.2024

09.09.2024

LITE OF THUSTURAL DRAWINGS

PROPERTY ADDRESS:

E S

<u>0</u>

_ a **_**

တာ င္ရ စ

ш

🔾 💍 👸 ပ

PURCHASE, NY 10577

(TOWN/VILLAGE OF HARRISON)

EMAIL: ***

S-B-L (TAX ID):

02.05.2024 FOR REVIEW 04.22.2024 **DESIGN CHANGE** 05.01.2024 DESIGN CHANGE DESIGN CHANGE 05.30.2024 09.09.2024 DESIGN CHANGE $\sim\sim$

01.17.2025 **DESIGN CHANGE**

PROJECT NAME:

STRUCTURAL ALTERATION

DRAWING NAME: **COVER SHEET**

PRAWING NUMBER:

01.25.2024 **AS NOTED**

THIS DRAWING IS VALID FOR CONSTRUCTION IF (AND ONLY IF) A PERMIT IS ISSUED, BASED ON THIS DRAWING, BY THE TOWN/VILLAGE OF HARRISON.

DO NOT SCALE DRAWINGS | THIS DRAWING IS SCALED TO PRINT ON AN ARCH D (24" X 36") SHEET

(CLIDDENT) DEVISION

09.09.2024

09.09.2024


09.09.2024

09.09.2024

09.09.2024


09.09.2024

09.09.2024

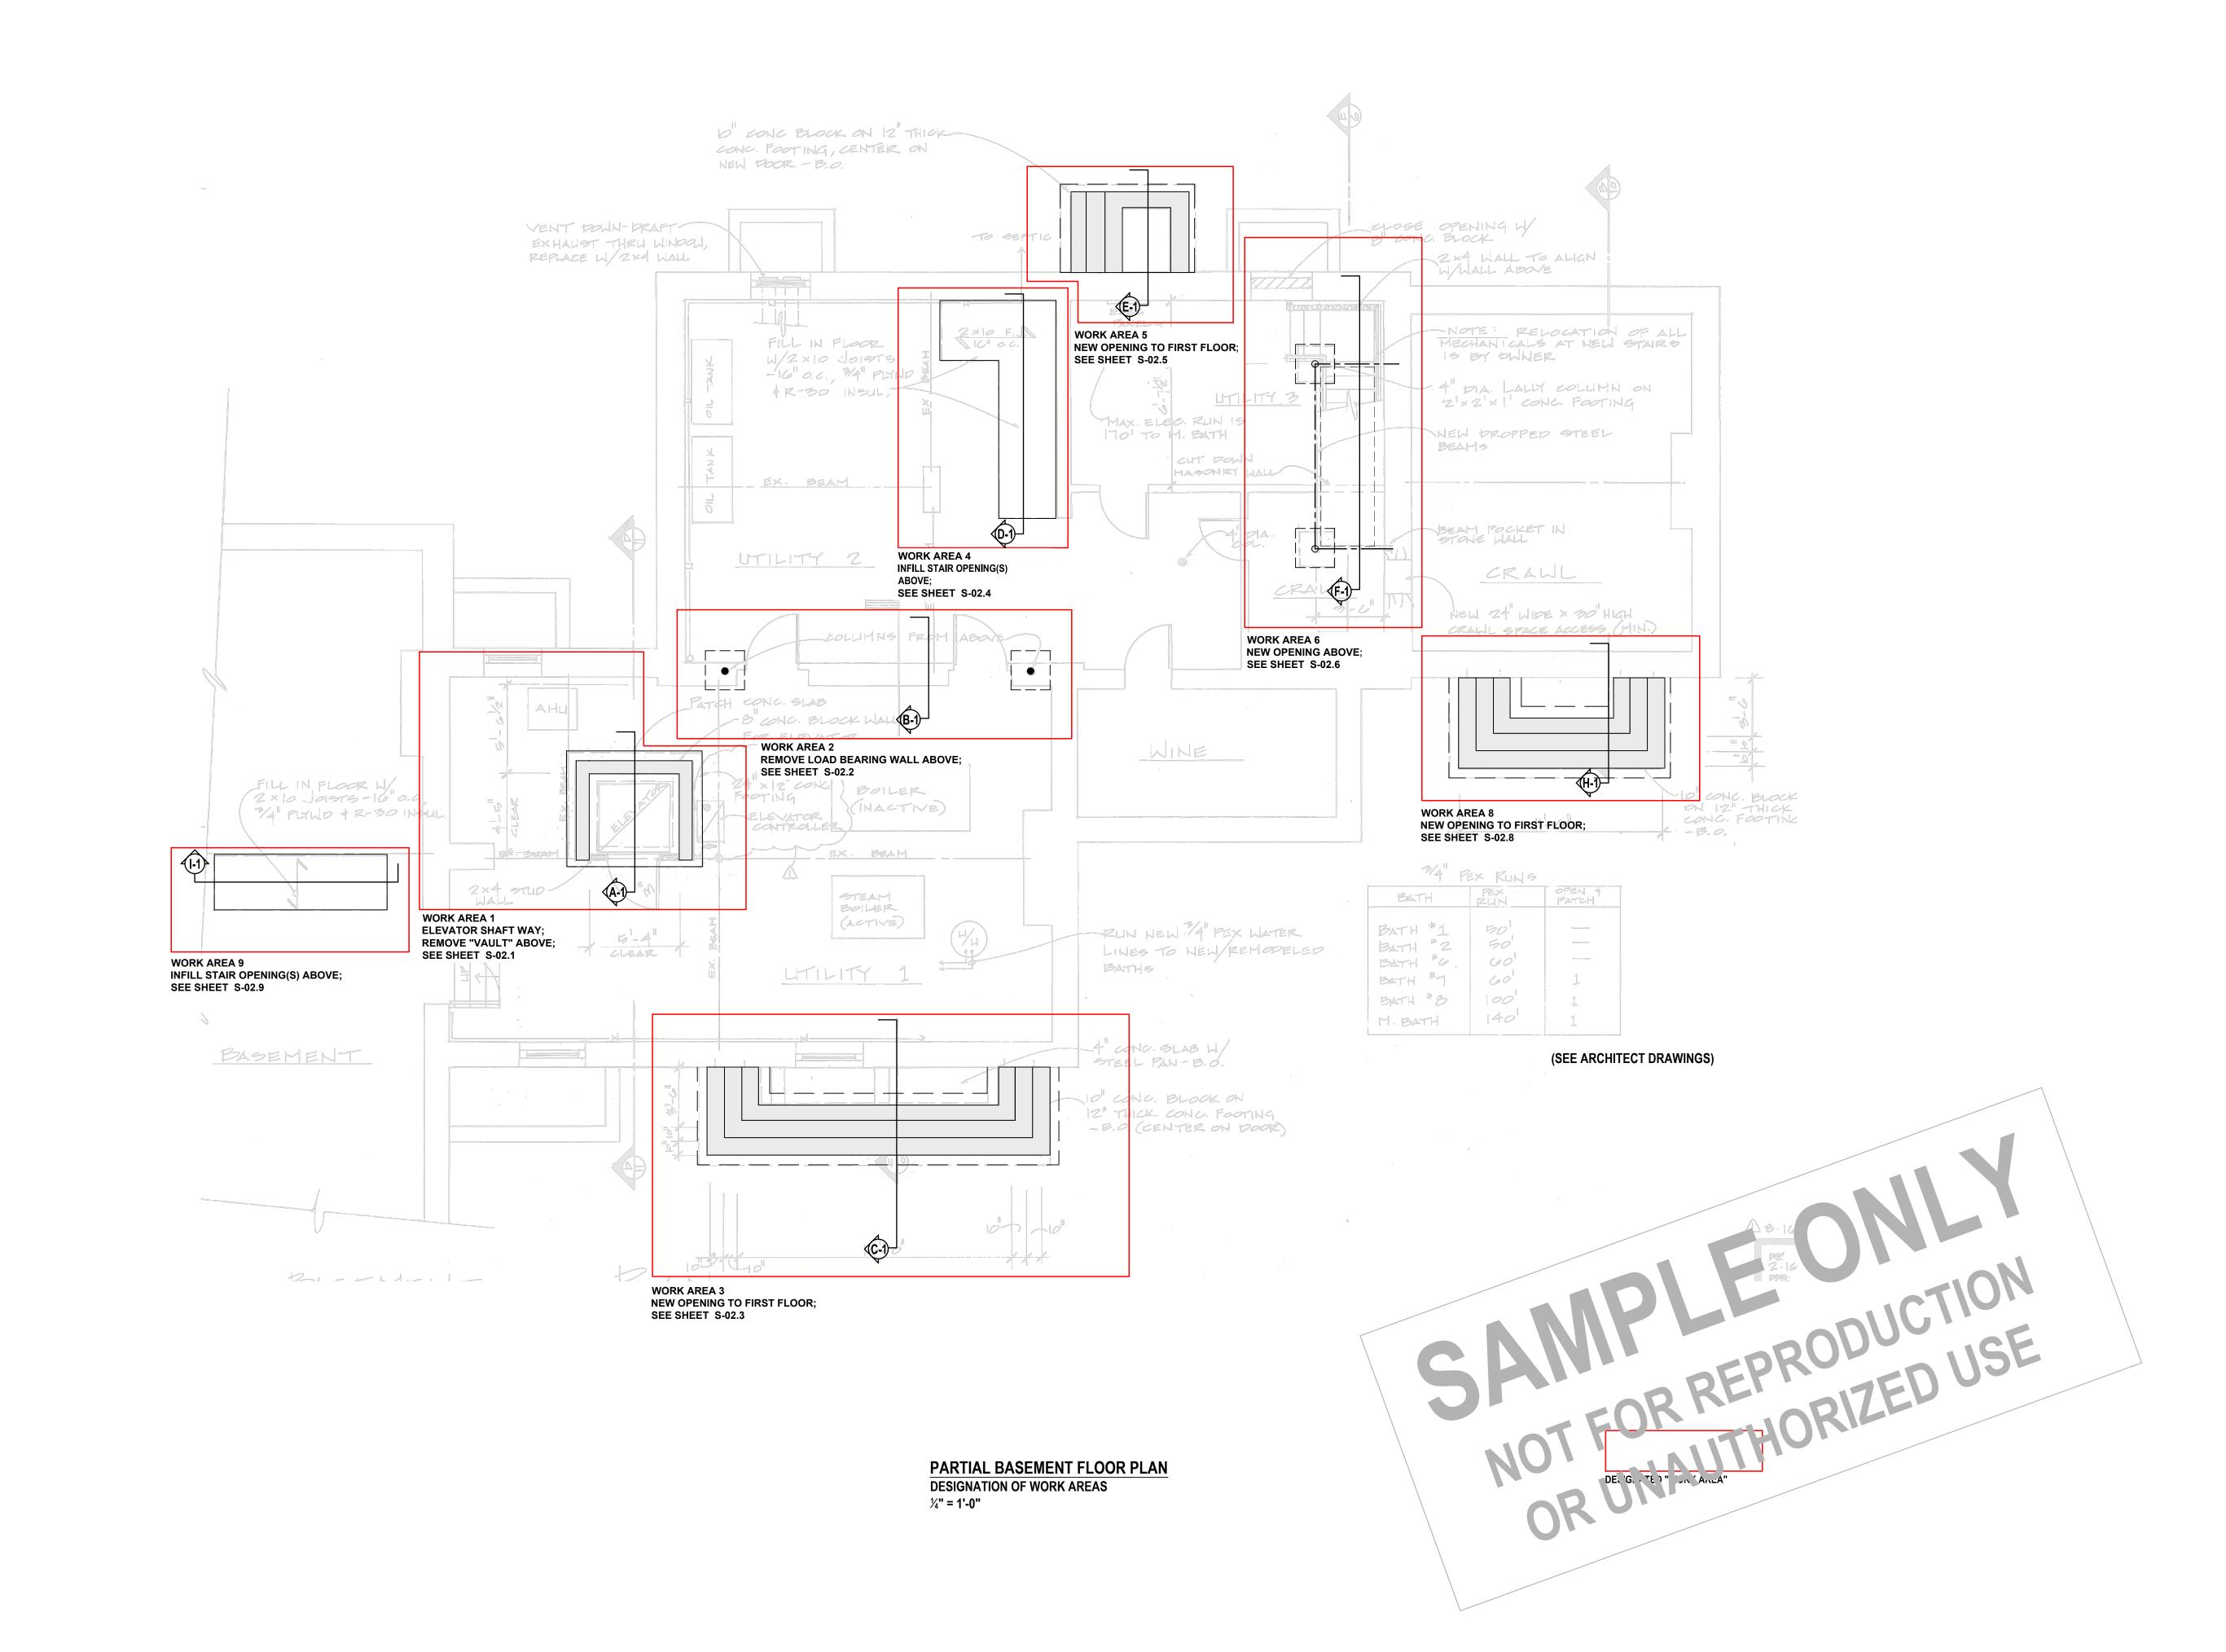

THIS DRAWING IS AS A SAMPLE ONLY
** PERSONAL (CLIENT) INFORMATION WITHHELD

ARCHITECTURAL CONSULTANTS gin pplicat ED mit Ap lianc Oliv Design -Code C PROPERTY ADDRESS: **PURCHASE, NY 10577** (TOWN/VILLAGE OF HARRISON) S-B-L (TAX ID): TEL: *** EMAIL: *** DATE: ISSUE: 02.05.2024 FOR REVIEW **DESIGN CHANGE** 04.22.2024 05.01.2024 DESIGN CHANGE 05.30.2024 DESIGN CHANGE 09.09.2024 DESIGN CHANGE PROJECT NAME:
STRUCTURAL ALTERATION DRAWING NAME: **BASEMENT PLAN WORK AREAS** DRAWING NUMBER: S-01.1 01.25.2024 SCALE: AS NOTED THIS DRAWING IS VALID FOR CONSTRUCTION IF (AND ONLY IF) A PERMIT IS ISSUED, BASED ON THIS DRAWING, BY THE TOWN/VILLAGE OF HARRISON.

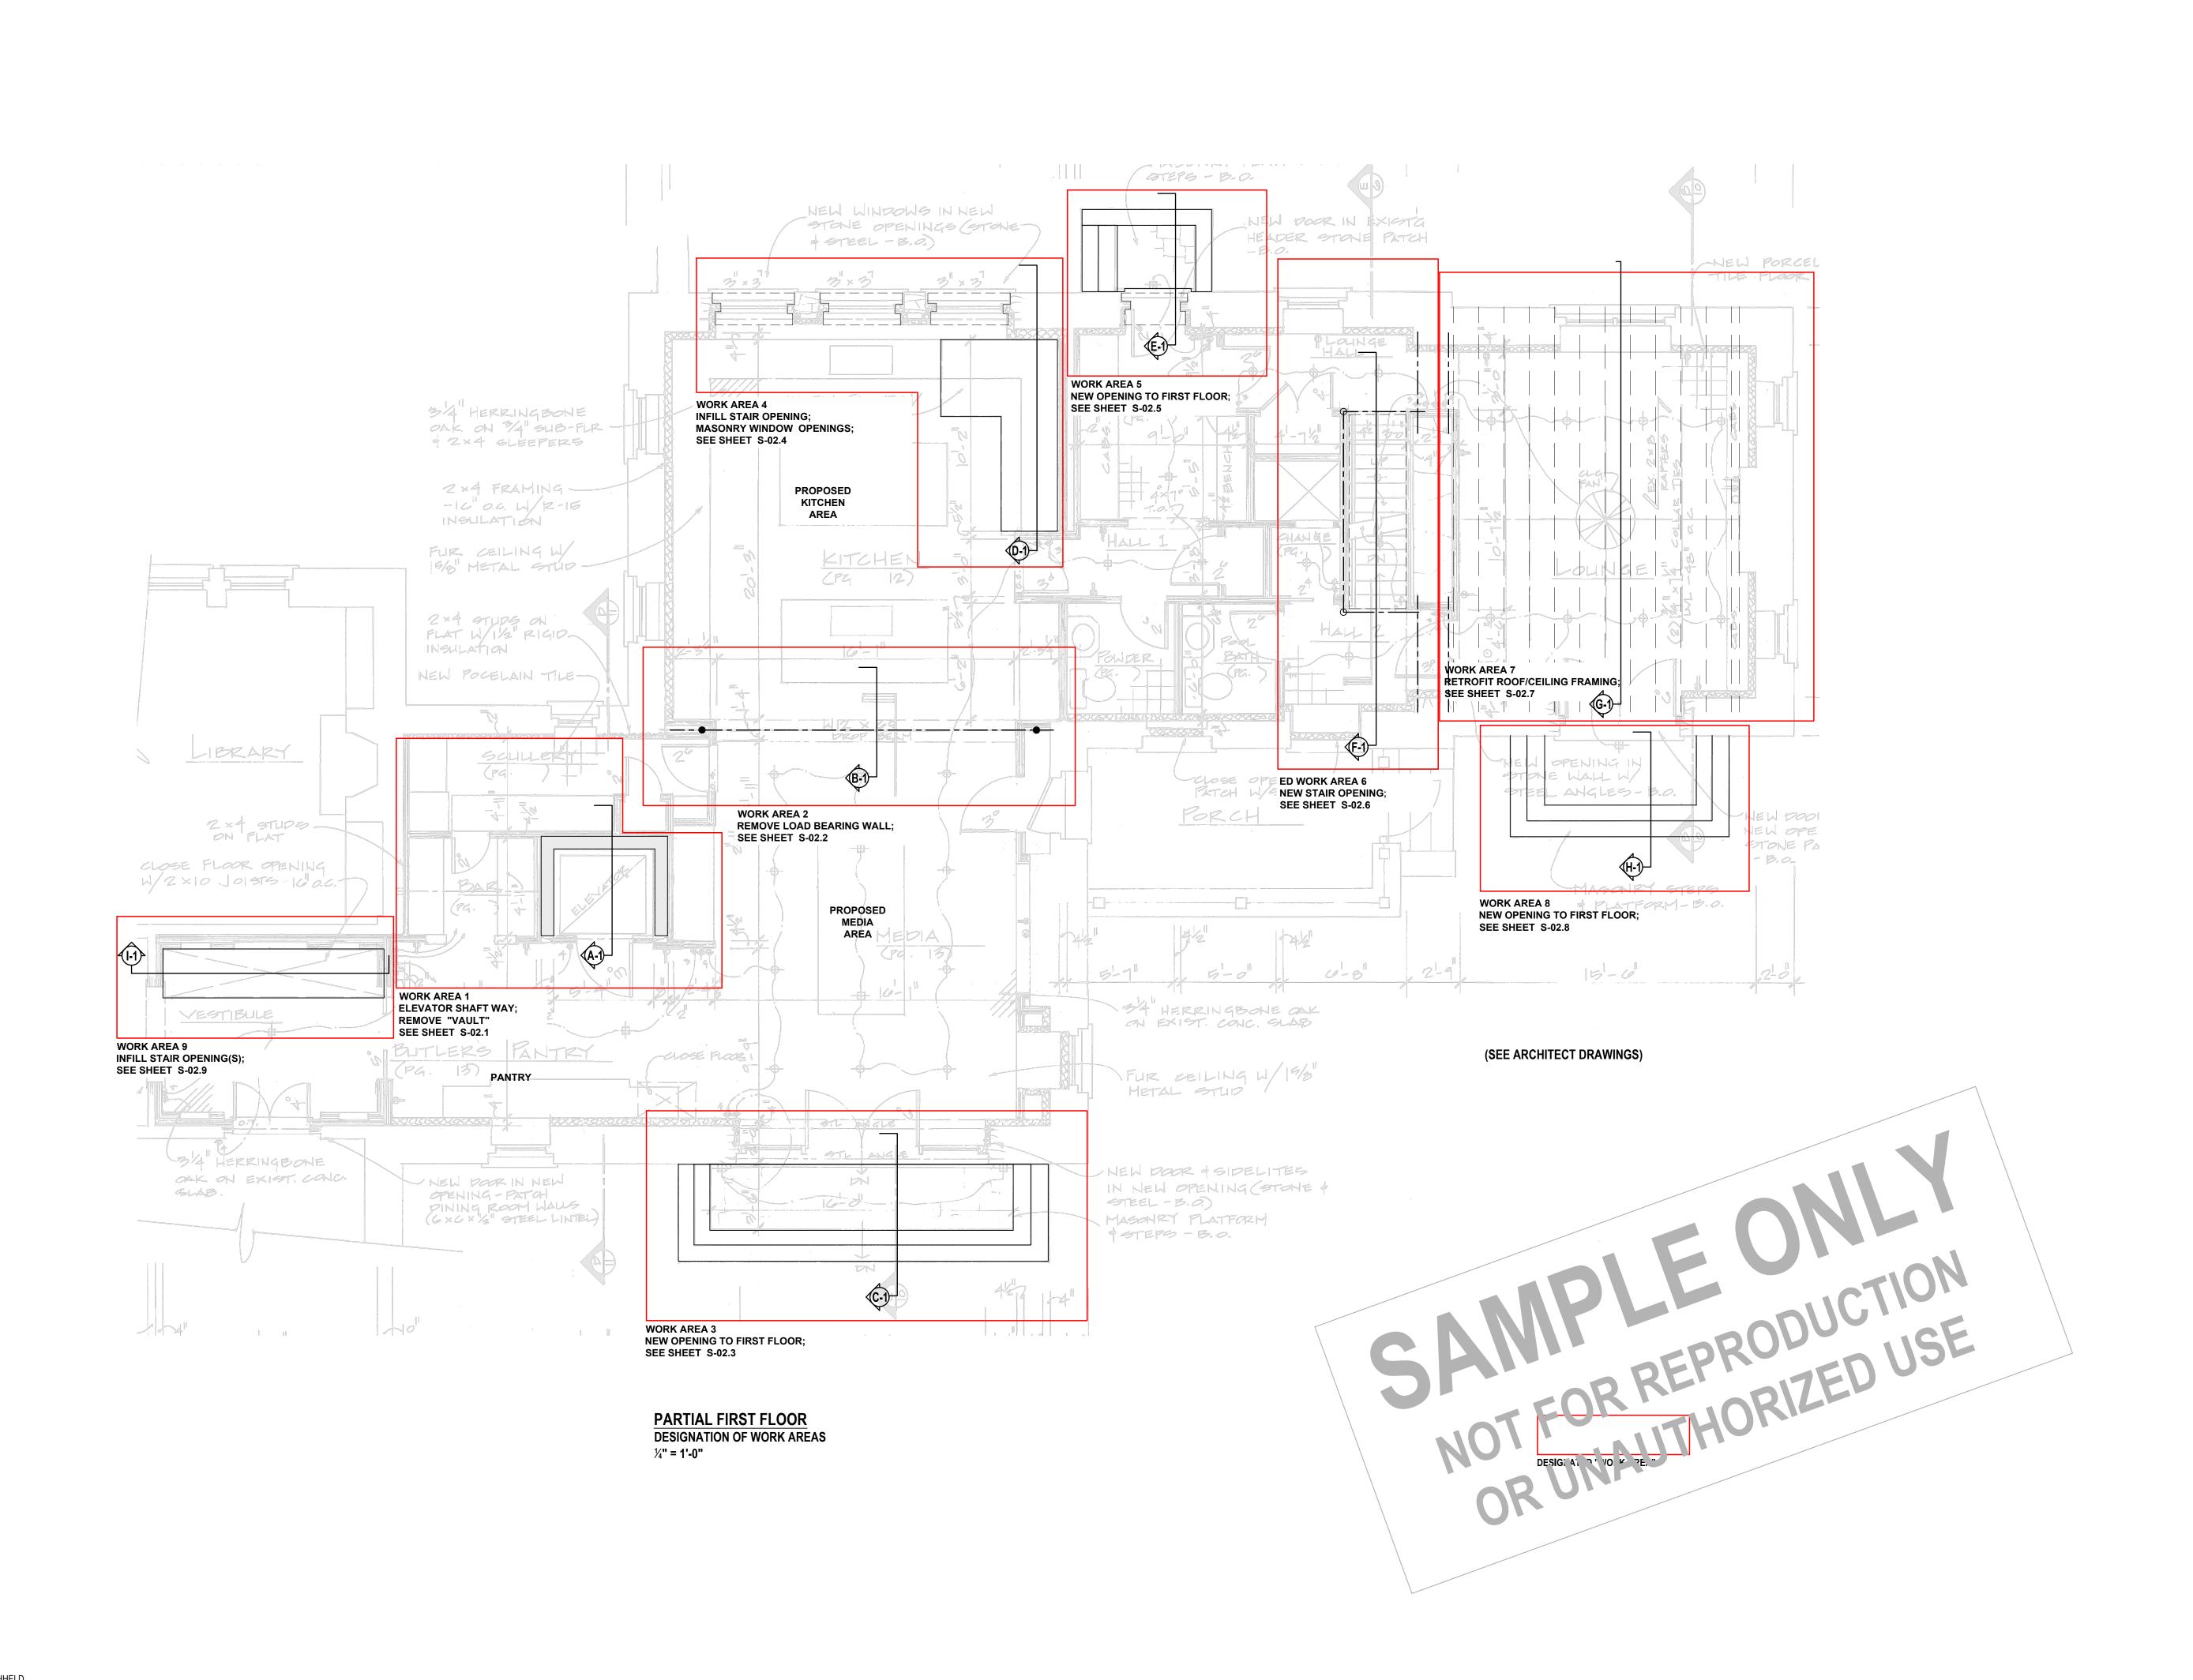

ARCHITECTURAL mit Ag Oliv Design PROPERTY ADDRESS: **PURCHASE, NY 10577** (TOWN/VILLAGE OF HARRISON) S-B-L (TAX ID): TEL: *** EMAIL: ***

DATE: ISSUE: 02.05.2024 FOR REVIEW **DESIGN CHANGE** 04.22.2024 05.01.2024 DESIGN CHANGE 05.30.2024 DESIGN CHANGE 09.09.2024 DESIGN CHANGE

PROJECT NAME:
STRUCTURAL ALTERATION


DRAWING NAME: FIRST FLOOR **WORK AREAS**

DRAWING NUMBER: S-01.2

01.25.2024

SCALE: AS NOTED

THIS DRAWING IS VALID FOR CONSTRUCTION IF (AND ONLY IF) A PERMIT IS ISSUED, BASED ON THIS DRAWING, BY THE TOWN/VILLAGE OF HARRISON.

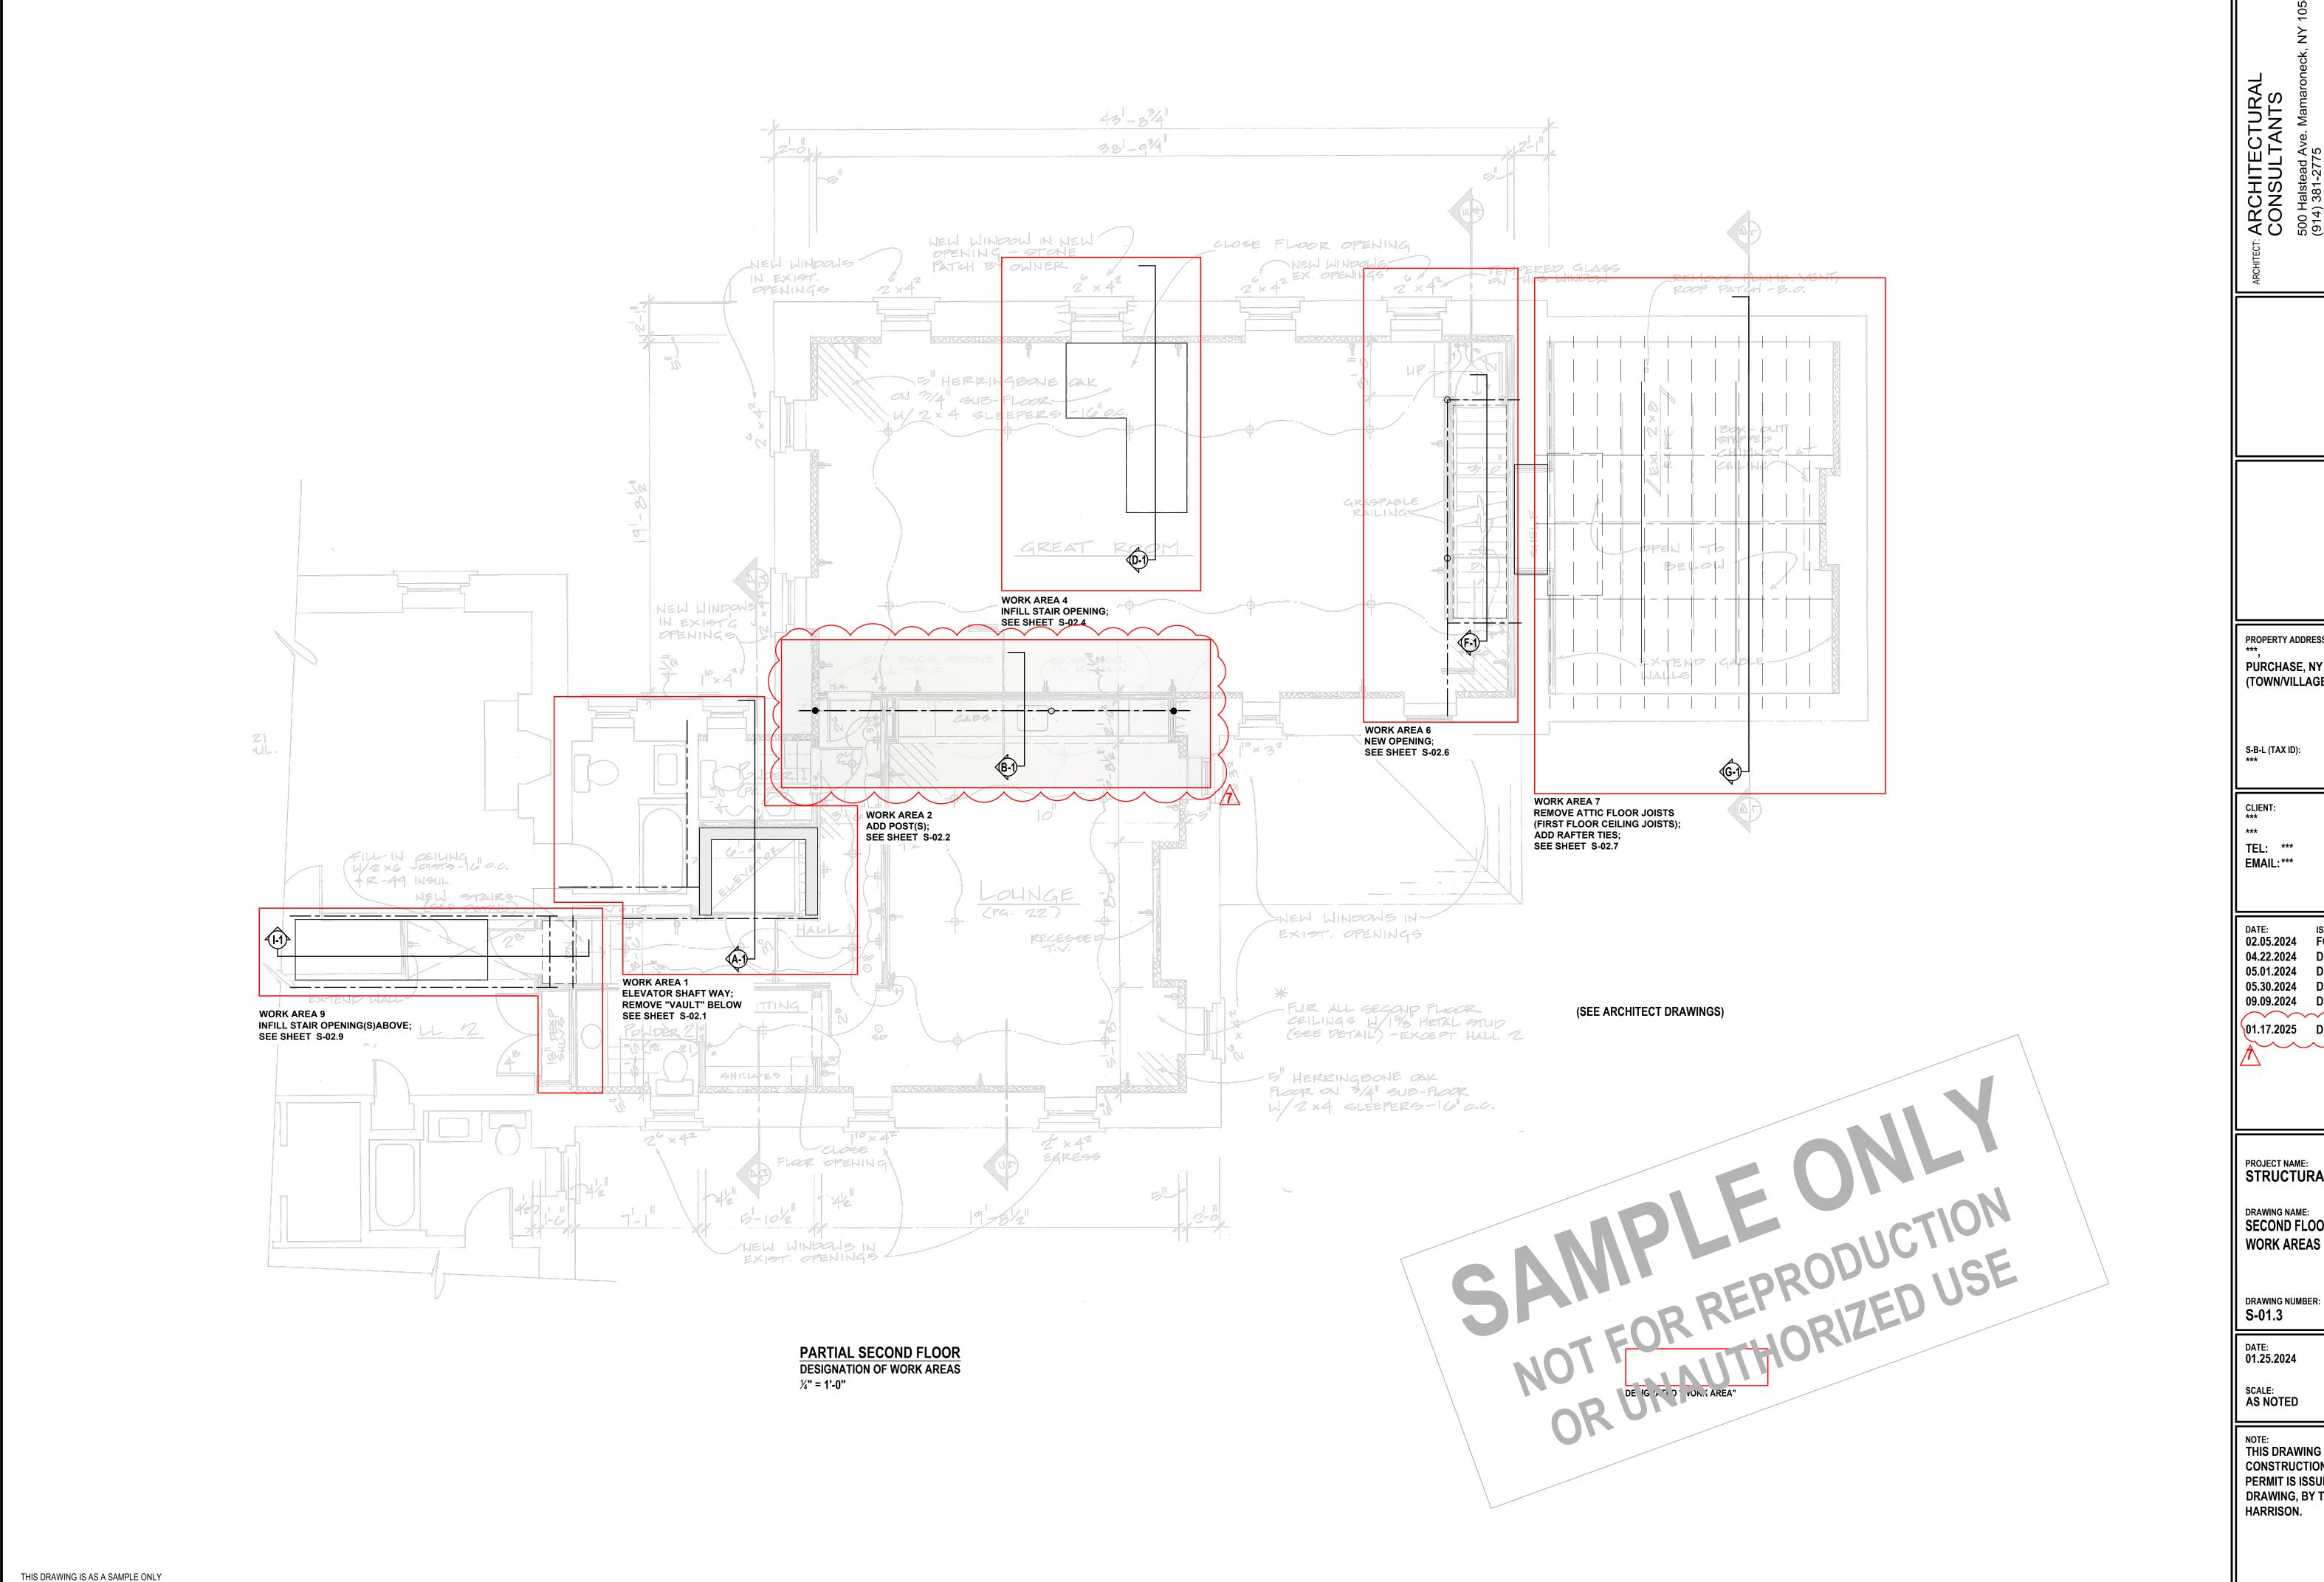

** PERSONAL (CLIENT) INFORMATION WITHHELD


Oliv Design PROPERTY ADDRESS: **PURCHASE, NY 10577** (TOWN/VILLAGE OF HARRISON) DATE: ISSUE: 02.05.2024 FOR REVIEW **DESIGN CHANGE** 05.01.2024 DESIGN CHANGE 05.30.2024 DESIGN CHANGE 09.09.2024 DESIGN CHANGE 01.17.2025 DESIGN CHANGE SECOND FLOOR


PROJECT NAME:
STRUCTURAL ALTERATION

WORK AREAS


THIS DRAWING IS VALID FOR

CONSTRUCTION IF (AND ONLY IF) A PERMIT IS ISSUED, BASED ON THIS DRAWING, BY THE TOWN/VILLAGE OF

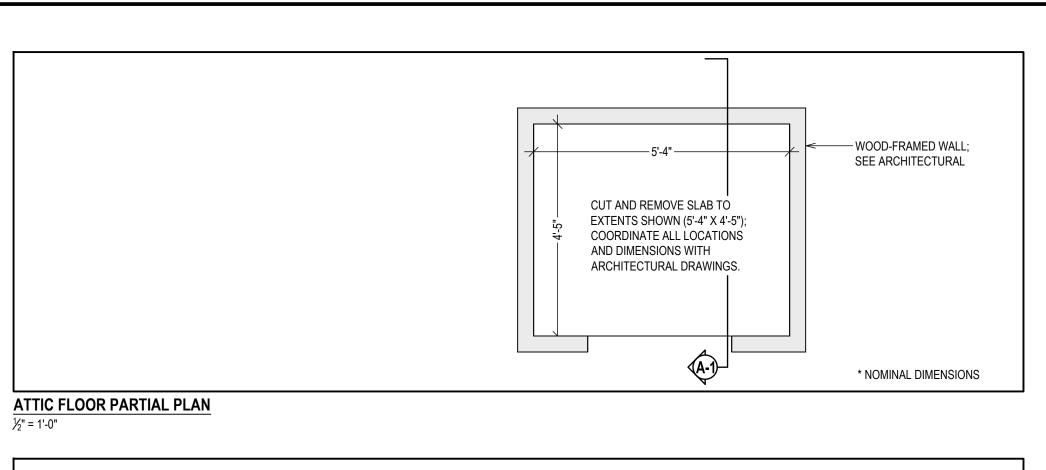


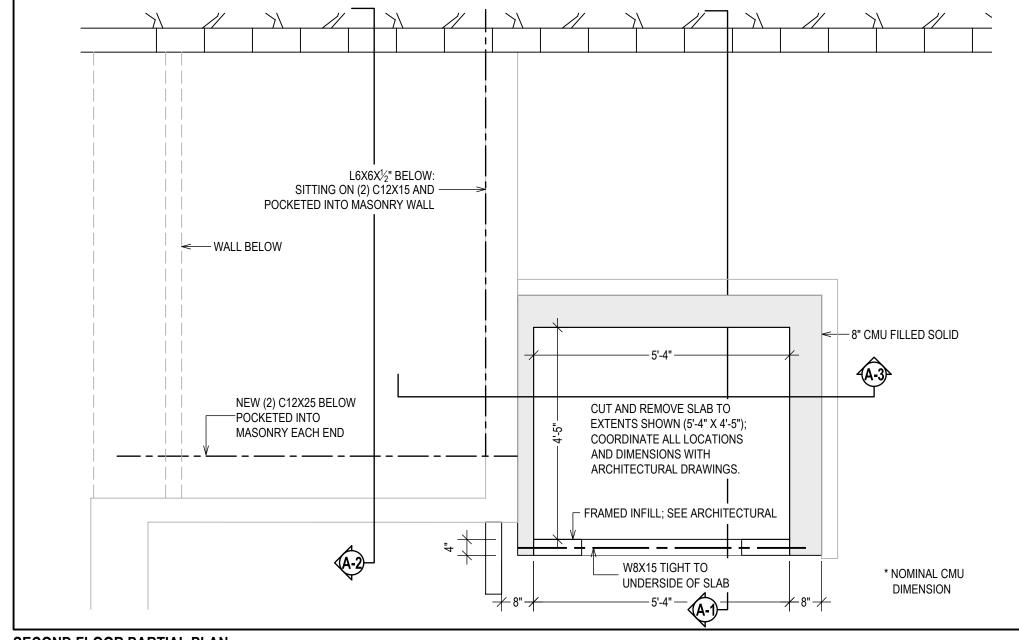


SECOND FLOOR PARTIAL PLAN

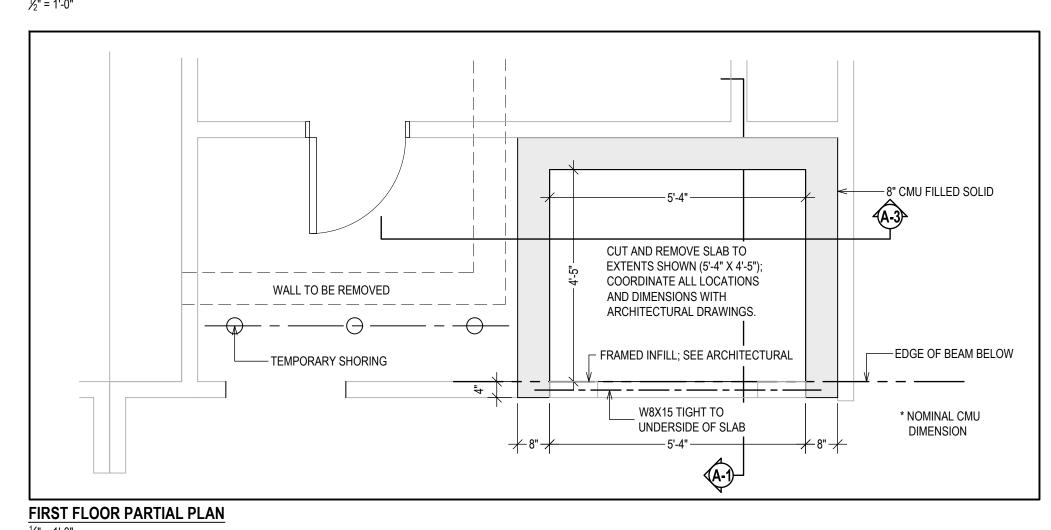

LINE OF FOOTING BELOW CUT AND REMOVE SLAB TO EXTENTS SHOWN (5'-4" X 4'-5"); COORDINATE ALL LOCATIONS AND DIMENSIONS WITH ARCHITECTURAL DRAWINGS. ----EDGE OF BEAM ABOVE - FRAMED INFILL; SEE ARCHITECTURAL * NOMINAL CMU DIMENSION **BASEMENT PARTIAL PLAN**

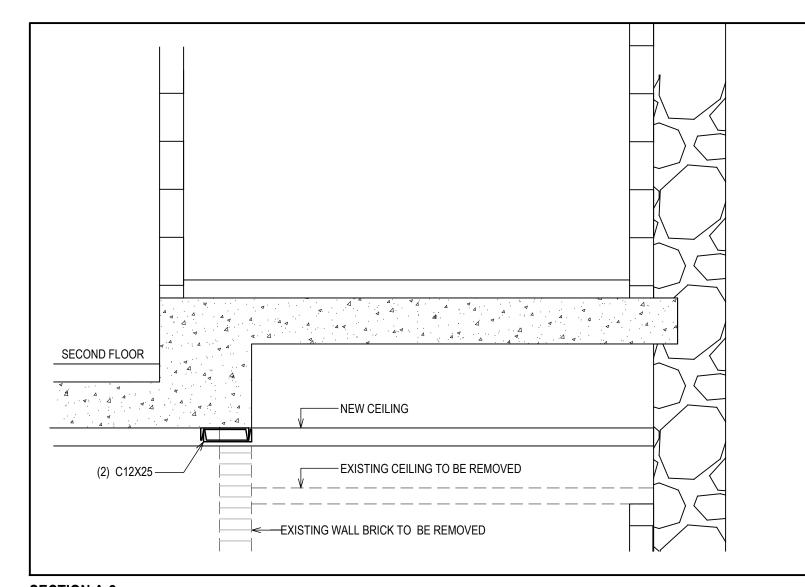



SECTION A-2

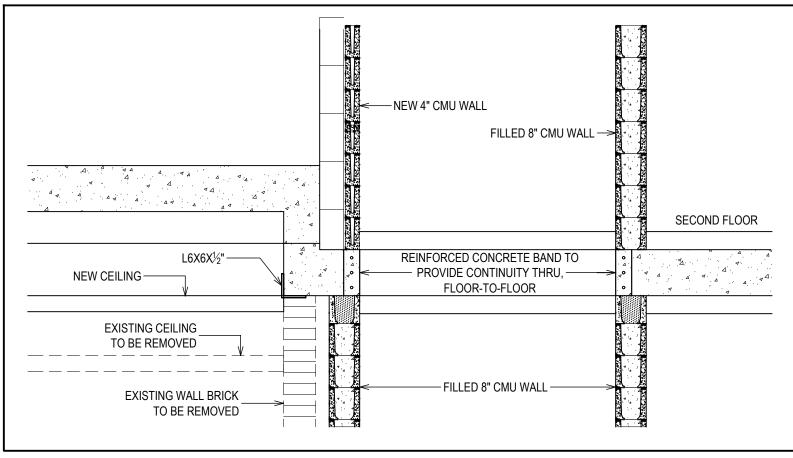

SECTION A-3


STAGING

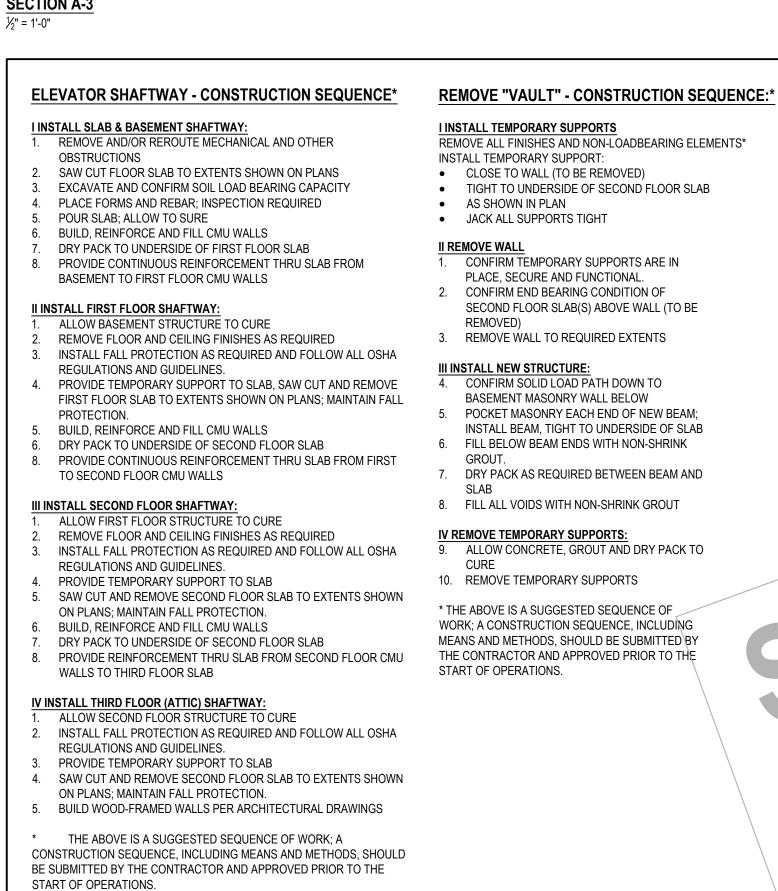


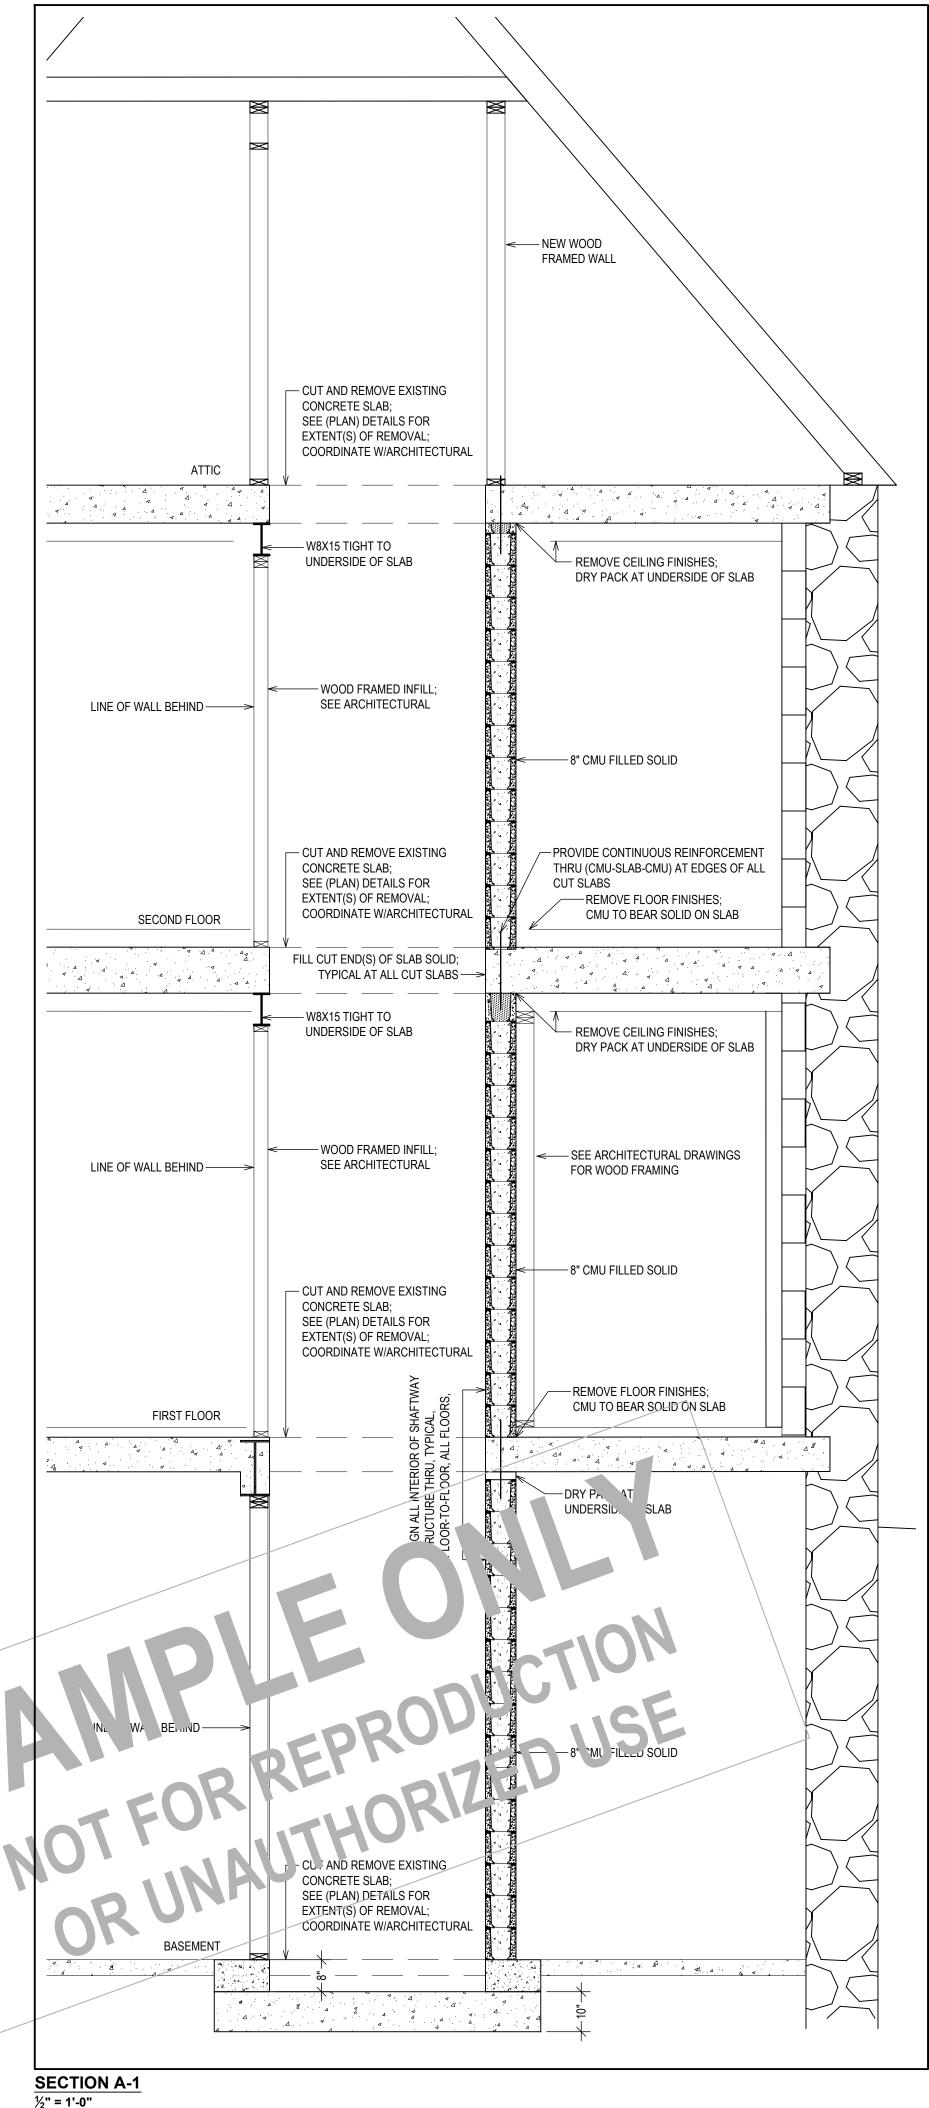



ARCHITECTURAI CONSULTANTS **ာ** င္ စ **⊆** ⋖ Ш OII v Design Code PROPERTY ADDRESS: **PURCHASE, NY 10577** (TOWN/VILLAGE OF HARRISON) S-B-L (TAX ID): CLIENT: TEL: *** EMAIL: *** 02.05.2024 FOR REVIEW 04.22.2024 **DESIGN CHANGE** 05.01.2024 **DESIGN CHANGE** 05.30.2024 **DESIGN CHANGE** 09.09.2024 **DESIGN CHANGE** PROJECT NAME: STRUCTURAL ALTERATION DRAWING NAME: **WORK AREA 1 ELEVATOR SHAFTWAY** DRAWING NUMBER: S-02.1 01.25.2024 **AS NOTED** THIS DRAWING IS VALID FOR CONSTRUCTION IF (AND ONLY IF) A PERMIT IS ISSUED, BASED ON THIS DRAWING, BY THE TOWN/VILLAGE OF HARRISON.

½" = 1'-0"

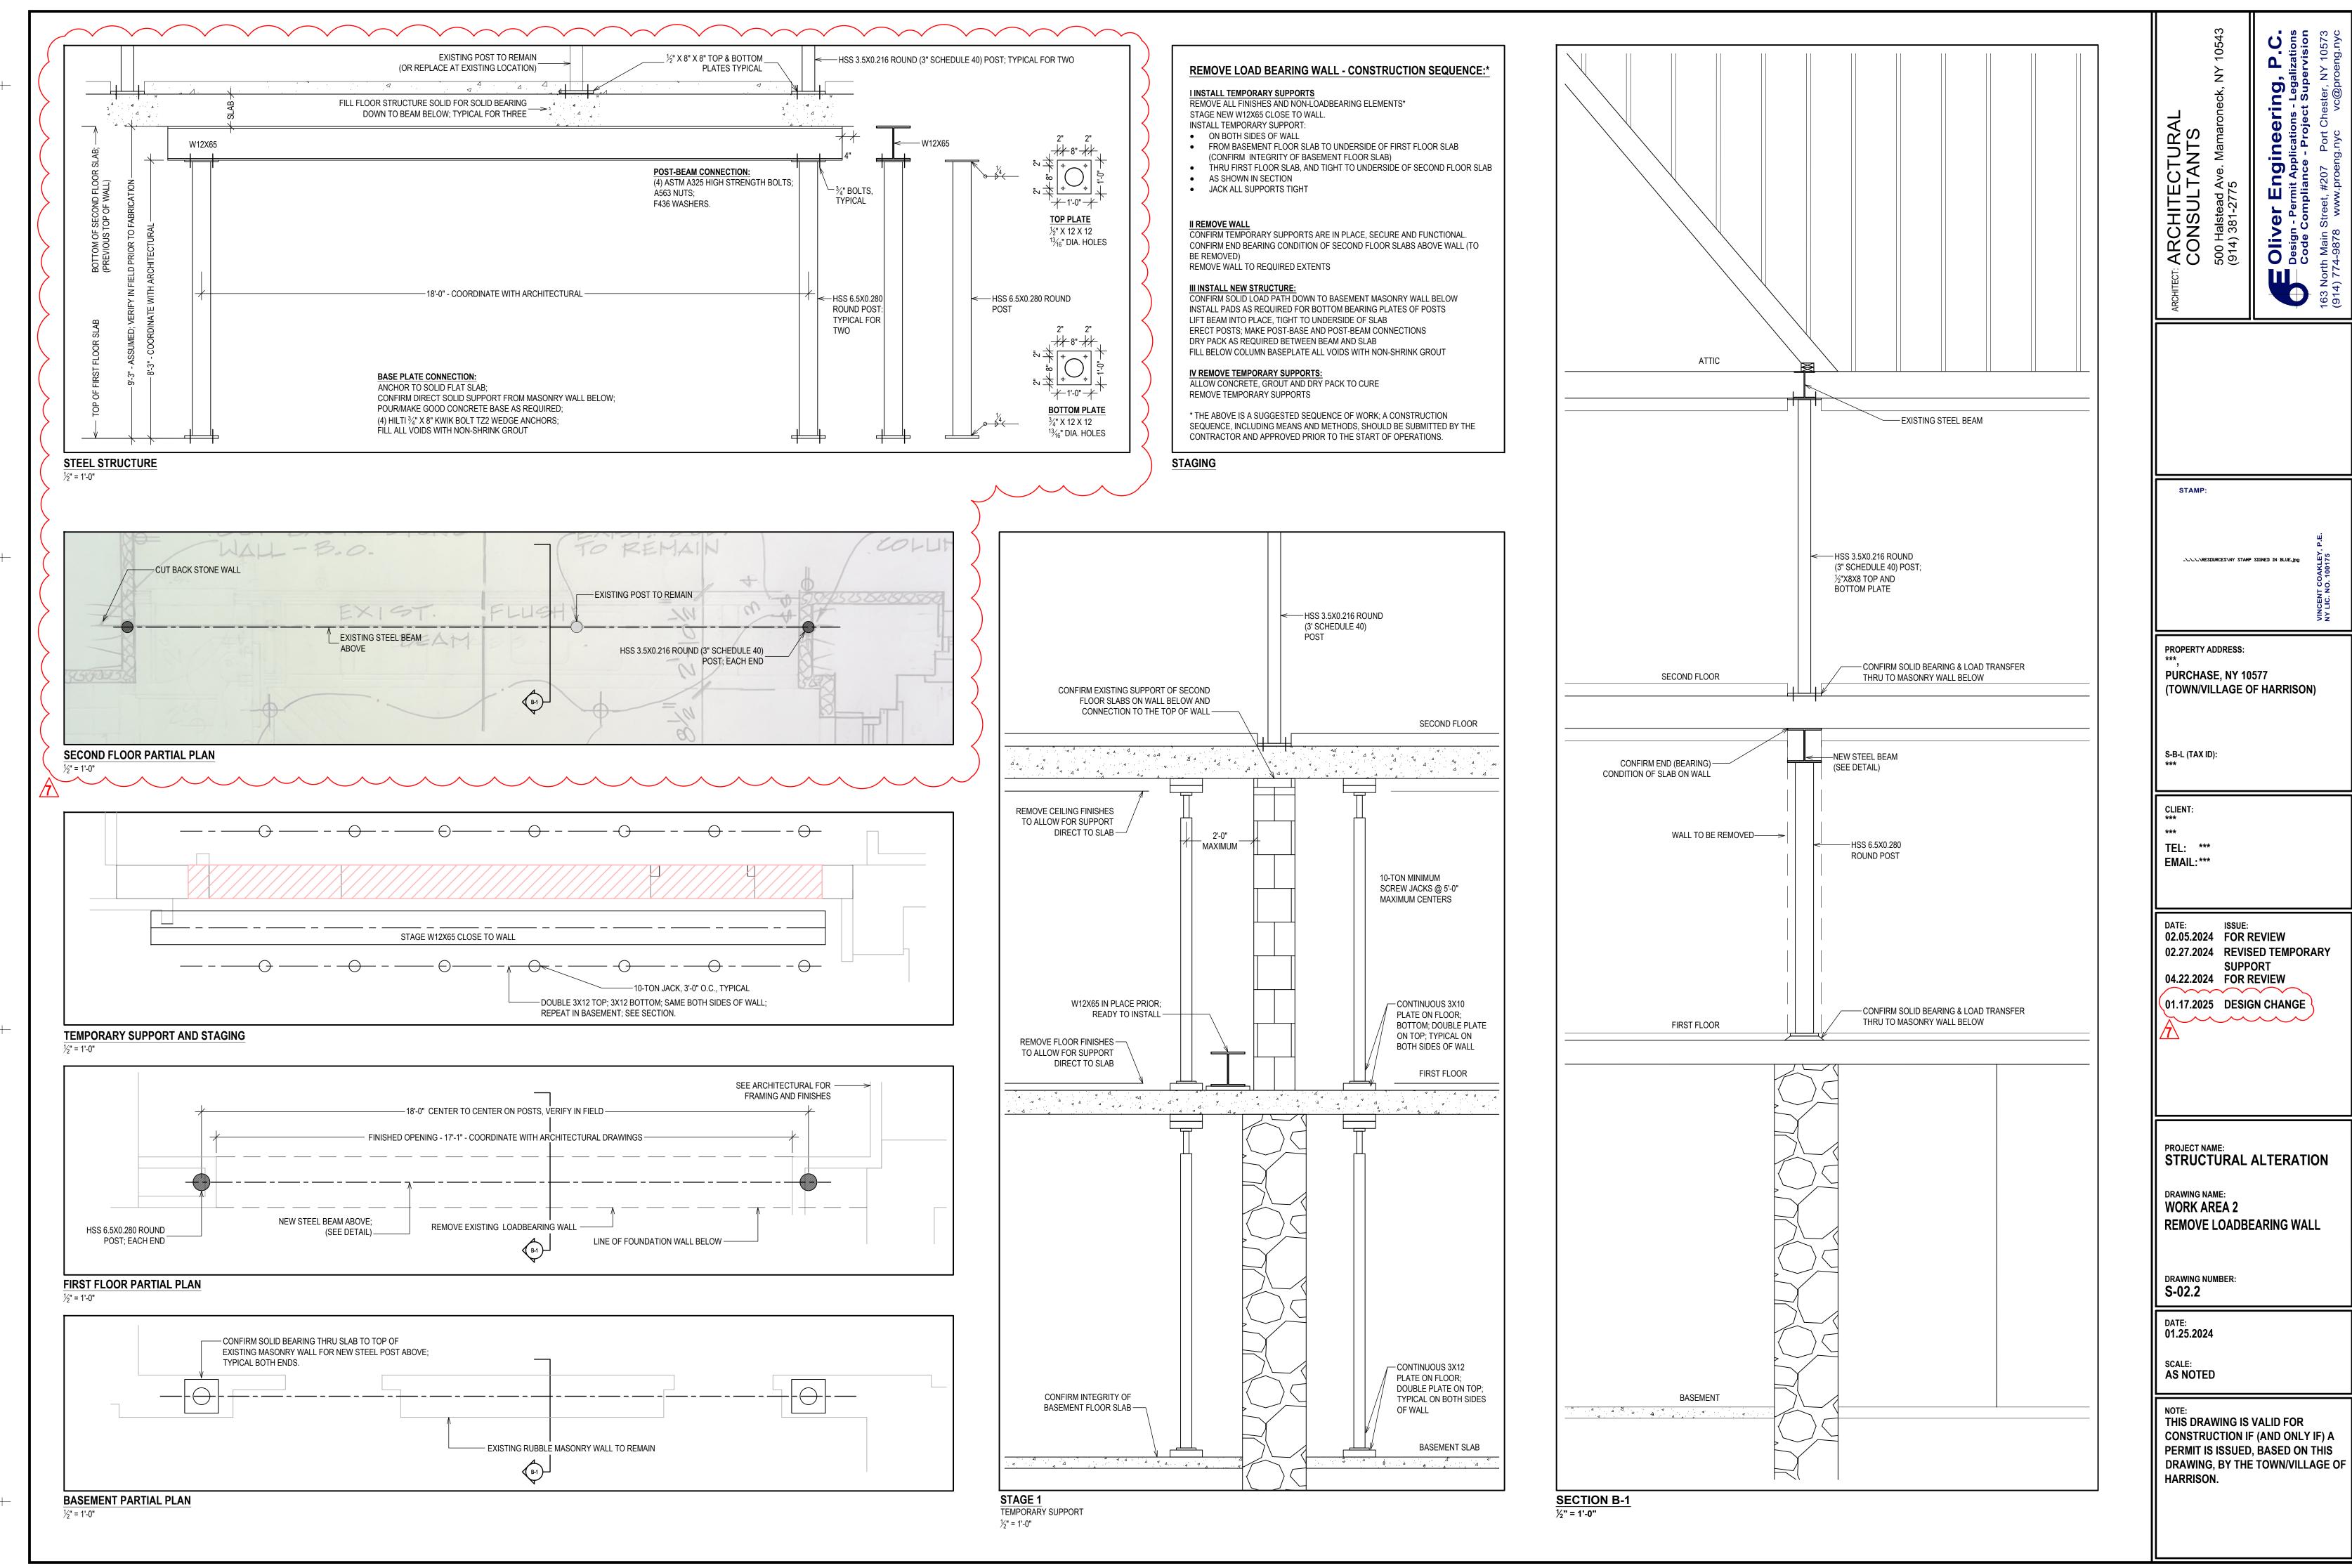


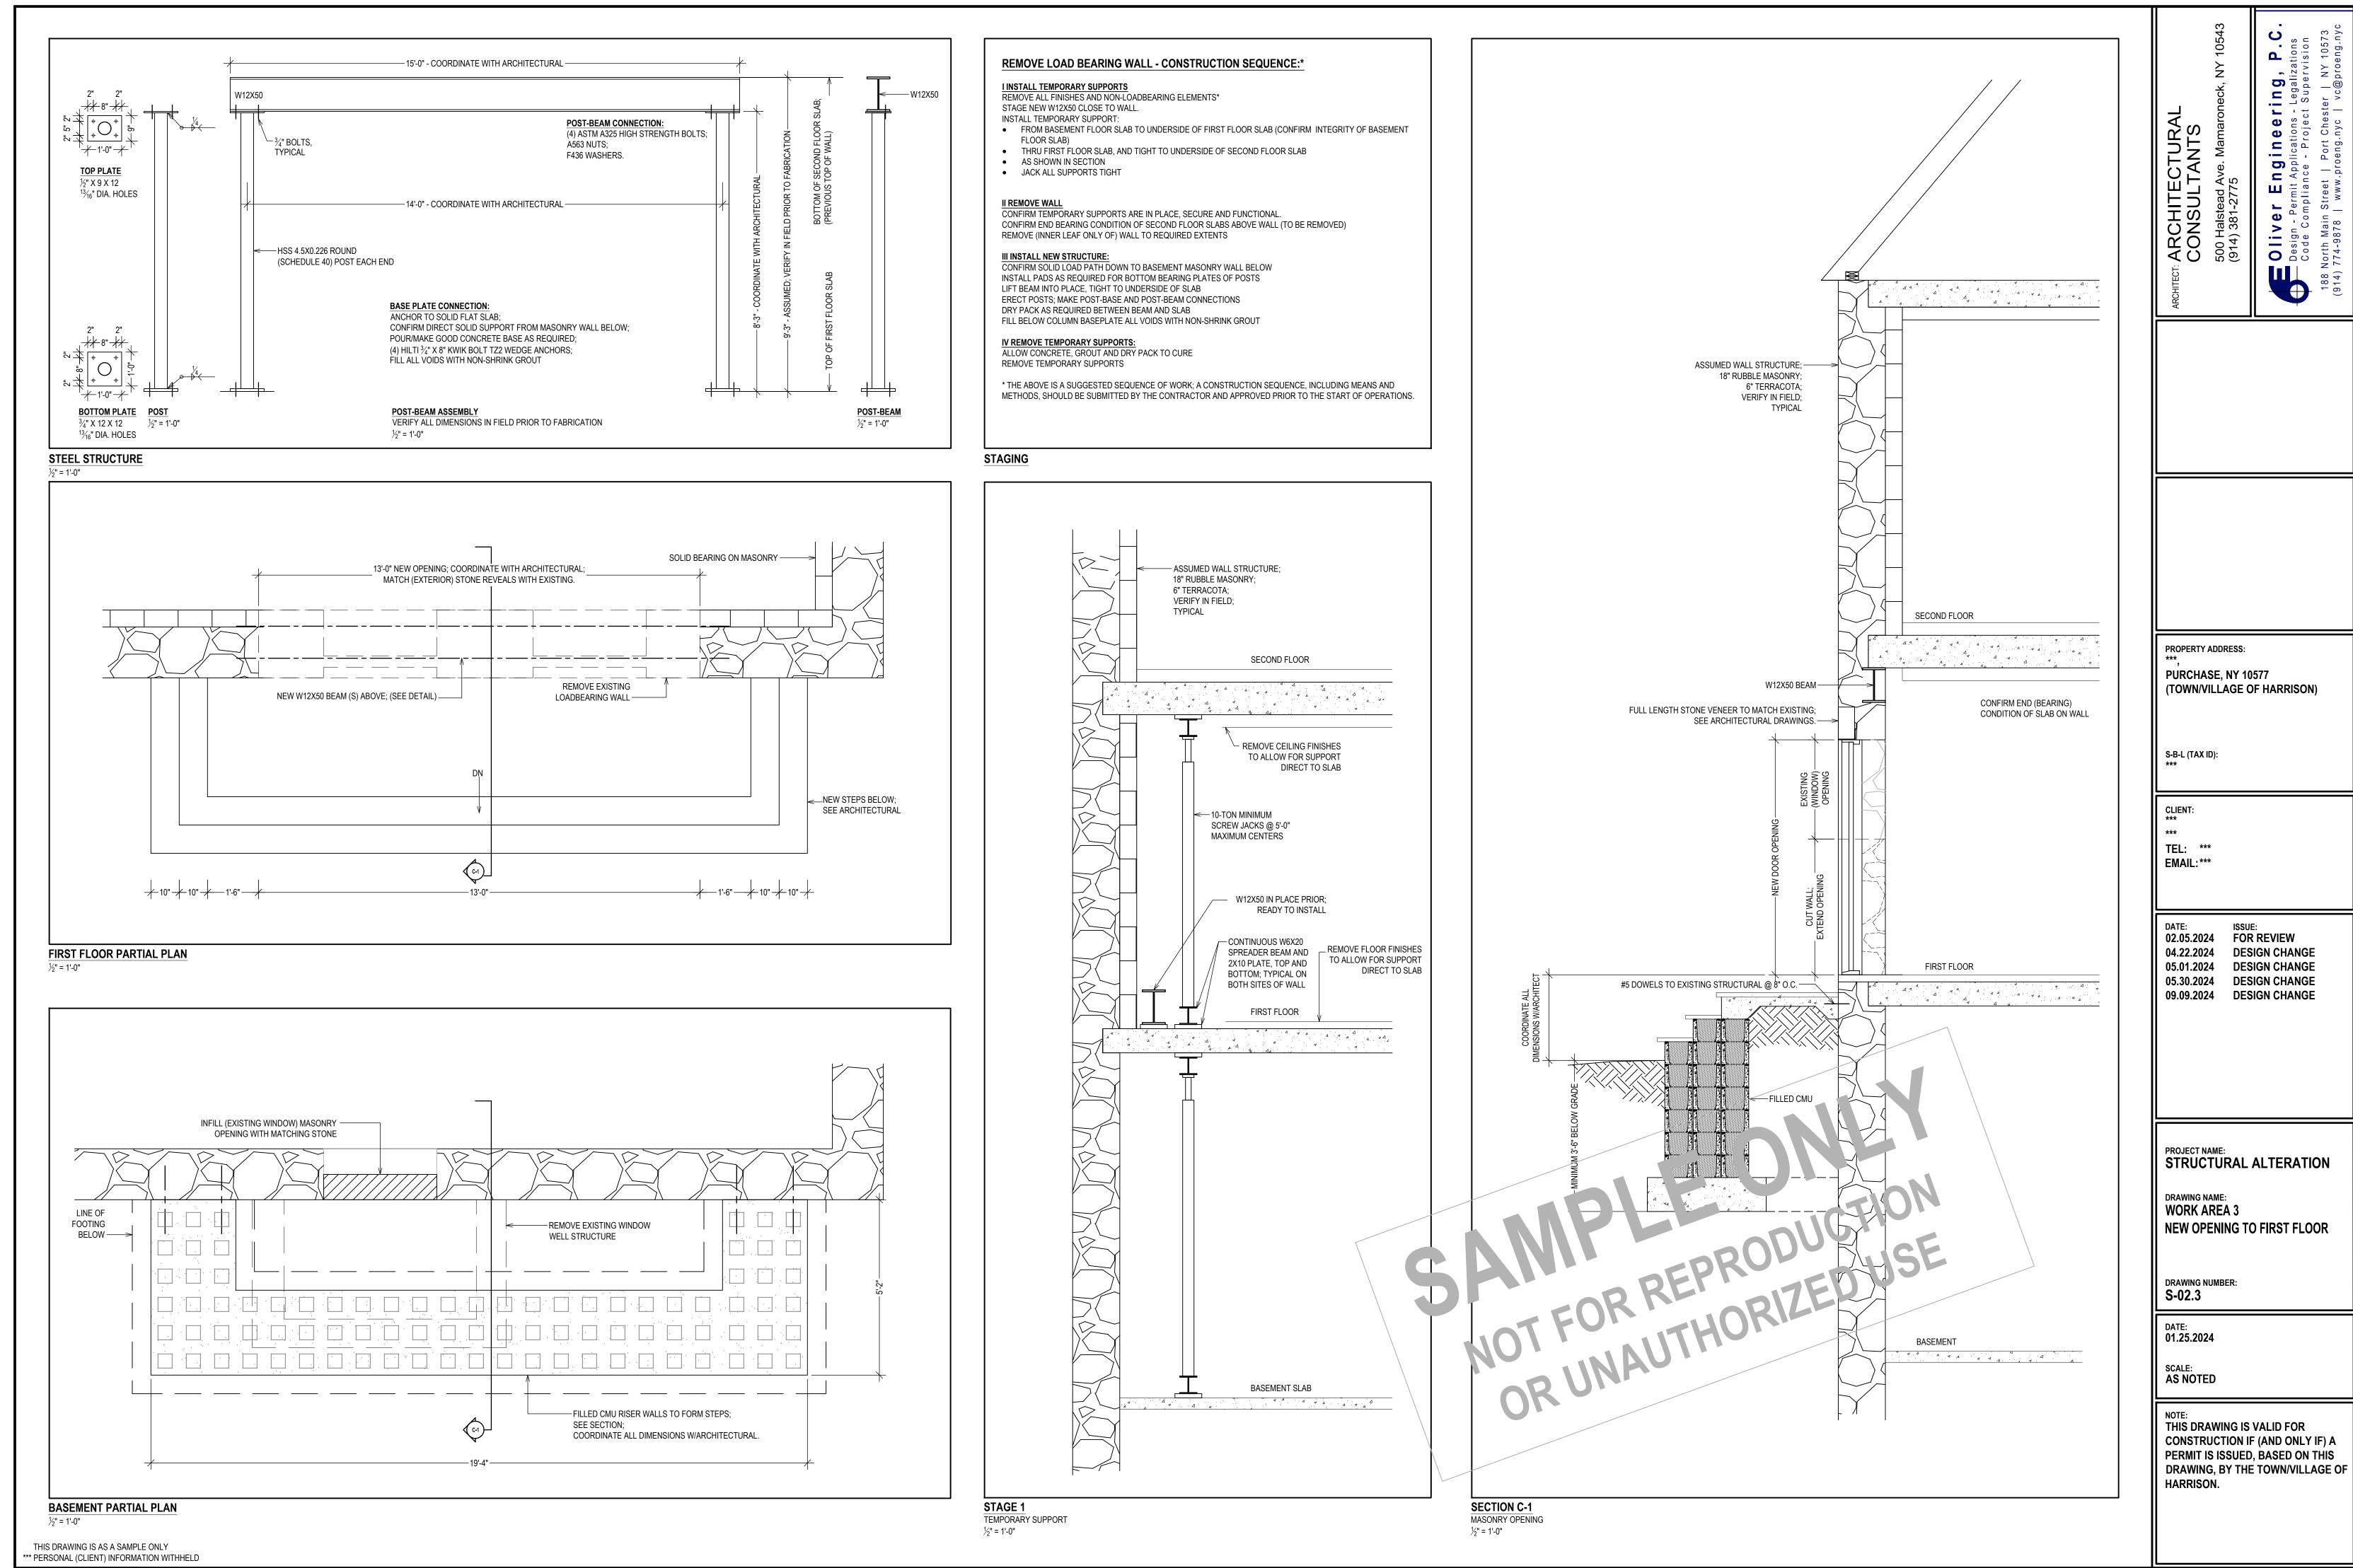


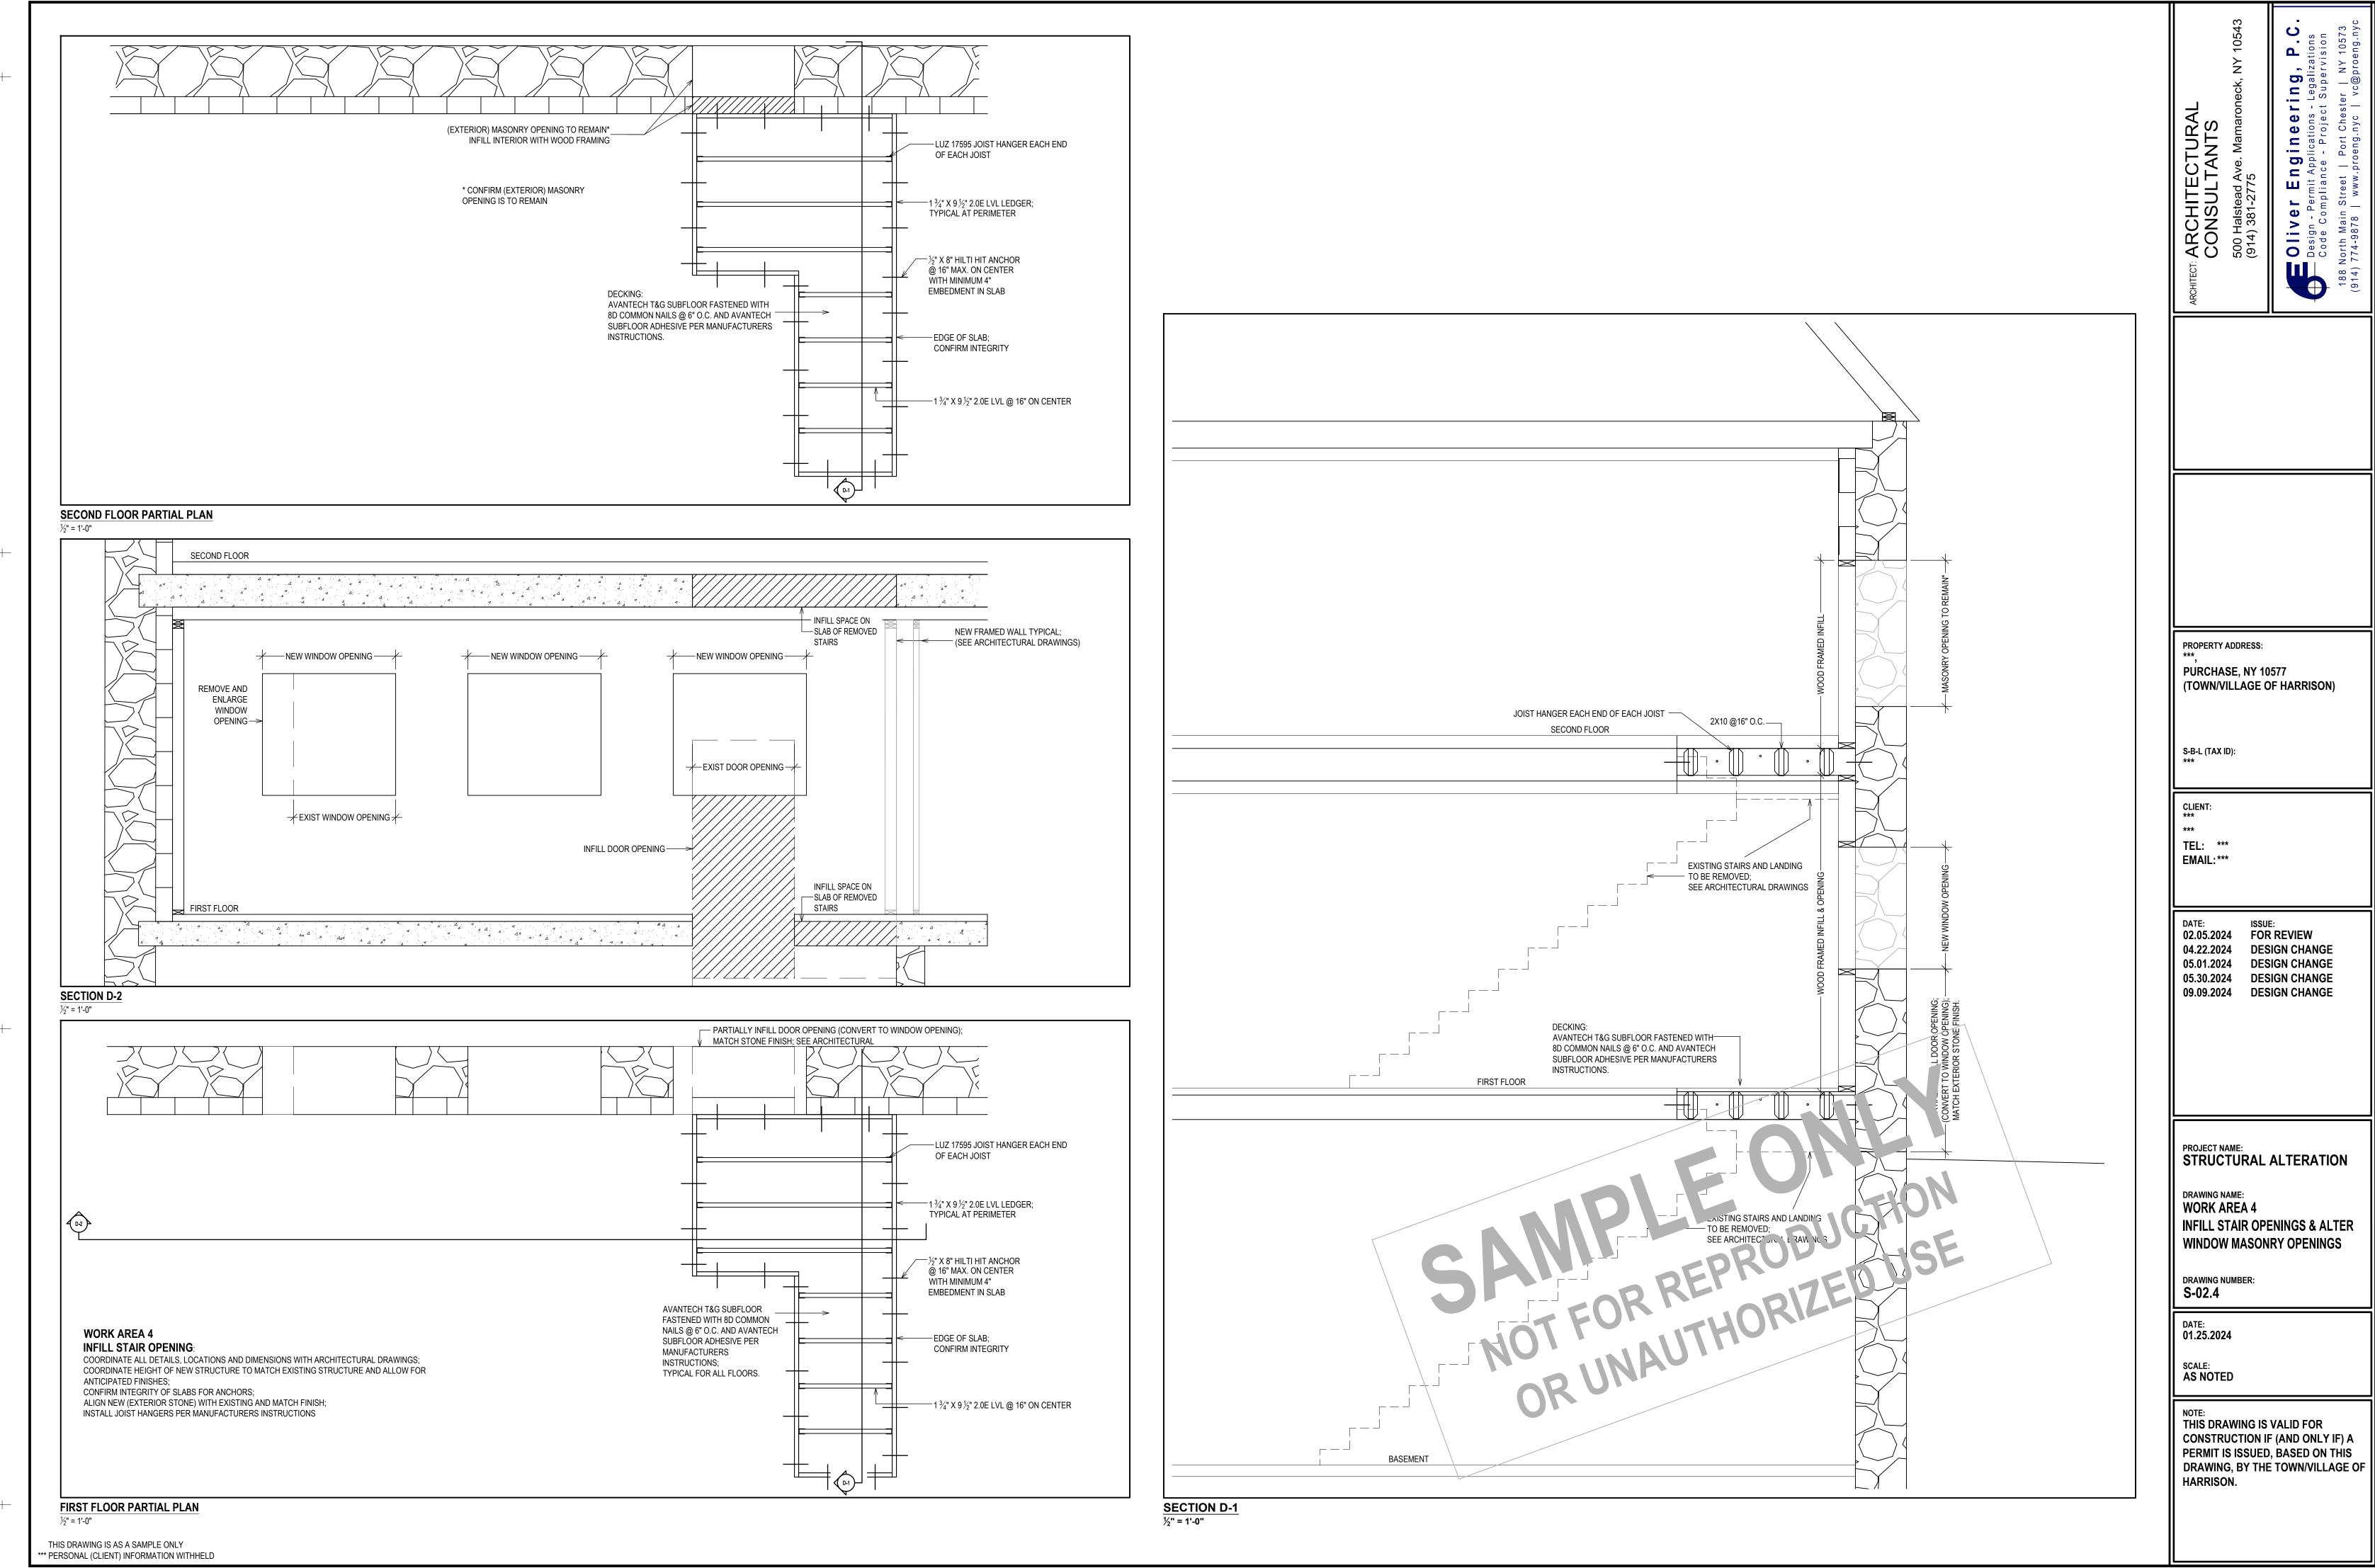

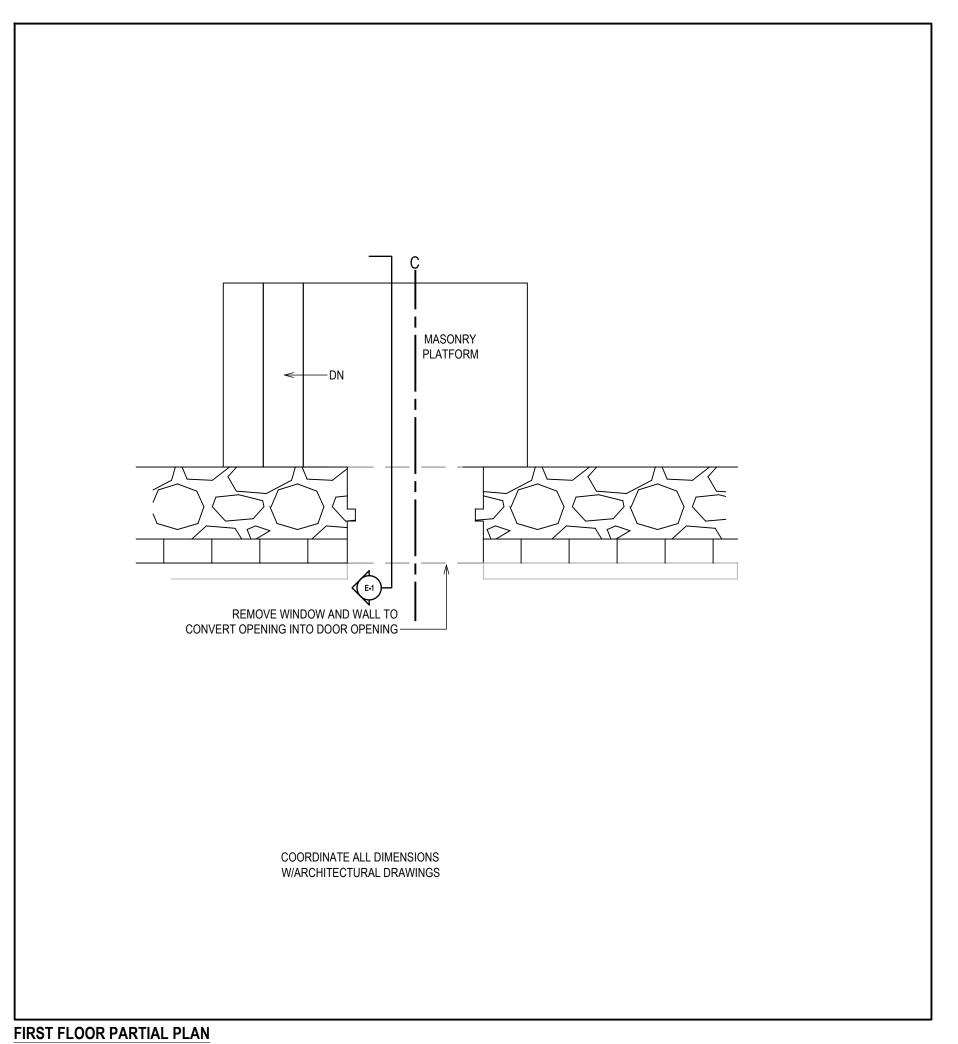

1/2" = 1'-0"

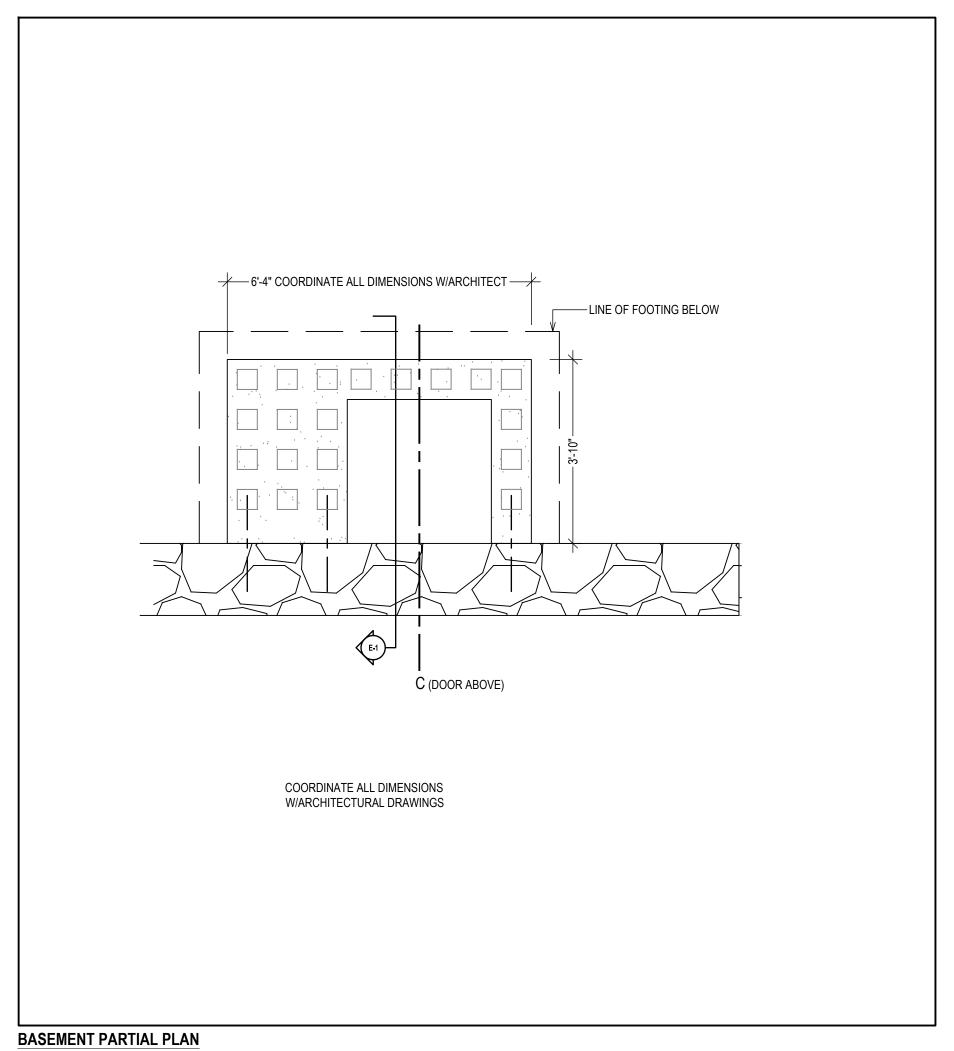

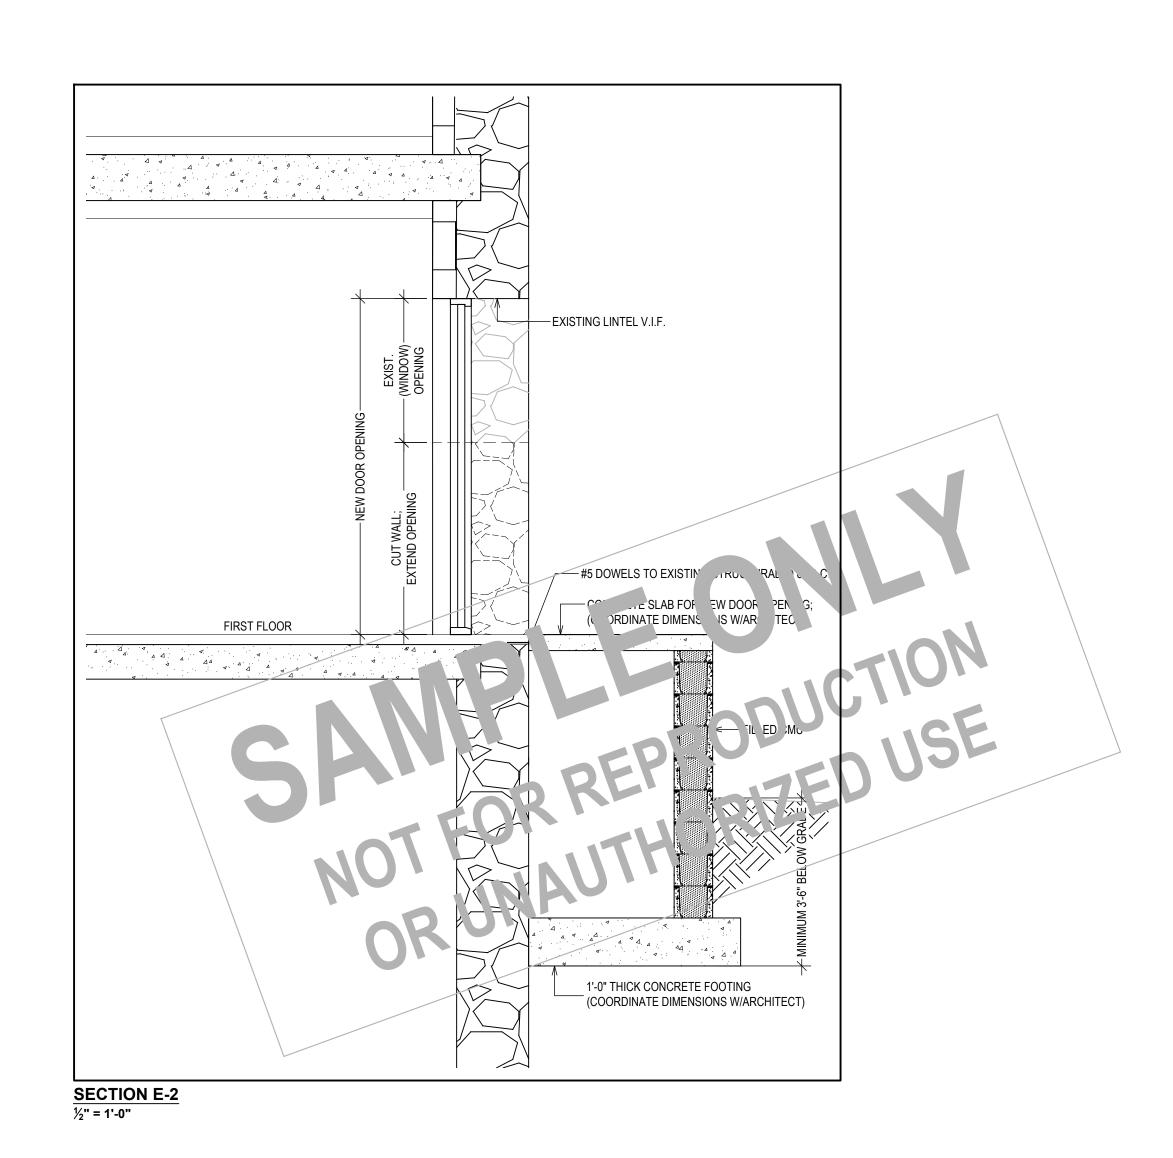



ARCHITECTURAL CONSULTANTS PROPERTY ADDRESS: *** PURCHASE, NY 10577 (TOWN/VILLAGE OF HARRISON) S-B-L (TAX ID): CLIENT: TEL: *** EMAIL:*** DATE: ISSUE: **02.05.2024 FOR REVIEW** 04.22.2024 **DESIGN CHANGE** 05.01.2024 DESIGN CHANGE 05.30.2024 DESIGN CHANGE 09.09.2024 DESIGN CHANGE PROJECT NAME:
STRUCTURAL ALTERATION DRAWING NAME: WORK AREA 5 NEW OPENING TO FIRST FLOOR DRAWING NUMBER: S-02.5 01.25.2024 SCALE: AS NOTED THIS DRAWING IS VALID FOR


THIS DRAWING IS AS A SAMPLE ONLY
*** PERSONAL (CLIENT) INFORMATION WITHHELD

CONSTRUCTION IF (AND ONLY IF) A
PERMIT IS ISSUED, BASED ON THIS
DRAWING, BY THE TOWN/VILLAGE OF


HARRISON.

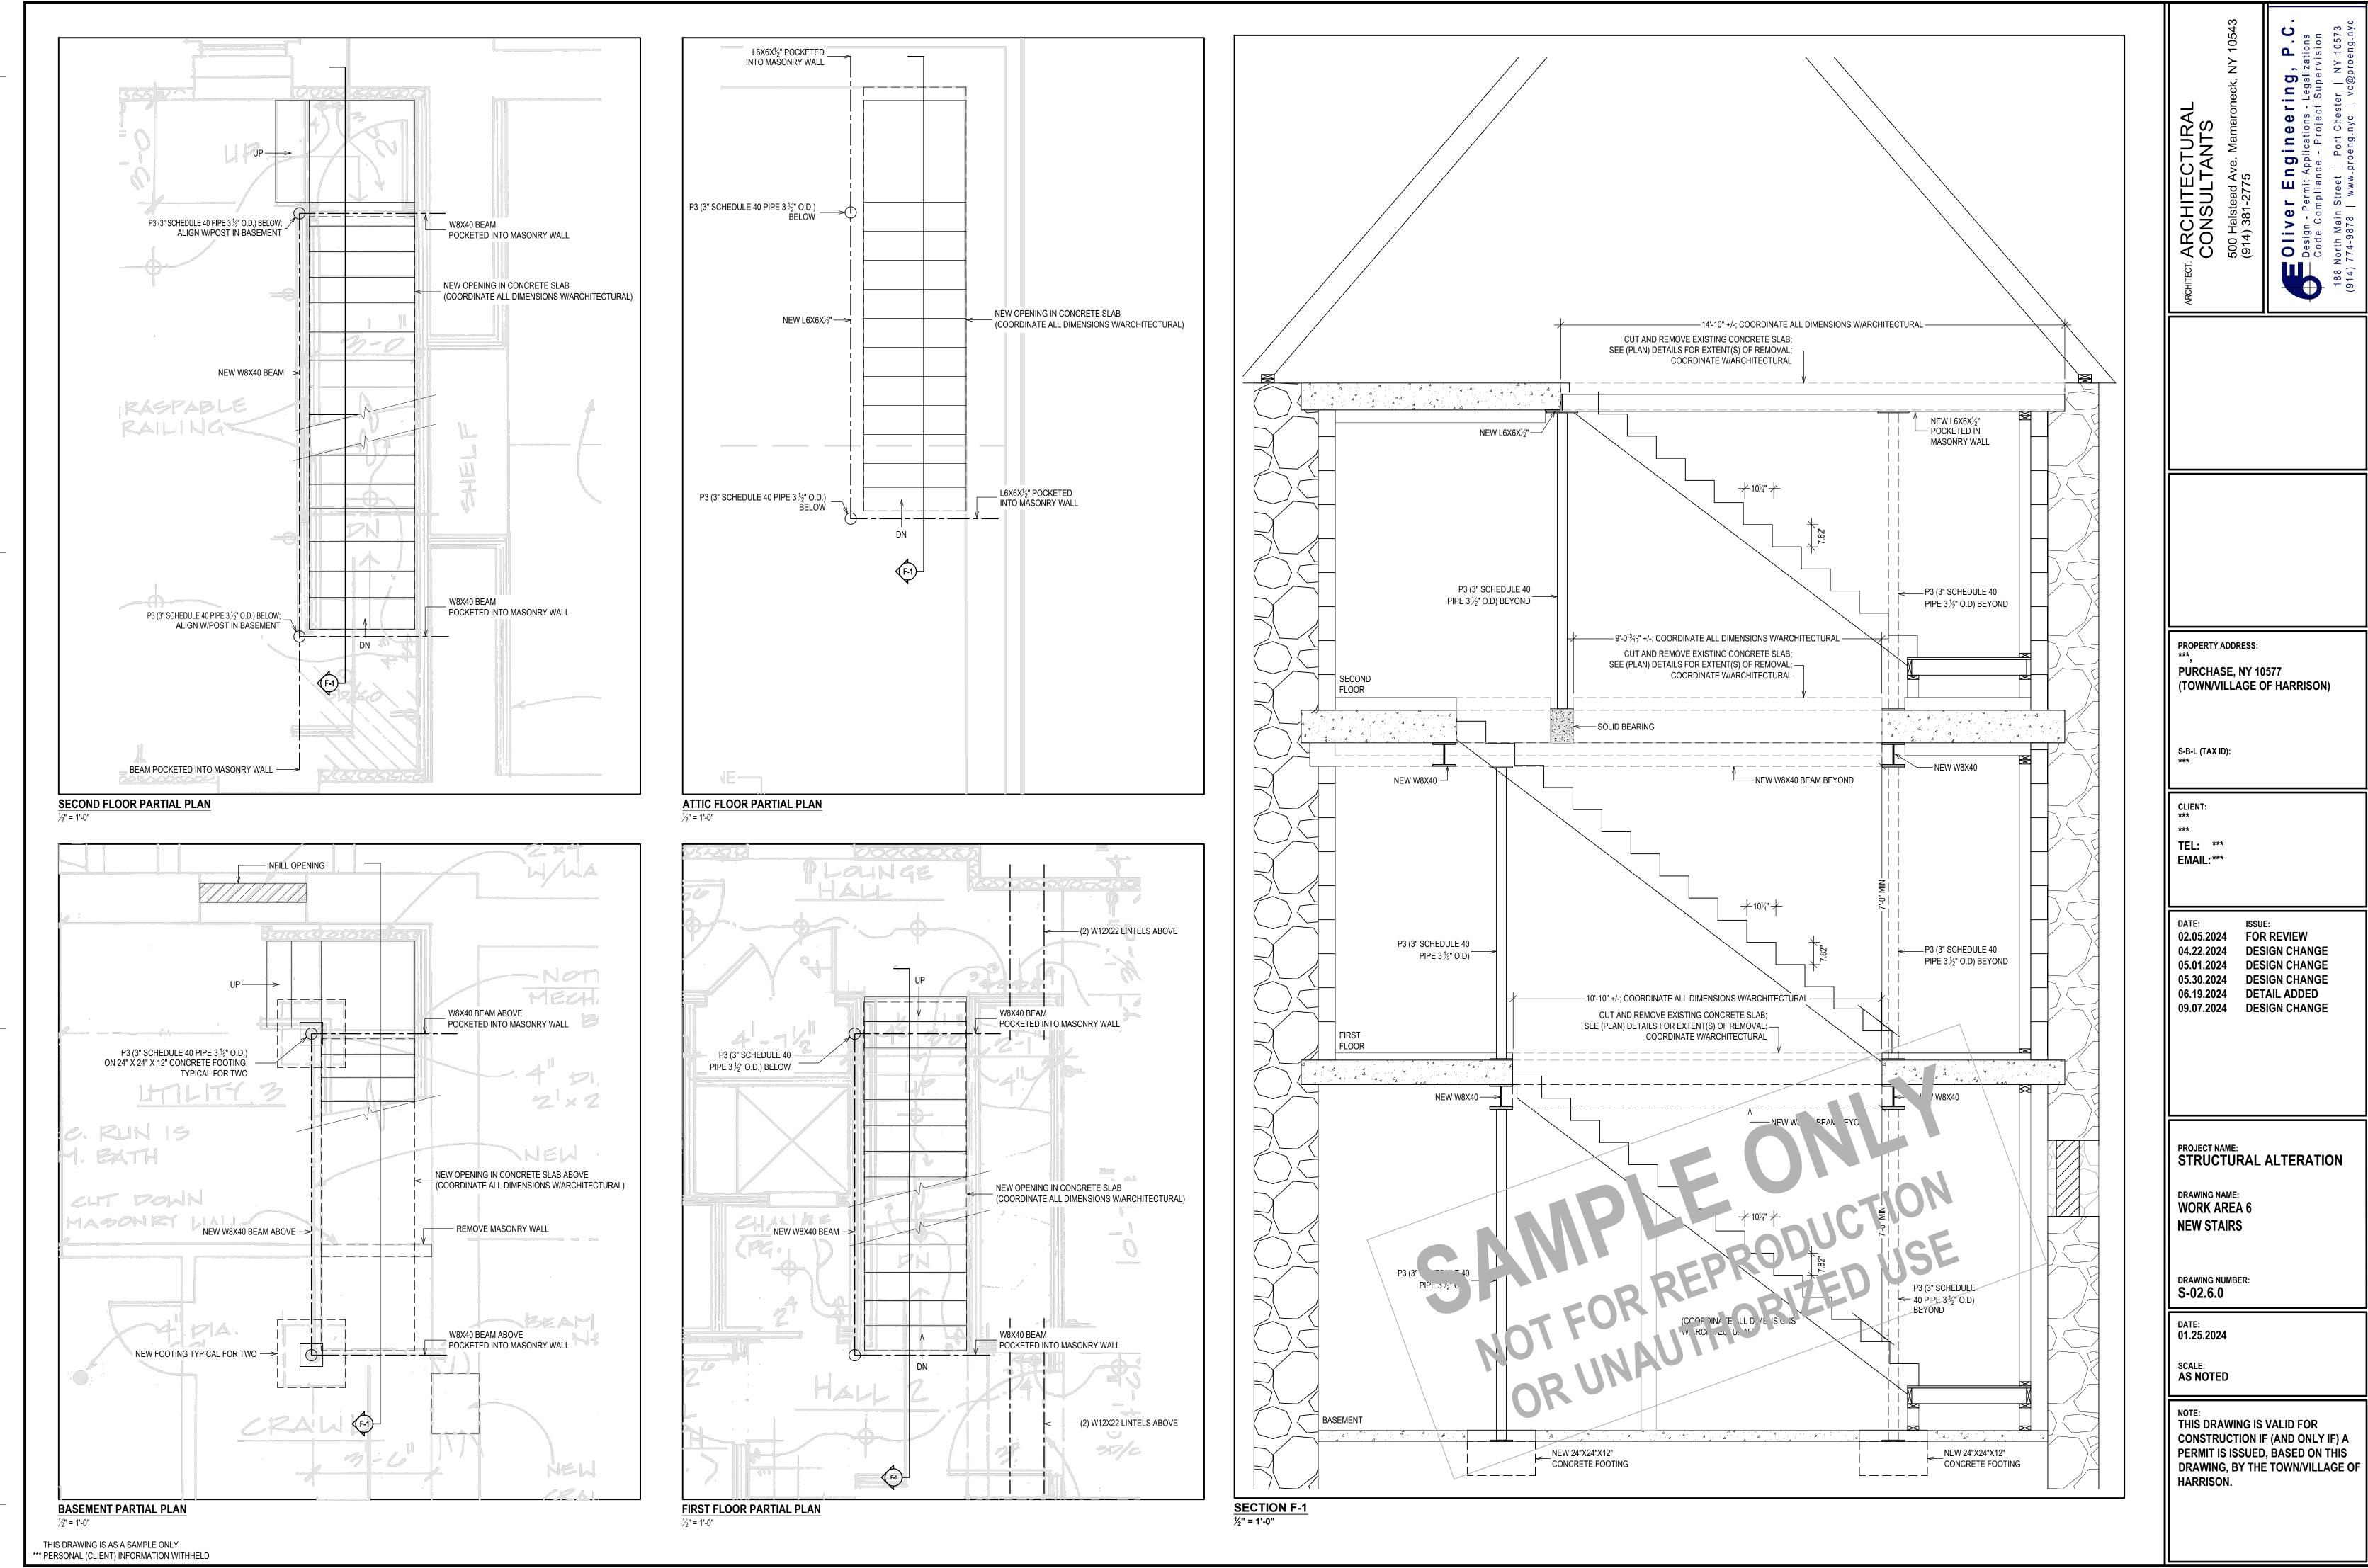

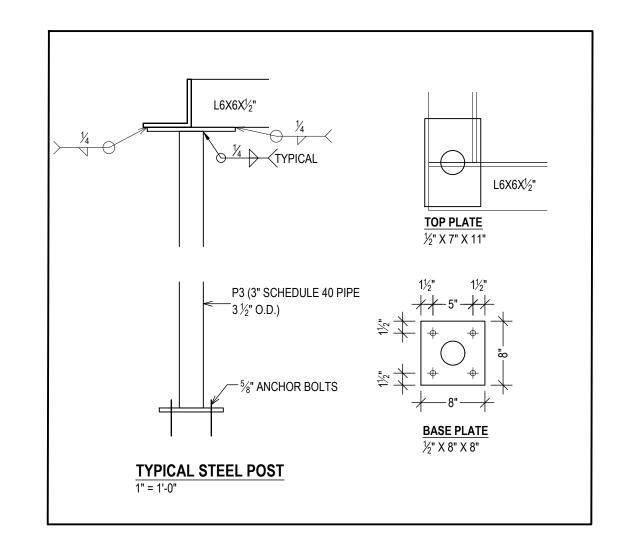

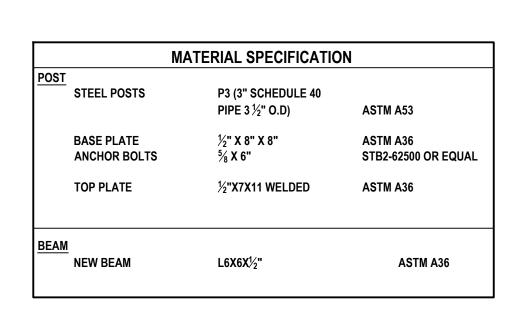


SECOND FLOOR POST(S)

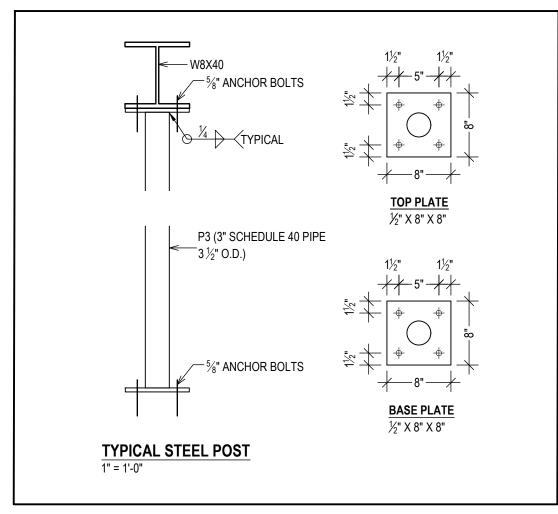

	N	MATERIAL SPECIFICATION	
<u>POST</u>		DO (011 DO 11 DO 1	
	STEEL POSTS	P3 (3" SCHEDULE 40	
		PIPE 3 ½" O.D)	ASTM A53
	BASE PLATE	½" X 8" X 8"	ASTM A36
	ANCHOR BOLTS	5∕ ₈ X 6"	STB2-62500 OR EQUAL
	TOP PLATE	½" X 8" X 8"	ASTM A36
	ANCHOR BOLTS	5∕ ₈ X 6"	STB2-62500 OR EQUAL
I BEAM			
	NEW BEAM	W8X40	ASTM A992
I			

FIRST FLOOR POST(S) 1" = 1'-0"

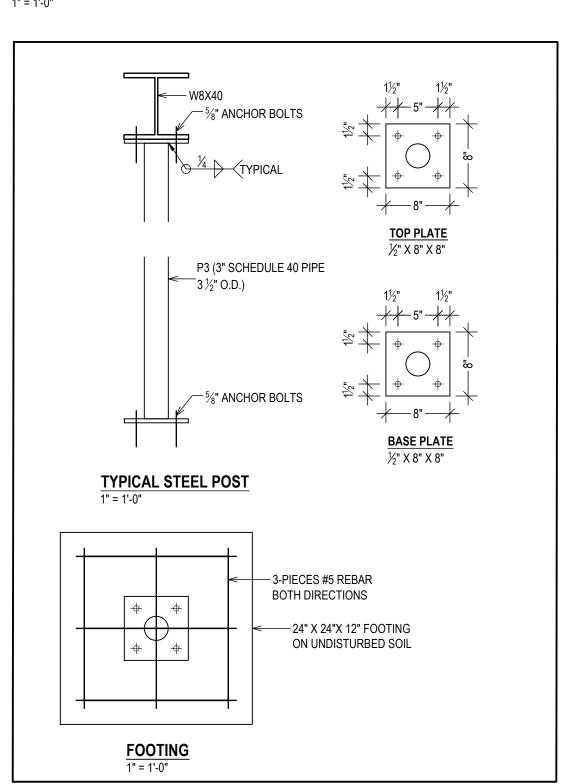

M	ATERIAL SPECIFICATION)N
FOOTING		
CONCRETE	4,000 PSI @ 28 DAYS PE	R ACI 318
REBAR	#5 DEFORMED BAR	ASTM A615 GRADE 60
POST		
STEEL POSTS	P3 (3" SCHEDULE 40	
	PIPE 3 ½" O.D)	ASTM A53
BASE PLATE	½" X 8" X 8"	ASTM A36
ANCHOR BOLTS	5∕ ₈ X 6"	STB2-62500 OR EQUAL
TOP PLATE	½"" X 8" X 8"	ASTM A36
ANCHOR BOLTS	5⁄8 X 6"	STB2-62500 OR EQUAL
BEAM		
NEW BEAM	W8X40	ASTM A992

N	IATERIAL SPECIFICATION	N
FOOTING		
CONCRETE	4,000 PSI @ 28 DAYS PE	R ACI 318
REBAR	#5 DEFORMED BAR	ASTM A615 GRADE 60
POST		
STEEL POSTS	P3 (3" SCHEDULE 40	
	PIPE 3 ½" O.D)	ASTM A53
BASE PLATE	½" X 8" X 8"	ASTM A36
ANCHOR BOLTS	5∕ ₈ X 6"	STB2-62500 OR EQUAL
TOP PLATE	½"" X 8" X 8"	ASTM A36
ANCHOR BOLTS	5∕8 X 6"	STB2-62500 OR EQUAL
BEAM		
NEW BEAM	W8X40	ASTM A992

------ STRUCTURAL FLOOR - SLAB ATTIC FLOOR CUT SLAB L6X6X¹/₂" $\frac{1}{2}$ "X7"X11" TOP PLATE — STRUCTURAL FLOOR - SLAB ½"X8X8 BASE PLATE — FLOOR FINISH -FLOOR FINISH CUT SLAB → <--CUT SLAB SOLID BEARING — FILL SOLID — TYPICAL AT TOP & BOTTOM OF ALL POSTS $\frac{1}{2}$ "X8X8 TOP PLATE — STRUCTURAL FLOOR - SLAB $\frac{1}{2}$ "X8X8 BASE PLATE — FLOOR FINISH FIRST FLOOR FIRST FLOOR ← CUT SLAB/FINISH, FILL EDGE FILL SOLID -> CEILING FINISH $\frac{1}{2}$ "X8X8 TOP PLATE — CEILING FINISH-½"X8X8 BASE PLATE — FILL SOLID ----ANCHOR BOLTS -**BASEMENT** NEW FOUNDATION (SEE BASEMENTS POSTS) CONFECTION DETAILS
1" = 1'-0"

NOTE: THIS DRAWING IS VALID FOR CONSTRUCTION IF (AND ONLY IF) A PERMIT IS ISSUED, BASED ON THIS DRAWING, BY THE TOWN/VILLAGE OF

1" = 1'-0"

BASEMENT POST(S)

ARCHITECTURAL CONSULTANTS

PROPERTY ADDRESS:

S-B-L (TAX ID):

CLIENT:

TEL: *** EMAIL:***

PURCHASE, NY 10577

(TOWN/VILLAGE OF HARRISON)

09.09.2024 DESIGN CHANGE

PROJECT NAME:
STRUCTURAL ALTERATION

DRAWING NAME: WORK AREA 6.1

DRAWING NUMBER:


DETAILS


S-02.6.1

01.25.2024

SCALE: AS NOTED

HARRISON.

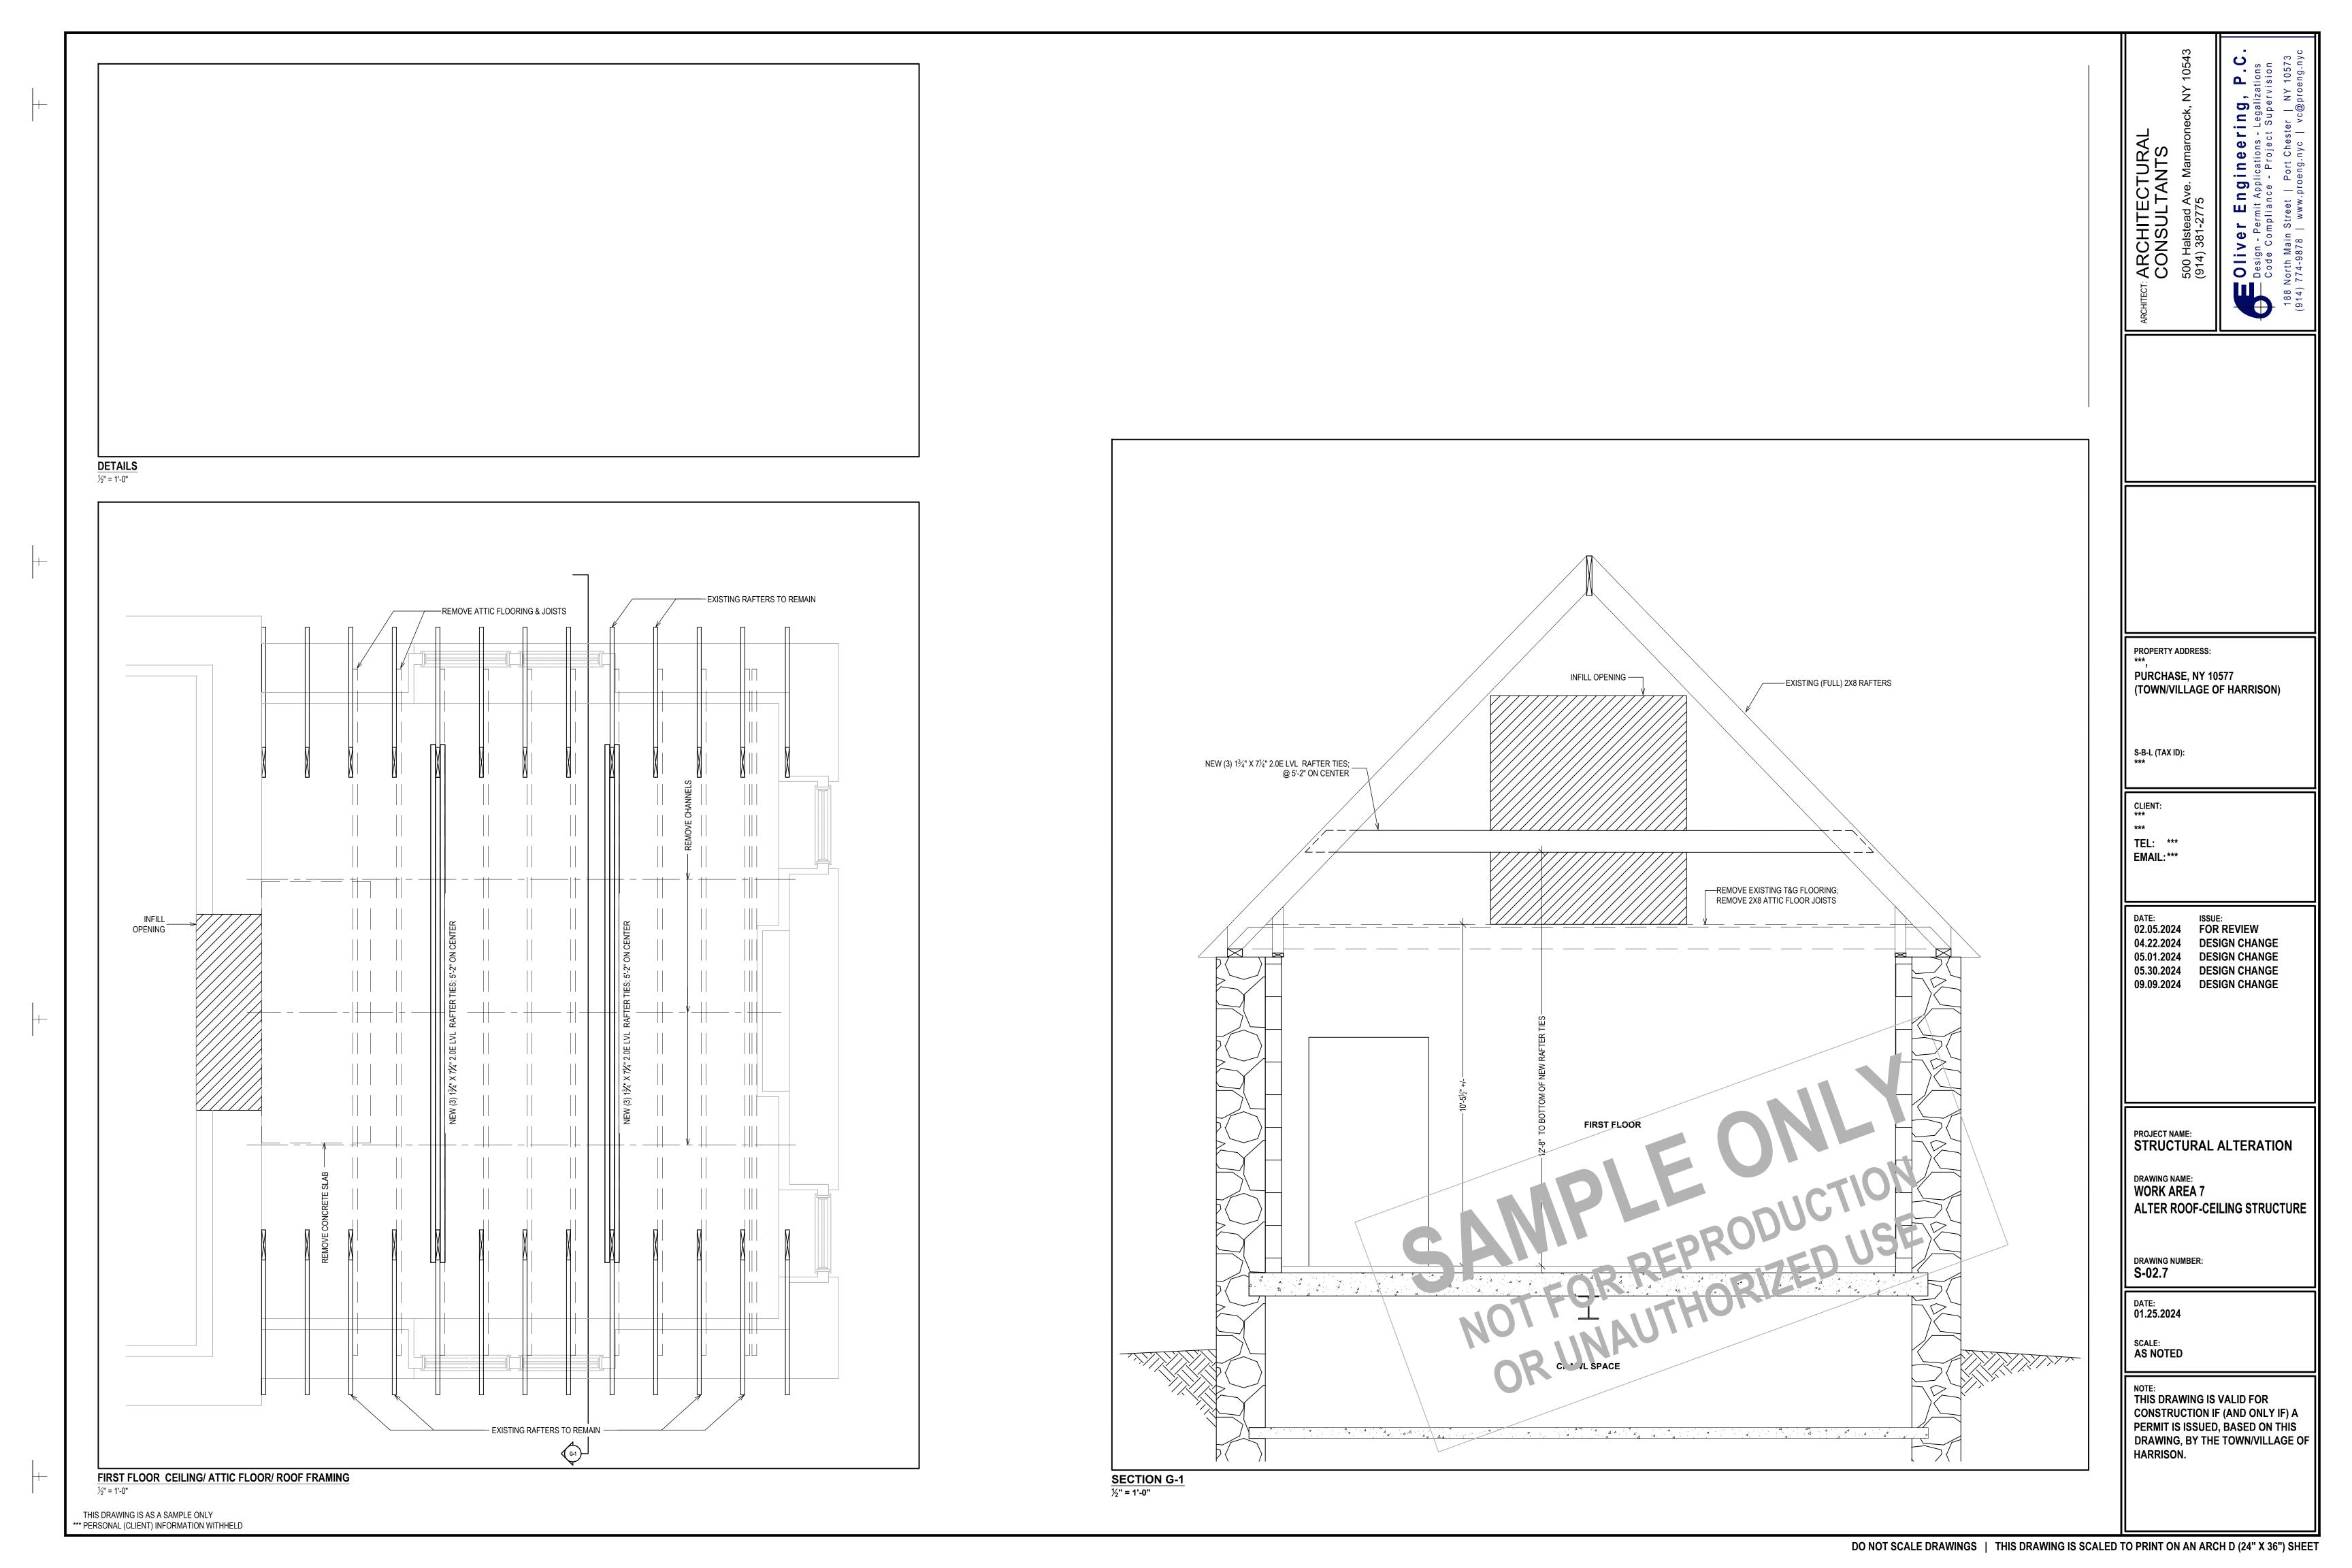

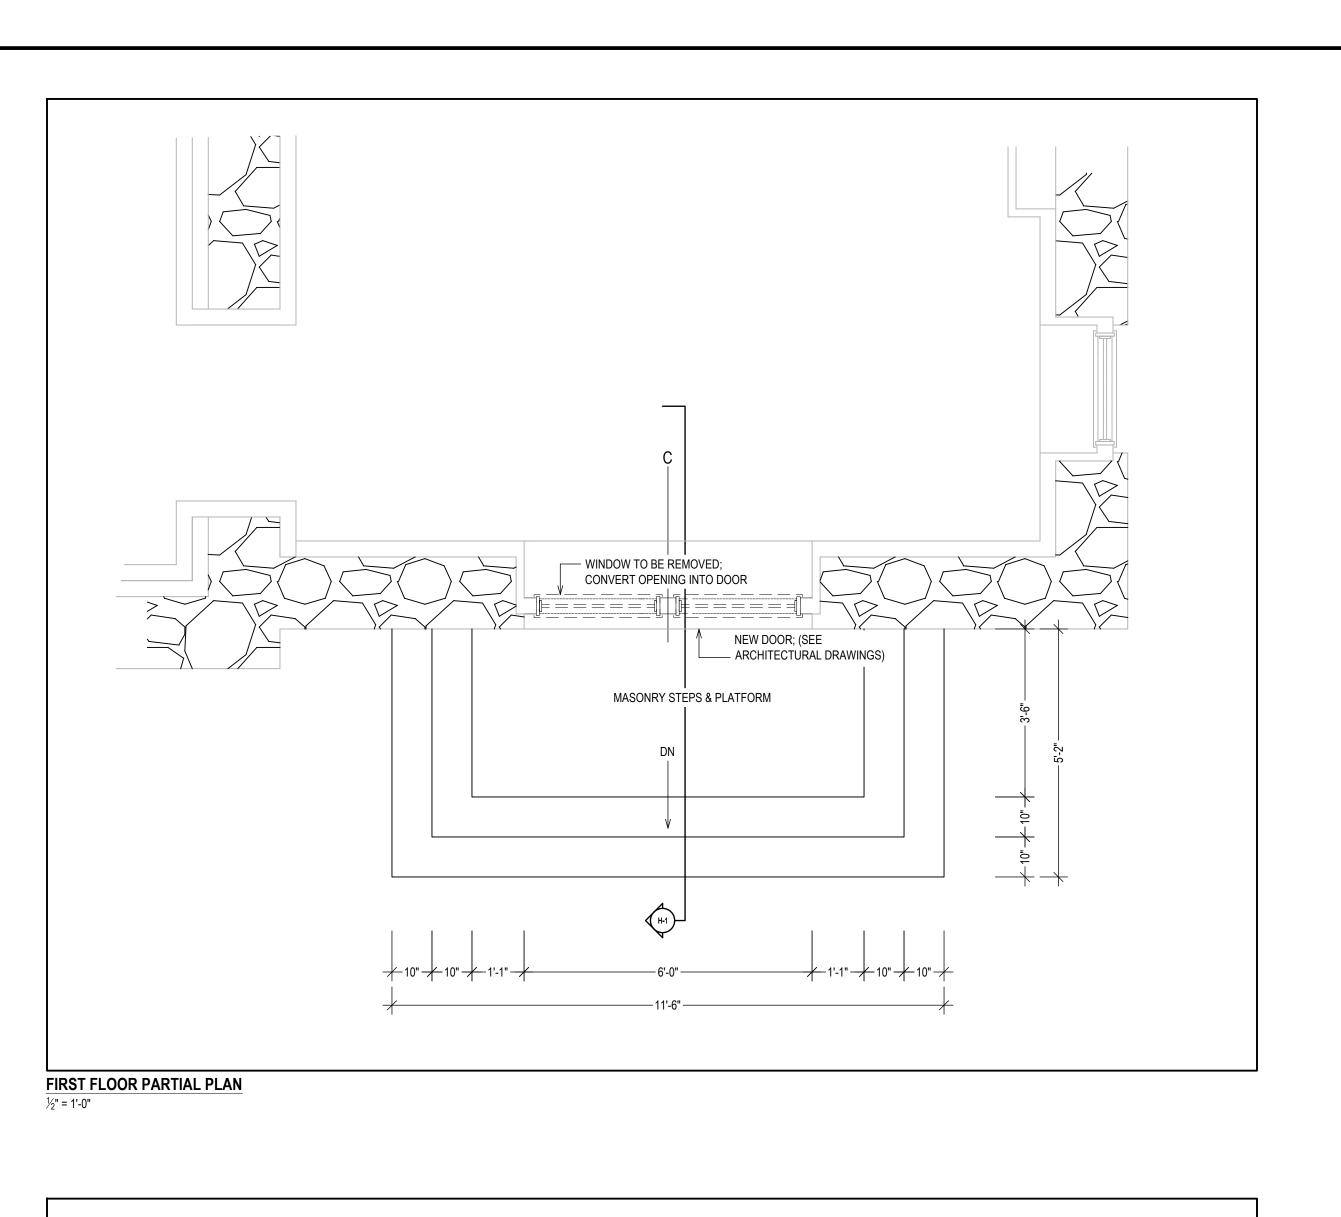


CIRAMA SPACE

CIRAMA SPACE

FILED CAN RISER WALLS
TO CROM STEERS
SECTION
WAS RIFERED SPACE
WAS RISER WALLS
SECTION
WAS RIFERED SPACE
WAS RIFFERED SPACE
WAS RIFERED SPACE
WAS RIFFERED SPAC

FOUNDATION PARTIAL PLAN

THIS DRAWING IS AS A SAMPLE ONLY
** PERSONAL (CLIENT) INFORMATION WITHHELD

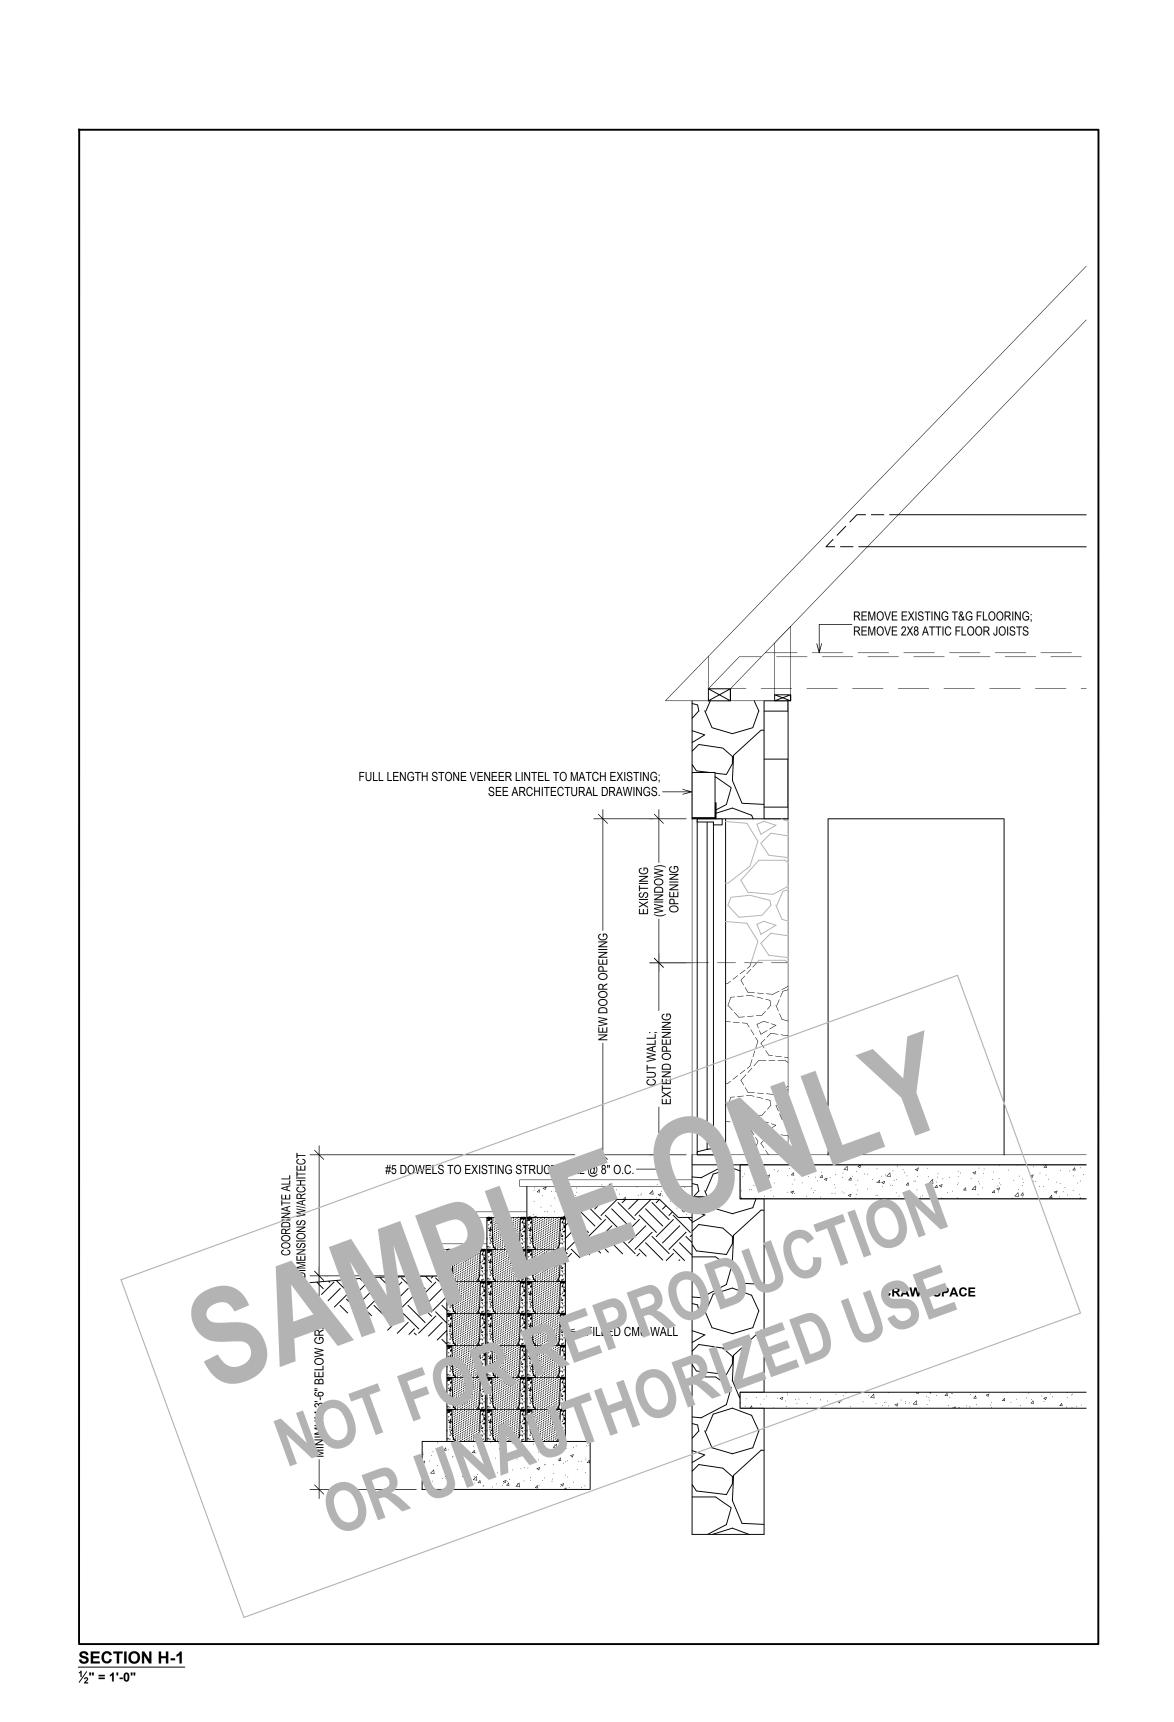

PROPERTY ADDRESS: **PURCHASE, NY 10577** (TOWN/VILLAGE OF HARRISON) S-B-L (TAX ID): CLIENT: TEL: *** EMAIL: *** DATE: ISSUE: FOR REVIEW 04.22.2024 **DESIGN CHANGE** 05.01.2024 DESIGN CHANGE 05.30.2024 DESIGN CHANGE 09.09.2024 DESIGN CHANGE PROJECT NAME: STRUCTURAL ALTERATION DRAWING NAME: WORK AREA 8 NEW OPENING TO FIRST FLOOR DRAWING NUMBER: S-02.8 01.25.2024 SCALE: AS NOTED THIS DRAWING IS VALID FOR

CONSTRUCTION IF (AND ONLY IF) A

PERMIT IS ISSUED, BASED ON THIS DRAWING, BY THE TOWN/VILLAGE OF

HARRISON.

